owners:

PIN # 9787-15-3532 Janet Allen 620 Sugarberry Road Chapel Hill, NC 27516

PIN # 9787-15-4615 James Paliouras PO Box 715 Chapel Hill, NC 27514

PIN # 9787-15-4766 Timothy & Ann Holleman 124 Cobblestone Drive Chapel Hill, NC 27516

PIN # 9787-15-6928 Redwing Land, LLC 400 Market Street, Suite 115 Chapel Hill, NC 27615 (919) 933-4422

PIN # 9787-05-9854 (portion) Southern Village Apartments, LLC 701 Green Valley Road Greensboro, NC 27408

landscape architect:
Tony M. Tate Landscape Architecture P.A.
5011 Southpark Drive Suite 200
Durham, North Carolina 27713
(919) 484-8880
(919) 484-8881
tony@tmtla.com

consulting engineers: B&F Consulting Engineers 2805 Tobermory Lane Raleigh, NC 27606 (919) 618-0180 rbriggs@nc.rr.com


architects: **RBA Group** 1414-A S. Tryon Street Charlotte, NC 28203 (704)344-9098 sfinch@therbagroup.com

Concept Plan Submittal 08/15/12 SUP/Rezoning Submittal 12/12/12

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SITE DATA


9787-15-6928 PIN 9787-15-3532 9787-05-9854 a portion 9787-15-4615 9787-15-4766

EXISTING ZONING R-5-C PROPOSED ZONING **MU-V ARTERIAL EXISTING USE** SINGLE FAMILY RES. MULTI FAMILY RES. SITE AREA **3.48 ACRES** PROPOSED USE 115 UNIT HOTEL 68 UNIT APARTMENT or OFFICE PARKING REQUIRED HOTEL 104 SPACES 72 SPACES M-F RES. TOTAL 176 SPACES BICYCLE PARKING REQ'D. 25 SPACES BICYCLE PARKING PROVIDED 25 SPACES PARKING PROVIDED 181 SPACES **EXISTING PARKING AVAILABLE 76 SPACES** TOTAL PARKING PROVIDED 240 SPACES SETBACKS (MUV-ARTERIAL): STREET - o'

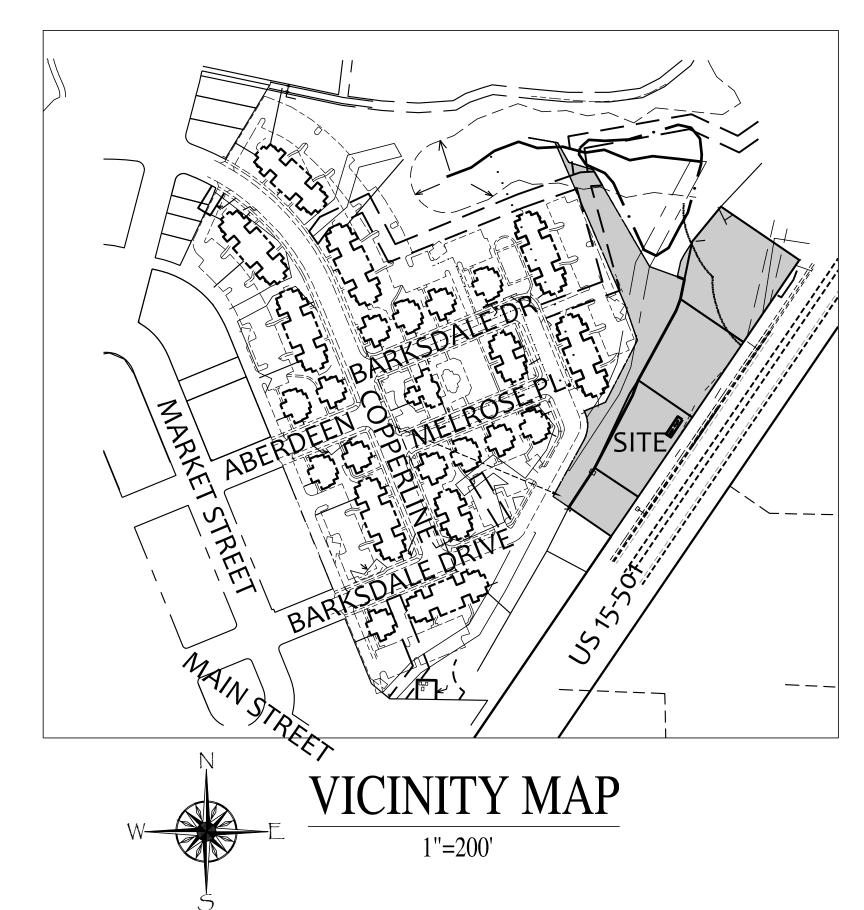
SOLAR - 20' 8,616 SF **EXISTING IMPERVIOUS AREA** 61,103.58 (40.32%) PROPOSED IMPERVIOUS AREA FLOOR AREA ALLOWED (GLA * FAR) 160,913.75 SF 133,820.41 SF x 1.20 160,584.49 ŚF 32,925.59 SF x 0.01 329.26 SF

INTERIOR - o'

- 1. Boundary information taken from field survey by Sullivan Surveying, August 2012. 2. Topographic information taken from field survey by Sullivan Surveying, November 2012. 3. FEMA Floodplain information taken from FIRM Panel 3710978700J Dated Feb. 2,2007 4. Soil information taken from Orange County NC GIS data. 5. All construction shall be in conformance with Town of Chapel Hill and NCDOT
- standards and specifications. 6. Perennial stream determination provided by the Town of Chapel Hill dated 5/08/2012.

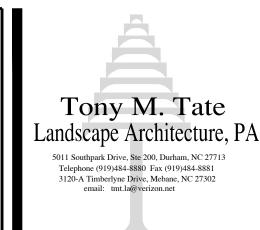



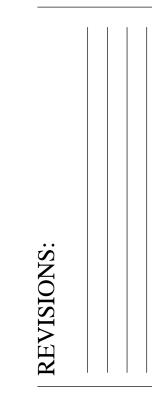


SCALE:


1''=40' DRAWN BY: T.M.T. PROJECT # 06/04/12

COVER



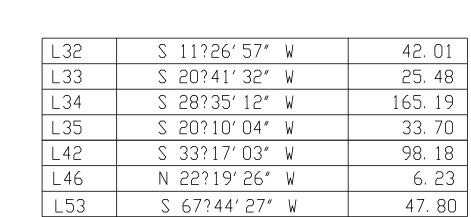

CURVE	ARC	RADIUS	CHORD LENGTH	CHORD BEARING
C16	57. 01	64. 00	55. 14	N 03?11′41″ E

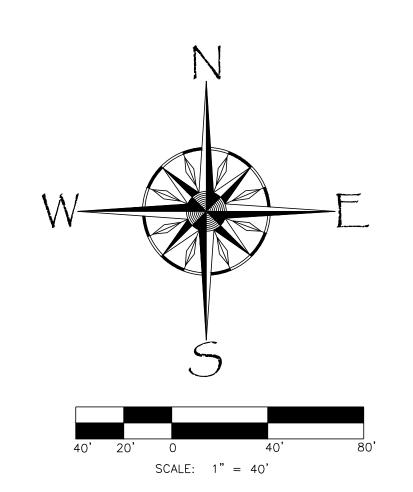





REVISION 10/04/12

SCALE: 1''=40' DRAWN BY: T.M.T. PROJECT # DATE: 06/04/12

SOILS

Ch Chewacla Series-The Chewacla series consists of somewhat poorly drained, moderately permeable soils that formed in recent alluvium. These soils are in long flat areas parallel to the major streams. Slope is 0-2%.

LoF Louisburg Sandy Loam Series- The Louisburg series consists of well drained to excessively drained, rapidly permeable soils that formed in weathering granite and gneiss. These soils are on side slopes adjacent to major drainageways. Slope is 6-45%.

LoC Louisburg Sandy Loam-This series slope is 6-15%.

HYDROLOGY


Wilson Creek, a perennial stream, is located on the northern end of the property traversing thru the Creekside Crew Property. A 150 foot Resource Conservation District buffer from the top of bank has been established. North of this site exists an existing stormwater retention basin constructed for a portion of the Southern Village development. A 100 year floodplain exists on Wilson Creek as found on FEMA FIRM Panel 3710978700J dated February 2, 2007.

VEGETATION

Existing vegetation for this site is mixed consisting of hardwood forest on the banks of Wilson Creek, hardwoods adjacent to cleared areas for existing structures, ornamental planted vegetation associated with residential habitation, and evergreen ornamental screening shrubs planted in association with the Southern Village Apartment Complex planted in the mid 1990's.


SLOPES

This site consists of slopes of natural and man made origin. The areas near and adjacent to Wilson Creek are flat to gently sloping typically found adjacent to streams. The majority of the site where the existing structures lie consists of gentle slopes the remnants of a previous location for Highway 15-501. There are man made fill slopes greater than 25% constructed during the development of the Southern Village Apartments.

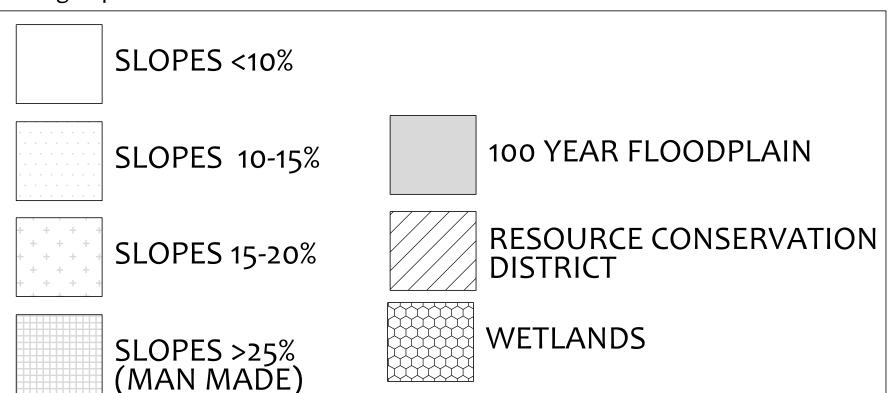


SPECIAL FEATURES

This site is narrow in depth from US Highway 15-501 to Barksdale Drive. Depths range from 145' deep on the southern end to 200' deep on the northern end near Wilson Creek. Water and sanitary sewer are readily available in the right of way of 15-501. Transportation accessibility is being provided via 15-501 for vehicular and bicycle traffic. Pedestrian and bicycle access is available via Barksdale Drive.

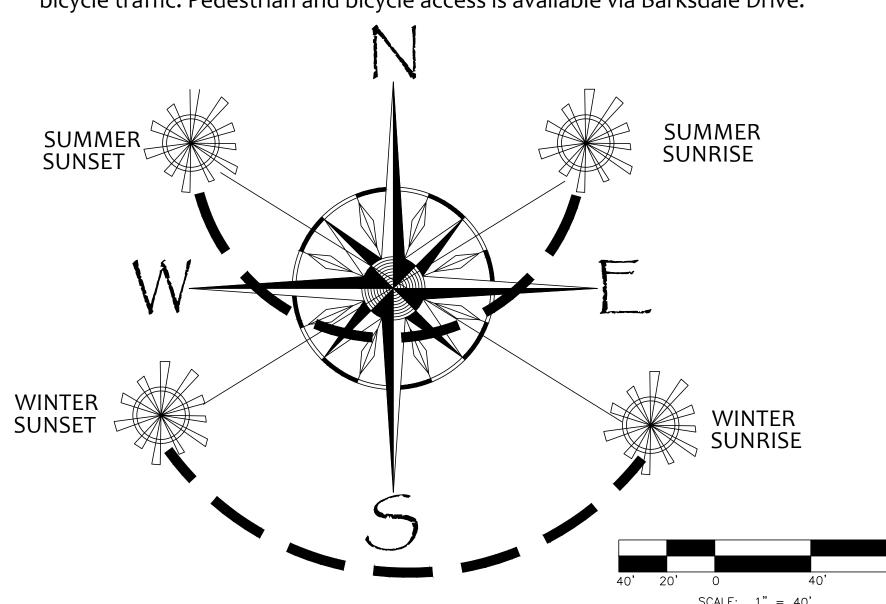





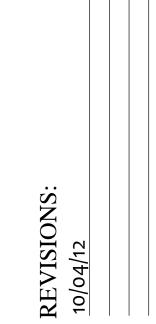

SCALE: 1"=40' DRAWN BY: T.M.T. PROJECT #

09007

06/04/12







SCALE: 1''=40' DRAWN BY: T.M.T. PROJECT # 06/04/12

1. Boundary information taken from field survey by Sullivan Surveying, August 2012.

2. FEMA Floodplain information taken from FIRM Panel 3710978700J Dated Feb. 2,2007 3. Topographic and soil information taken from Orange County NC GIS data.

4. All construction shall be in conformance with Town of Chapel Hill and NCDOT

standards and specifications.

5. Perennial stream determination provided by the Town of Chapel Hill dated 5/08/2012. 6. Propose parking is being designed to be concealed underneath the proposed buildings.

7. Handicap parking shall be provided in accordance with State and local requirements. 8. Existing refuse and recycling containers in parking lot to be relocated and upgraded to

meet the needs of the new apartment building. Hotel collection by private contractor. 9. Prior to any construction on this site, the applicant shall hold a pre-construction and

pre-demolition conference with the Town's solid waste planner, urban forester and OWASA. 10. A 5 foot concrete sidewalk shall be installed along Barksdale Drive & relocated on 15/501. 11. Driveway access to US 15/501 shall be approved and constructed in accordance with NCDOT and the Town of Chapel Hill standards and specifications.

12. Any landscape or street tree plantings proposed inside the right of way shall be approved by NCDOT and Town of Chapel Hill.

GENERAL PLANTING NOTES:

1. Verification of total quantities shown in the plant list shall be the responsibility of the landscape contractor, and the total quantities shall be required on the planting plan. 2. All trees, shrubs, and plants shall conform the the accepted standards established by the American

Nursery and Landscape Association.

3. All saucers shall be soaked with water and mulched immediately following planting. 4. All plants shall bear the same relation to finish grade as it bore to previous existing grade. 5. The size of all root balls shall conform to ANLA standards.


6. Fertilize all plants with Agriform fertilizer tablets or equal to be applied at manufacturers

7. Guying, if necessary, shall be removed after one (1) growing season.


8. All root balls removed from containers shall be scarified prior to backfilling. 9. All trees have been located with respect to proposed or existing facilities and structures. 10. Owners shall maintain all plant beds and plant material in good health, and any dead, unhealthy , or missing plants shall be replaced with locally adapted vegetation which conforms to initial planting

standards of the Landscape Ordinance. 11. 95% of parking located beneath the buildings therefore we are meeting the 35% shading

12. Stormwater BMP shall be planted to the specifications of the Town of Chapel Hill and NCDENR.

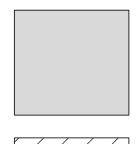

100 YEAR FLOODPLAIN

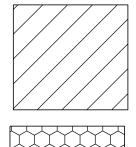

RESOURCE CONSERVATION DISTRICT



RECREATION AREA

PROPOSED ZONING: MUV-ARTERIAL


REQUIRED RATIO: 0.046

151,557.78 SQ. FT. * 0.046 = 6,971.66

REQUIRED: 6,971.66 SQ FT OF RECREATION SPACE


PROVIDED: _1,125_ SQ FT OF RECREATION SPACE (LOCATED WITHIN THE BUILDING AS THE FITNESS CENTER)

*THE REMAINING RECREATION SPACE IS PROPOSED TO BE ADDITIONAL ACTIVE AND/OR PASSIVE RECREATION SPACE WITHIN SOUTHERN VILLAGE. LOCATION AND DESIGN TO BE APPROVED BY TOWN OF CHAPEL HILL PARKS AND RECREATION.

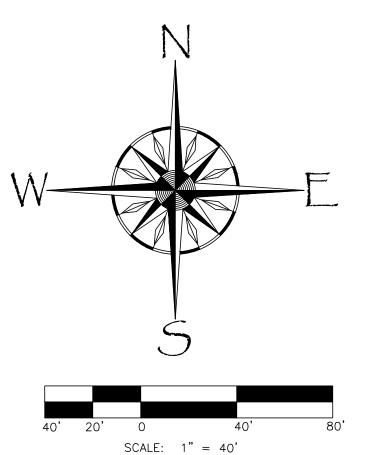






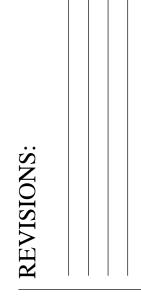

SCALE: 1''=40'DRAWN BY: T.M.T. PROJECT # 09007 12/01/12

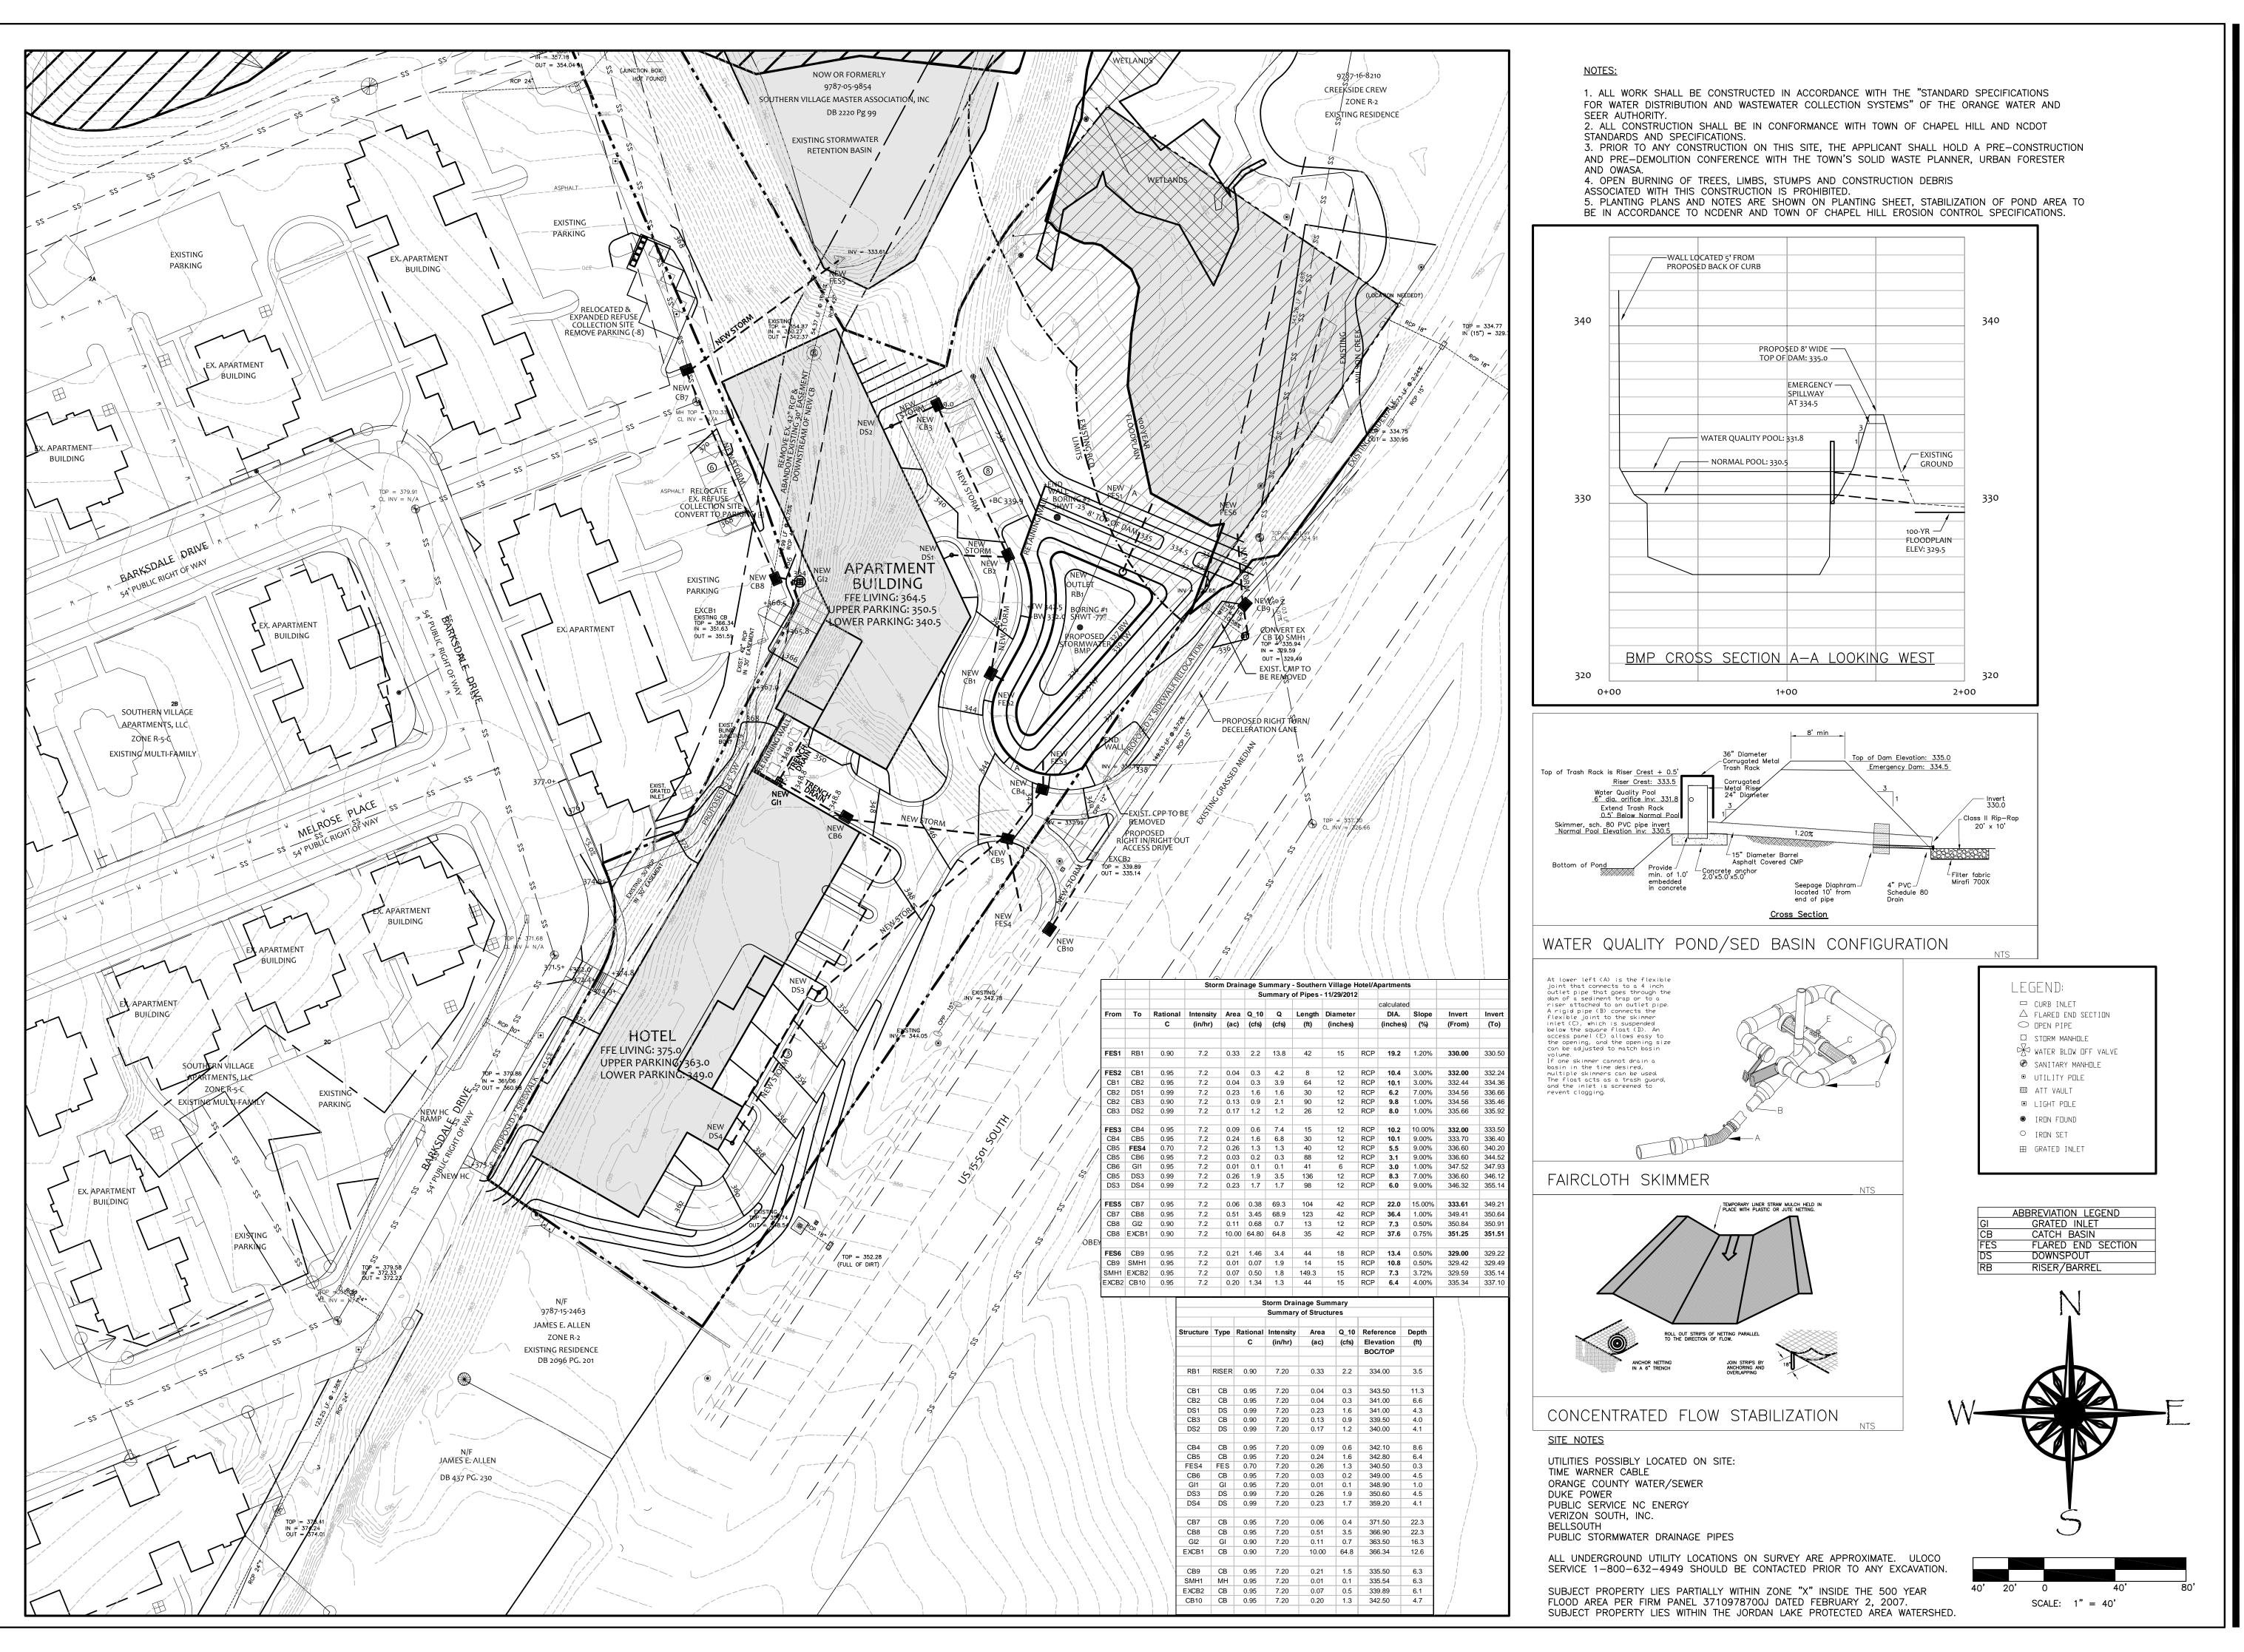

B&F

CONSULTING

2805 Tobermory Lane
Raleigh, NC 27606

Phone No. (919) 389-8102
License No. C-2149

PRELIMINARY
DO NOT USE FOR
CONSTRUCTION

REVISIONS:

trn Village Hotel & Apartments d, LLC 400 Market Street, Suite 115, Chapel Hill, NC 27516 age, Chapel Hill, LLC

SCALE:

1"=40'

DRAWN BY:

A.R.F.

CHECKED BY:

R.J.B.

DATE:

12-7-2012 SHEET

SUP-5



1. ALL WORK SHALL BE CONSTRUCTED IN ACCORDANCE WITH THE "STANDARD SPECIFICATIONS FOR WATER DISTRIBUTION AND WASTEWATER COLLECTION SYSTEMS" OF THE ORANGE WATER AND

2. ALL CONSTRUCTION SHALL BE IN CONFORMANCE WITH TOWN OF CHAPEL HILL AND NCDOT 3. PRIOR TO ANY CONSTRUCTION ON THIS SITE, THE APPLICANT SHALL HOLD A PRE-CONSTRUCTION AND PRE-DEMOLITION CONFERENCE WITH THE TOWN'S SOLID WASTE PLANNER, URBAN FORESTER

4. OPEN BURNING OF TREES, LIMBS, STUMPS AND CONSTRUCTION DEBRIS ASSOCIATED WITH THIS CONSTRUCTION IS PROHIBITED.

HOURS OF CONSTRUCTION

1. WEEKDAY HOURS OF CONSTRUCTION SHALL NOT START EFORE 7:30 AM AND SHALL END NO LATER THAN 5:00 PM. SATURDAY HOURS OF CONSTRUCTION SHALL NOT START BEFORE 10:00 AM AND SHALL END NO LATER THAN 5:00 PM. NO SUNDAY HOURS OF CONSTRUCTION SHALL BE PERMITTED. 2. THE FOLLOWING HOLIDAYS SHALL BE RESTRICTED: DECEMBER 25TH

DECEMBER 26TH IF DECEMBER 25TH IS A SUNDAY NEW YEAR'S DAY

JANUARY 2ND IF NEW YEAR'S DAY IS A SUNDAY MARTIN LUTHER KING JR. DAY

MEMORIAL DAY JULY 4TH

3. NOISE GENERATING CONSTRUCTION ACTIVITIES WILL BE MINIMIZED ON SATURDAYS WHEREVER POSSIBLE. 4. OPERATIONS THAT DO NOT GENERATE OBJECTIONABLE NOISE WILL NOT BE RESTRICTED.

5. THE EXTENSION OF THESE HOURS, FOR SPECIFIC OPERATIONS, SHALL BE APPROVED BY THE TOWN MANAGER.

CLEARING LIMITS:

106,302 SQ. FT. (2.44 AC) ON SITE PROPERTY 41,279 SQ.FT. (0.95 AC) OFF SITE (SIDEWALK, NCDOT, UTILITIES) 147,581 SQ.FT. (3.39 AC) TOTAL

- CONSTRUCTION SEQUENCE

 1. OBTAIN GRADING PERMIT FROM THE ORANGE COUNTY DEPARTMENT OF PLANNING AND INSPECTIONS. HAVE THE RISER/BARRELLS DELIVERED FOR PROPOSED POND. 2. SET UP A PRECONSTRUCTION CONFÉRENCE WITH THE EROSION CONTROL INSPECTOR
- OF ORANGE COUNTY (919-245-2586). 3. HOLD A PRE-CONSTRUCTION MEETING WITH EACH OF THE FOLLOWING: A REPRESENTATIVE OF THE TOWN'S LANDSCAPE PROTECTION DEPARTMENT, THE TOWN'S URBAN FORESTER, AND A REPRESENTATIVE FROM ORANGE COUNTY
- SOLID WASTE MANAGEMENT, AND OWASA. 4. INSTALL SILT FENCE, INLET PROTECTION, SEDIMENT TRAPS, TEMPORARY DIVERSION DITCHES, TREE PROTECTION AND OTHER MEASURES SHOWN ON THE PLANS, CLEARING
- ONLY AS NECESSARY TO INSTALL THESE DEVICES. 5. EXCAVATE PORTIONS OF PERMANENT DETENTION POND FOR TEMPORARY STORAGE.
- INSTALL THE RISER/BARREL AND TEMPORARY SKIMMER. 6. CALL SPENCE WRIGHT IN THE ORANGE COUNTY SOLID WASTE DEPARTMENT AT
- 919-968-2800 FOR A PRE-DEMOLITION CONFERENCE. 7. CALL THE ORANGE COUNTY EROSION INSPECTOR AT 919-245-2586 FOR AN ON-SITE
- INSPECTION. CONTINUE DAM CONSTRUCTION, AND INSTALL PERMANENT FAIRCLOTH SKIMMER PIPES IN DAM WHEN FILL IS BEING PLACED.
- 8. MAINTAIN EROSION CONTROL DEVICES UNTIL INSTRUCTED TO REMOVE. 9 STABILIZE SITE AS AREAS ARE BROUGHT TO FINISHED GRADE. STABILIZE ANY AREAS
- WITHIN 15 (FIFTEEN) DAYS AFTER THE AREA IS BROUGHT TO FINISHED GRADE. 10. ALL EROSION CONTROL MEASURES SHALL BE CONSTRUCTED IN ACCORDANCE WITH THE ORANGE COUNTY EROSION CONTROL MANUAL SINCE THE PERMANENT BASIN WILL, FOR A TIME, SERVE AS THE TEMPORARY EROSION CONTROL MEASURE, THE BASIN SHALL BE IN ACCORDANCE WITH THE MAINTENANCE AND OPERATION PLAN AS WRITTEN IN THE SOUTHERN VILLAGE HOTEL AND APARTMENT STORMWATER IMPACT
- STATEMENT BY B&F CONSULTING, INC. . FINISH DAM FACE AND STABILIZE WITH GRASS SEED.
- 12. REMOVE SEDIMENT ACCUMULATED IN THE PERMANENT BASIN AND RESTORE TO DESIGN
- 13. PROVIDE AS-BUILT SURVEY OF DAM TOP ELEVATION, WIDTH AND BASIN SLOPE AND DEPTH. 14. REMOVE TREE PROTECTION FENCING, SILT FENCING, CONSTRUCTION ENTRANCE AND OTHER EROSION CONTROL MEASURES WHEN INSTRUCTED.

EROSION CONTROL LEGEND TREE PROTECTION FENCING WADDLES AT 100 LF O.C. INLET PROTECTION (BASIN/PIPE) RIP-RAP PAD TEMPORARY SEDIMENT BASIN CONSTRUCTION ENTRANCE TEMPORARY DIVERSION DITCH TDD-> TDD-> LIMITS OF DISTURBANCE

IMPERVIOUS SURFACE TALLIES

8,600 SF EXISTING ON-SITE IMPERVIOUS TO BE REMOVED: PROPOSED ON-SITE IMPERVIOUS ADDED: 61,733 SF 53,133 SF TOTAL ON-SITE IMPERVIOUS: EXISTING OFF-SITE IMPERVIOUS TO BE REMOVED: 1,782 SF PROPOSED OFF-SITE IMPERVIOUS ADDED: 7,306 SF TOTAL ADDITIONAL OFF-SITE IMPERVIOUS: 5,524 SF

58,657 SF TOTAL IMPERVIOUS ADDED WITH THIS PROJECT:

FLARED END SECTION DOWNSPOUT RISER/BARREL

SCALE: 1" = 40'

LEGEND:

☐ CURB INLET

O DPEN PIPE

C STORM MANHOLE

SANITARY MANHULE

UTILITY POLE M ATT VAULT

LIGHT POLE

IRON FOUND

O IRON SET

⊞ GRATED INLET

△ FLARED END SECTION

WATER BLOW OFF VALVE

SITE NOTES

UTILITIES POSSIBLY LOCATED ON SITE: TIME WARNER CABLE ORANGE COUNTY WATER/SEWER DUKE POWER PUBLIC SERVICE NC ENERGY VERIZON SOUTH, INC. BELLSOUTH

PUBLIC STORMWATER DRAINAGE PIPES

ALL UNDERGROUND UTILITY LOCATIONS ON SURVEY ARE APPROXIMATE. ULOCO SERVICE 1-800-632-4949 SHOULD BE CONTACTED PRIOR TO ANY EXCAVATION.


SUBJECT PROPERTY LIES PARTIALLY WITHIN ZONE "X" INSIDE THE 500 YEAR FLOOD AREA PER FIRM PANEL 3710978700J DATED FEBRUARY 2, 2007. SUBJECT PROPERTY LIES WITHIN THE JORDAN LAKE PROTECTED AREA WATERSHED.

2805 Tobermory Lane Raleigh, NC 27606 Phone No. (919) 389-8102 License No. C-2149

> PRELIMINARY DO NOT USE FOR CONSTRUCTION

1"=40' DRAWN BY: A.R.F. CHECKED BY: DATE: 12-7-2012

SCALE:

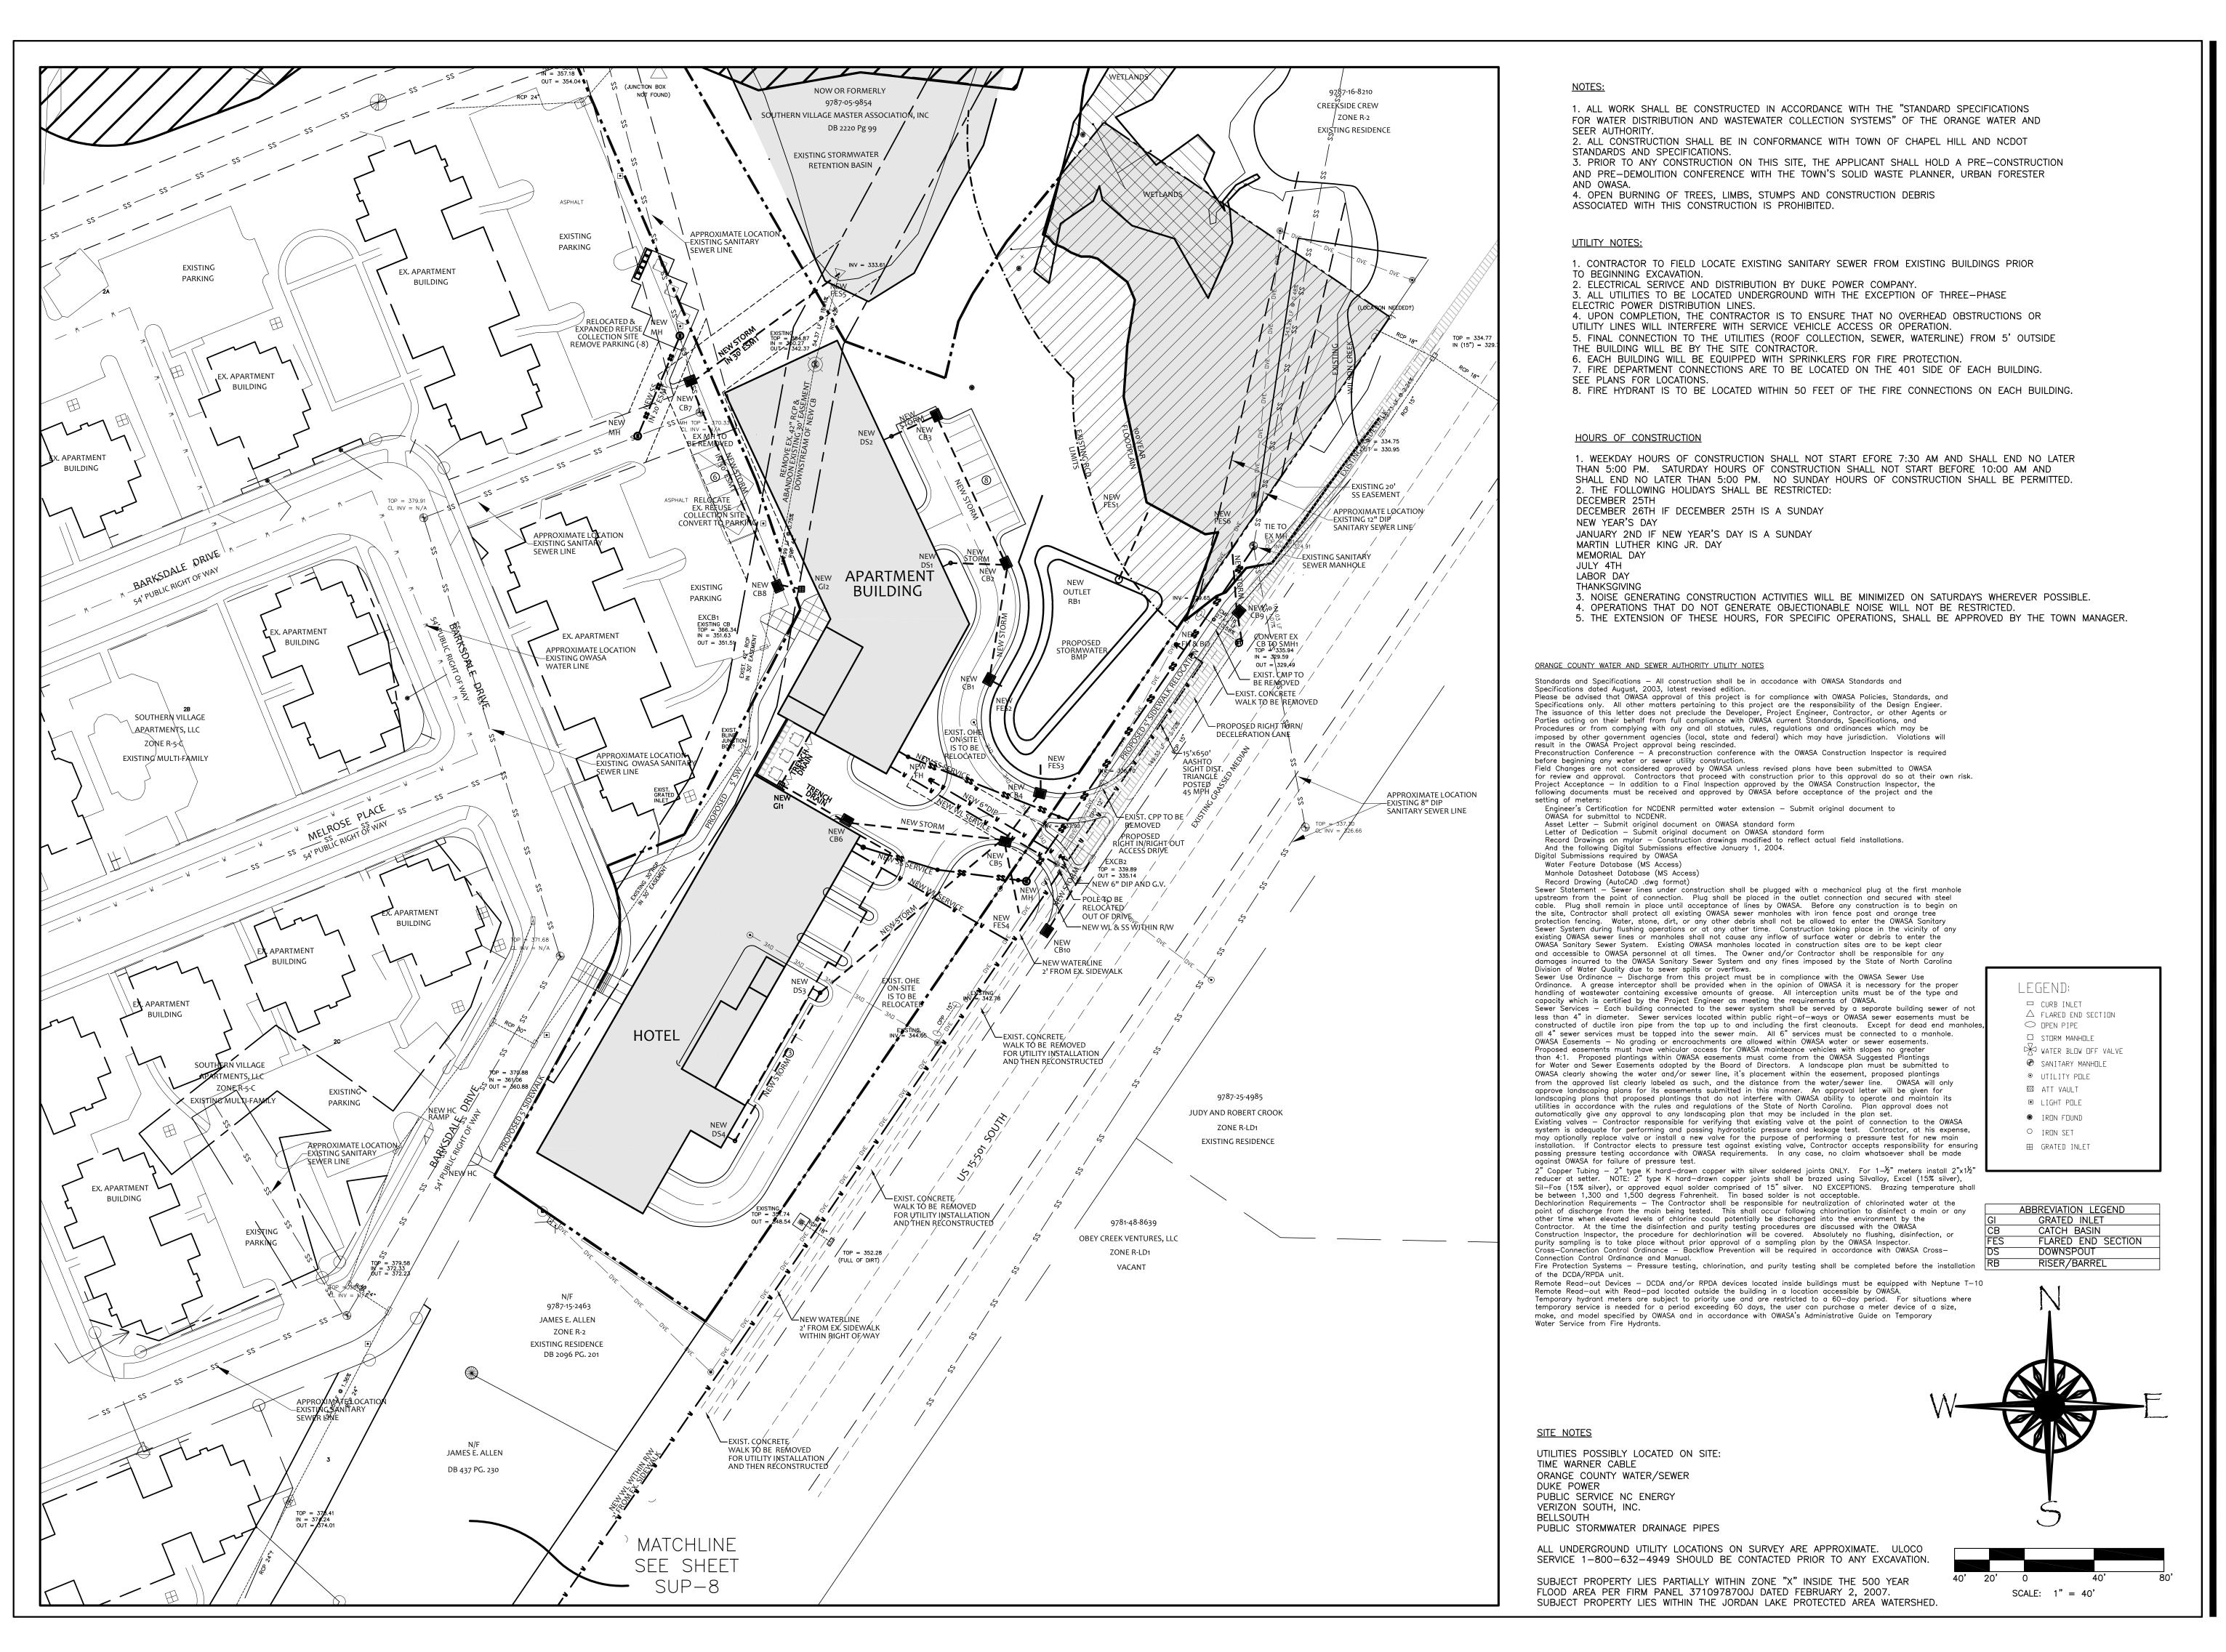

B&F
CONSULTING
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Raleigh, NC 27606
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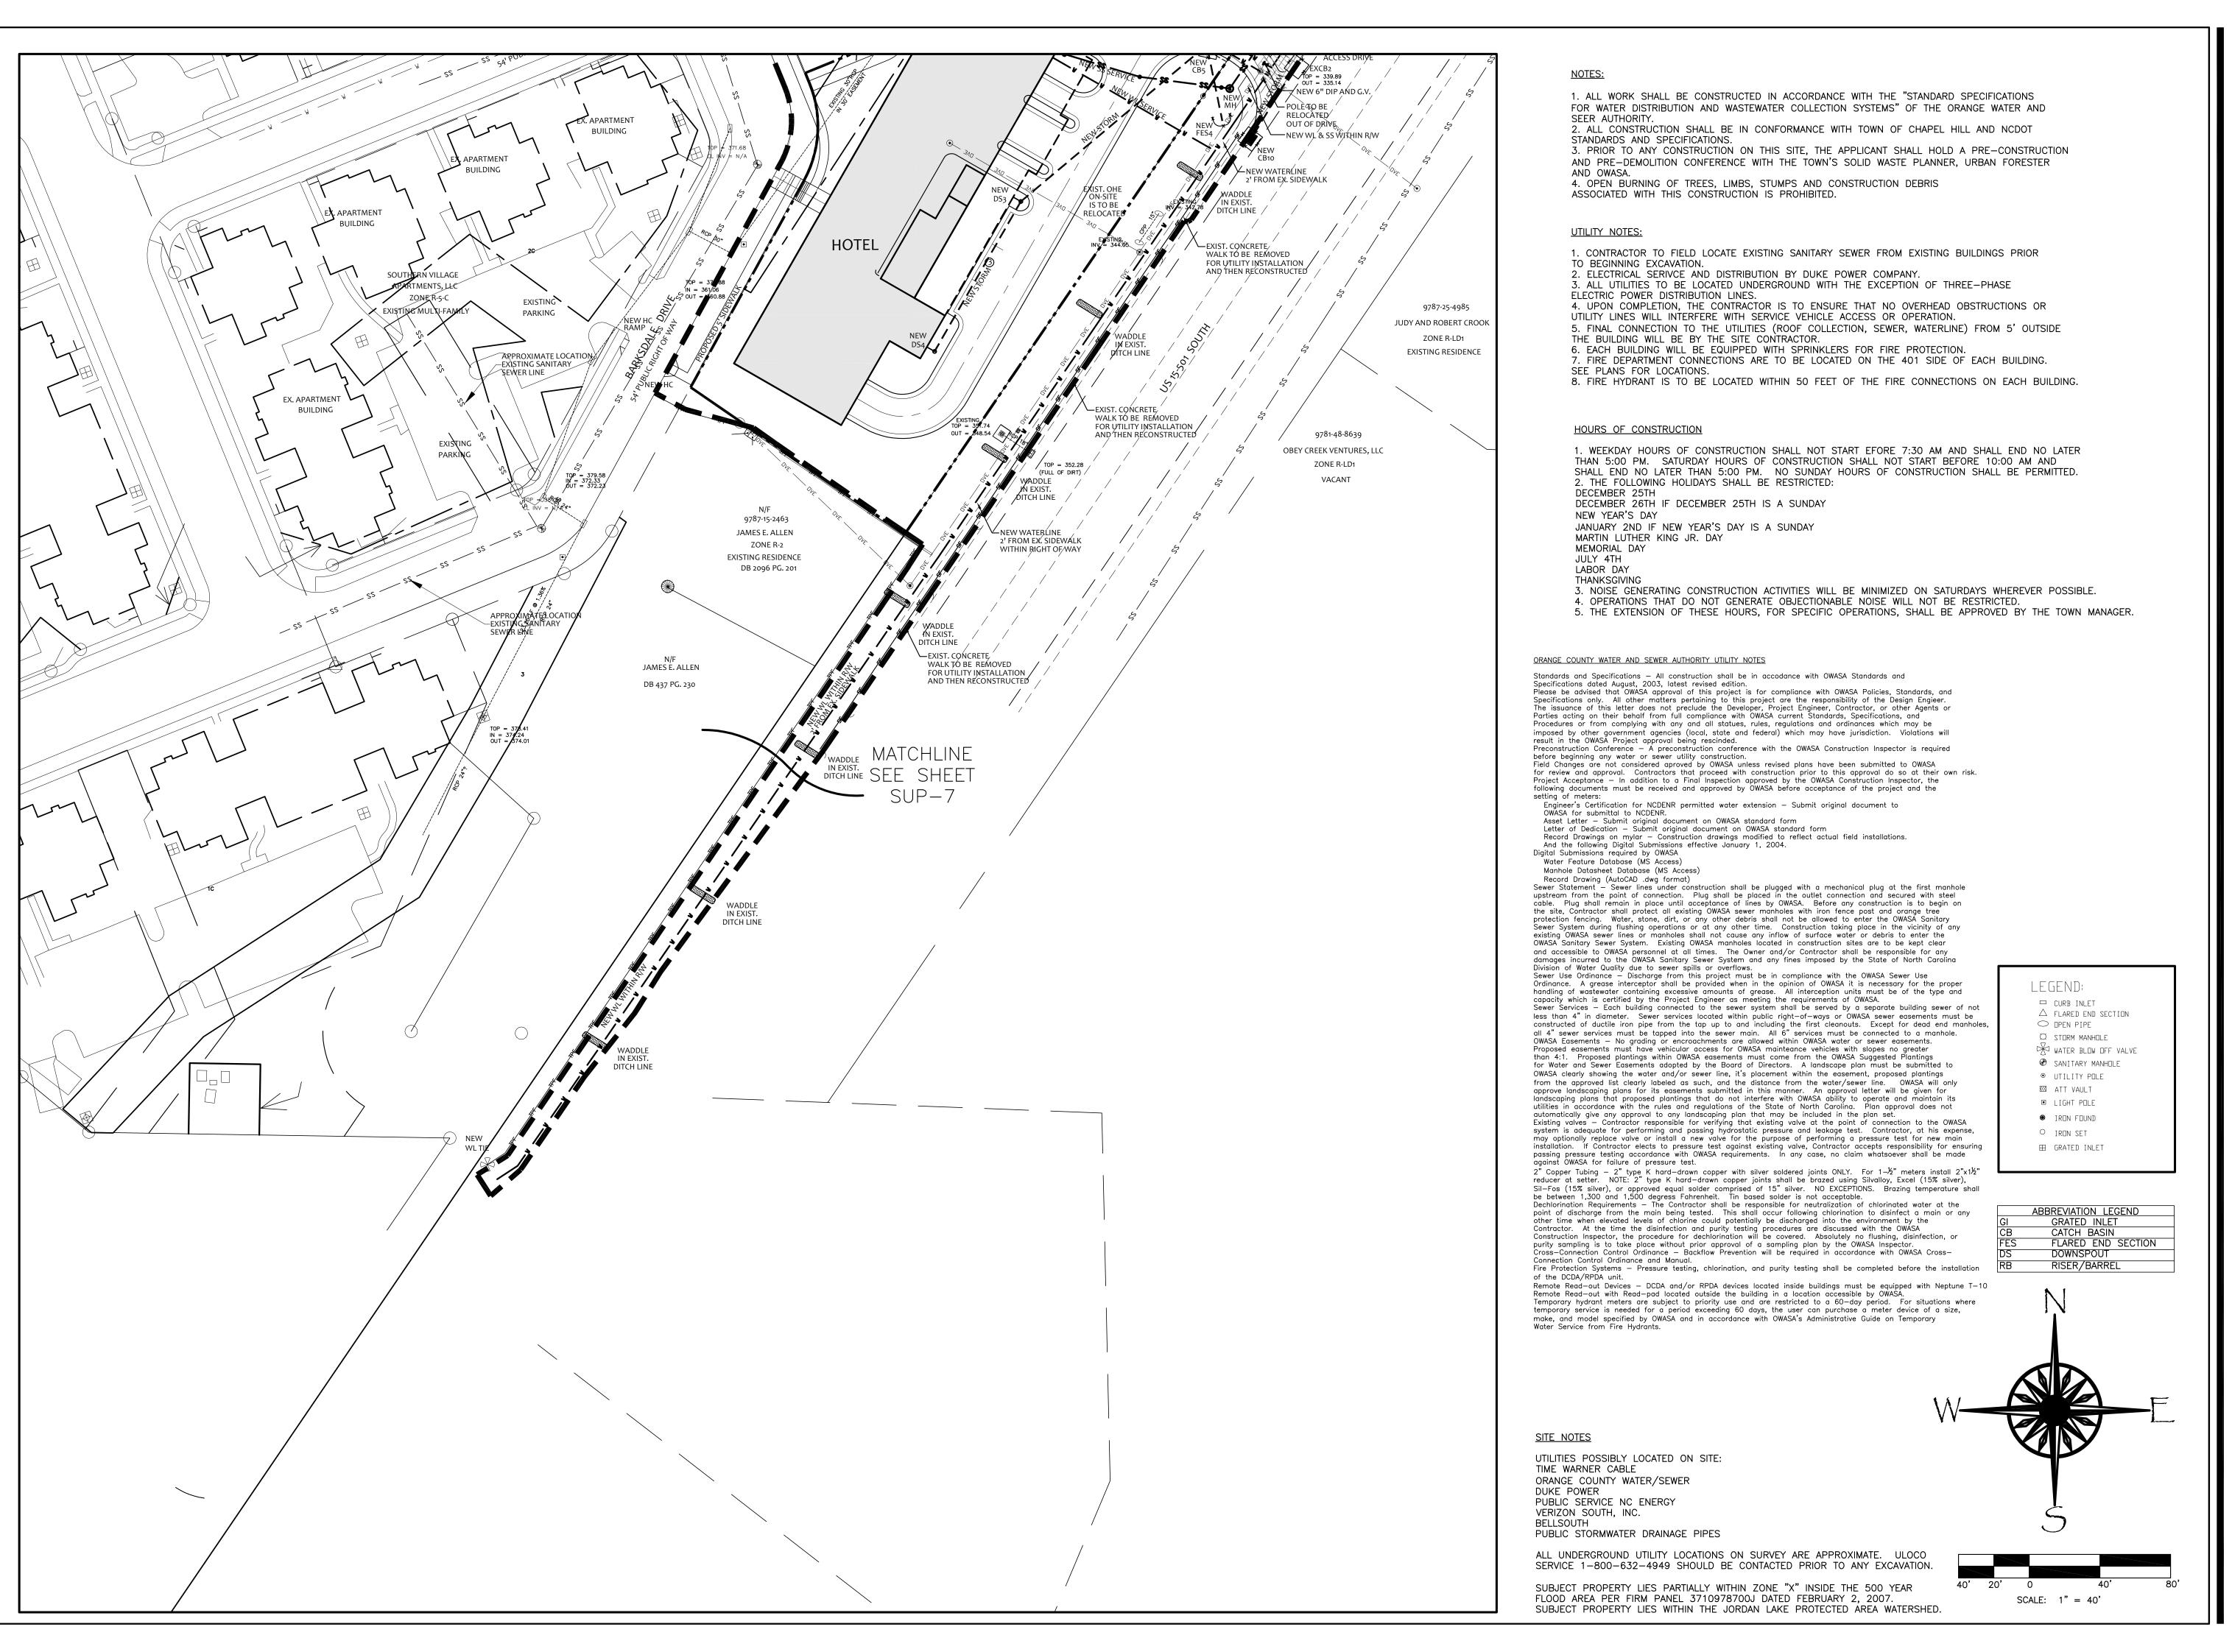
EVISIONS:

Southern Village Hotel & Apartme Redwing Land, LLC 400 Market Street, Suite 115, Chapel Hill, NC 2 Southern Village, Chapel Hill, LLC

SCALE: 1"=40' DRAWN BY: A.R.F. CHECKED BY:

CHECKED BY: R.J.B. DATE: 12-7-2012

SHEET /



B&F CONSULTING 2805 Tobermory Lane Raleigh, NC 27606 Phone No. (919) 389-8102

License No. C-2149

PRELIMINARY
DO NOT USE FOR
CONSTRUCTION

EVISIONS:

Suthern Village Hotel & Apartn wing Land, LLC 400 Market Street, Suite 115, Chapel Hill, Note with Village Chapel Hill LLC

SCALE:
1"=40'
DRAWN BY:
A.R.F.
CHECKED BY:

12-7-2012

SHEET

POINT TREE 7372 POP 14* 7301 PINE 20 * 7373 POP 36 7302 PINE 15* 7374 HW 18 7303 PINE 19* 7375 SYCM 26DBL 7304 PINE 15* 7376 POP 12 7306 PINE 18* 7377 PINE 20 7307 PINE 17* 7378 SCYM 14 7379 POP 12 7308 GUM 6* 7309 GUM 6* 7380 PINE 20 7381 PINE 18 7311 PINE 24* 7382 GUM 14 7312 GUM 27* 7383 HW 16 GUM 18* 7384 GUM 15 7385 HW 20 7387 GUM 15 DBL 7388 HW 15 7390 PINE 28 7391 PINE 19 7392 GUM 24

7314 DBLGUM 27 7315 PINE 18* 7316 PINE 20 * 7317 PINE 27* 7319 PINE 20* FIR 18* 7393 PINE 20 7322 POP 14 * 7323 GUM 29 * 7394 SYCM 19 7324 HW 12 7395 POP 17 7325 HW 14 7396 POP 13 7397 GUM 12 7398 POP 24 7399 HW 12

7327 HW 12 7328 HW 14 7400 GUM 15 7329 HW 14 7401 SCYM 12 7330 HW 12 7331 HW 12 7402 GUM 13 7403 GUM 18 7333 7404 GUM 19 7334 HW 12 7405 PINE 14 7406 XPOP 36* 7407 CEDAR 15* 7336 MAG 12 7408 MAPLE 22* 7337 HW 12

7409 MAPLE 22* 7338 PECAN 12 7339 OAK 12 7410 MAG 12* 7340 GUM 12 7411 MAG 10 TRIP * 7341 XGUM 14 7412 MAG 10* 7413 GUM 12 * 7342 GUM 15 7343 XPINE 36 7414 PINE 18 * 7415 PINE 22 * 7344 GUM 24

7416 MAPLE 12 7345 GUM 15 7346 GUM 20 7417 MAPLE 13 7357 OAK 12 7418 MAPLE 10 7358 DOGW 3 7419 MAPLE 7 7359 MAPLE 9 7420 MAPLE 9 7360 DOGW 4 7421 MAPLE 9

7422 MAPLE 9* 7423 MAPLE 10* 7362 POP 14 7363 GUM 27 7424 MAPLE 9* 7425 MAPLE 9* 7364 ELM 29 DBL 7365 POP 12

7366 HW 12 * 7367 HW 14 * * TREES TO BE REMOVED FOR DEVELOPMENT ACTIVITY 7369 HW 12 *****

7370 OAK 20* 7371 PINE 18 *

1. Rare and specimen tree information taken from field survey by Sullivan Surveying, November 2012.

2. Pre-Construction Conference. Prior to the commencement of any activities requiring a Zoning Compliance Permit, a pre-construction conference with the Town's Urban Forester or Landscape Architect shall take place to review procedures for protection and management of all protected landscape elements identified on the Landscape Protection Plan.

3. On-site Supervision. For all development other than that related to single-family and two-family dwellings on individual zoning lots, the following on-site supervision is

i. The applicant shall designate as Landscape Protection Supervisors one or more persons who have completed instruction in landscape protection procedures

ii. It shall be the duty of the Landscape Protection Supervisor to ensure the protection of new or existing landscape elements, as defined in the Landscape Protection Plan. The approved Landscape Protection Supervisor shall supervise all site work to assure that development activity conforms to provisions of the approved Landscape Protection Plan. At least one identified Landscape Protection Supervisor shall be present on the development site at all times when activity that could damage or disturb soil and adjacent landscape elements occurs such as: clearing and grubbing;

> - any excavation, grading, trenching or moving of soil; - removal, installation, or maintenance of all landscape elements and landscape protection devices; or delivery, transporting, and placement of construction materials and equipment on site.

LANDSCAPE PROTECTION NOTES:

1. Any tree roots exposed by construction shall be severed cleanly with a pruning tool. 2. Do not dispose of any chemicals or remove any soil outside of the limit of work. 3. When installing new landscape plants, do not drive equipment upon or disturb the soil within the critical root zone of existing trees.

4. All clearing limit lines not designated as being fenced will be flagged with a continuous strand of survey tape to be installed by the owner and maintained by the owner during all infrastructure

5. Any trees damaged by construction activity will, at the recommendation of the Town Manager, be removed by the applicant on all public right-of-ways and commons areas for maintenance by the

6. The preparation of a revised Landscape Protection Plan including the installation of additional tree protection fencing may be required of the applicant if rare or specimen trees are located on the site during infrastructure construction that are not shown or shown incorrectly located on the plans. 7. Additional tree protection measures and construction sequence shall be approved by the Town's Urban Forester prior to the issuance of a Z.C.P.

9. The critical root zone (CRZ) of rare and specimen trees which may be damaged during construction shall be fenced.

8. A pre-construction conference must be held by the Town's Urban Forester before any site work

TREE CANOPY COVERAGE

REQUIRED: 60,623.11 SQ. FT.

PROVIDED: 51,703.35 SQ. FT. OF EXISTING TREE

COVER* * REMAINING TREE COVERAGE BEING MET THROUGH PROPOSED LANDSCAPING WITH ONE TREE PER 500 SQ. FT. OF DEFICIT

8,919.76 - DEFICIT 8,919.76/500 = 17.84 PROPOSED TREES REQUIRED

18 OF THE PROPOSED CANOPY TREES ARE BEING USED TO MEET THE REMAINING TREE CANOPY COVERAGE REQUIREMENTS




Tony M. Tate

Landscape Architecture, PA

Telephone (919)484-8880 Fax (919)484-8881 3120-A Timberlyne Drive, Mebane, NC 27302


email: tmt.la@verizon.net

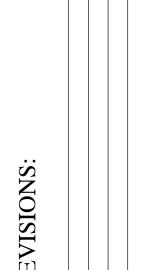


SCALE: 1"=50' DRAWN BY: T.M.T. PROJECT #

09007 06/04/12


PRELIMINARY ARCHITECTURAL GRAPHICS

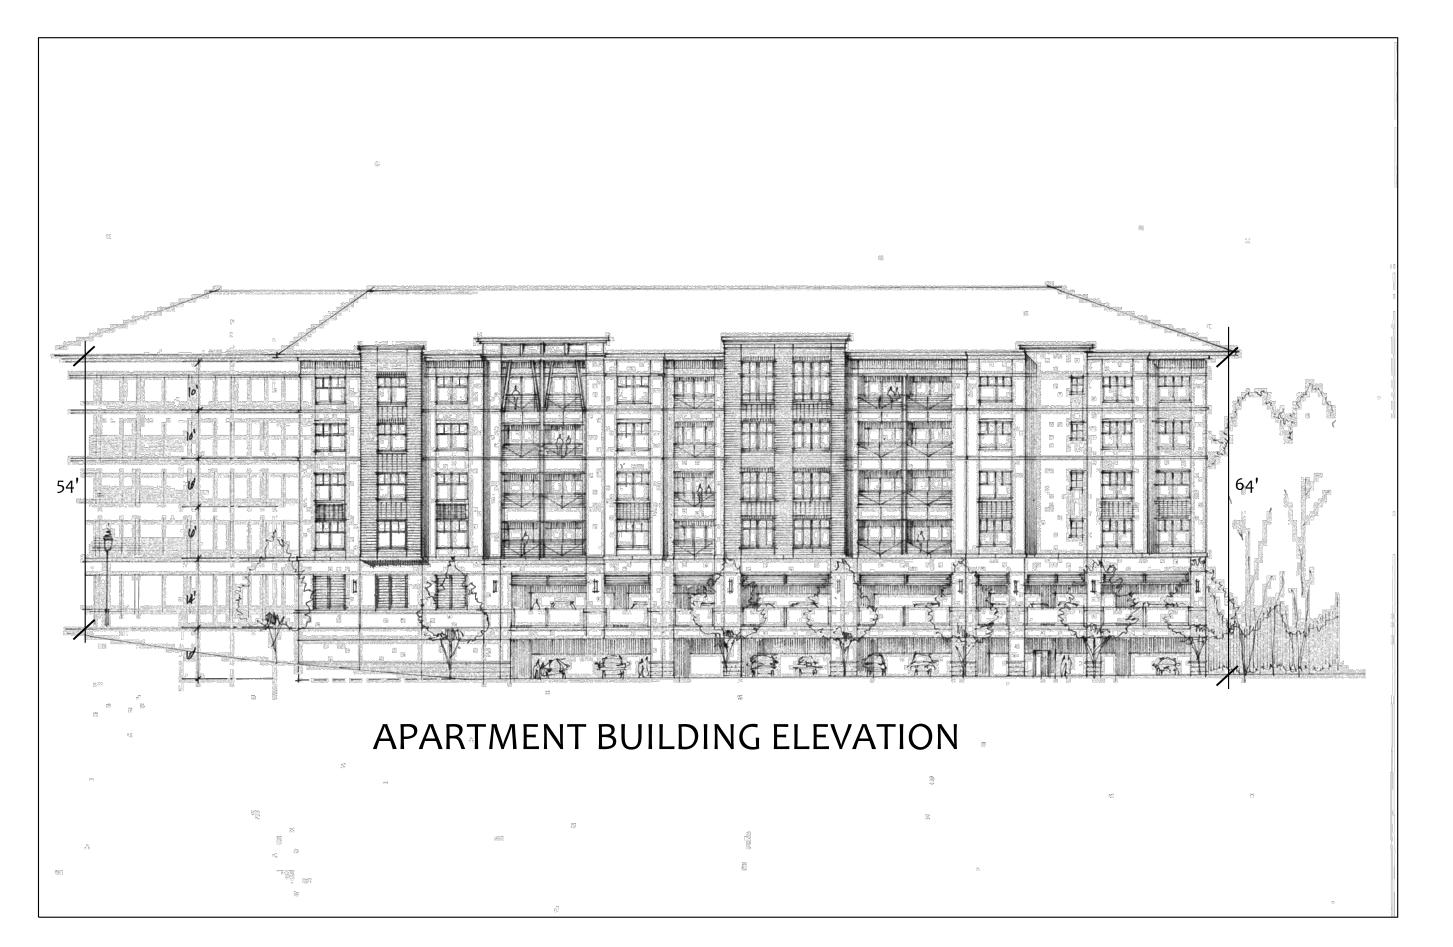

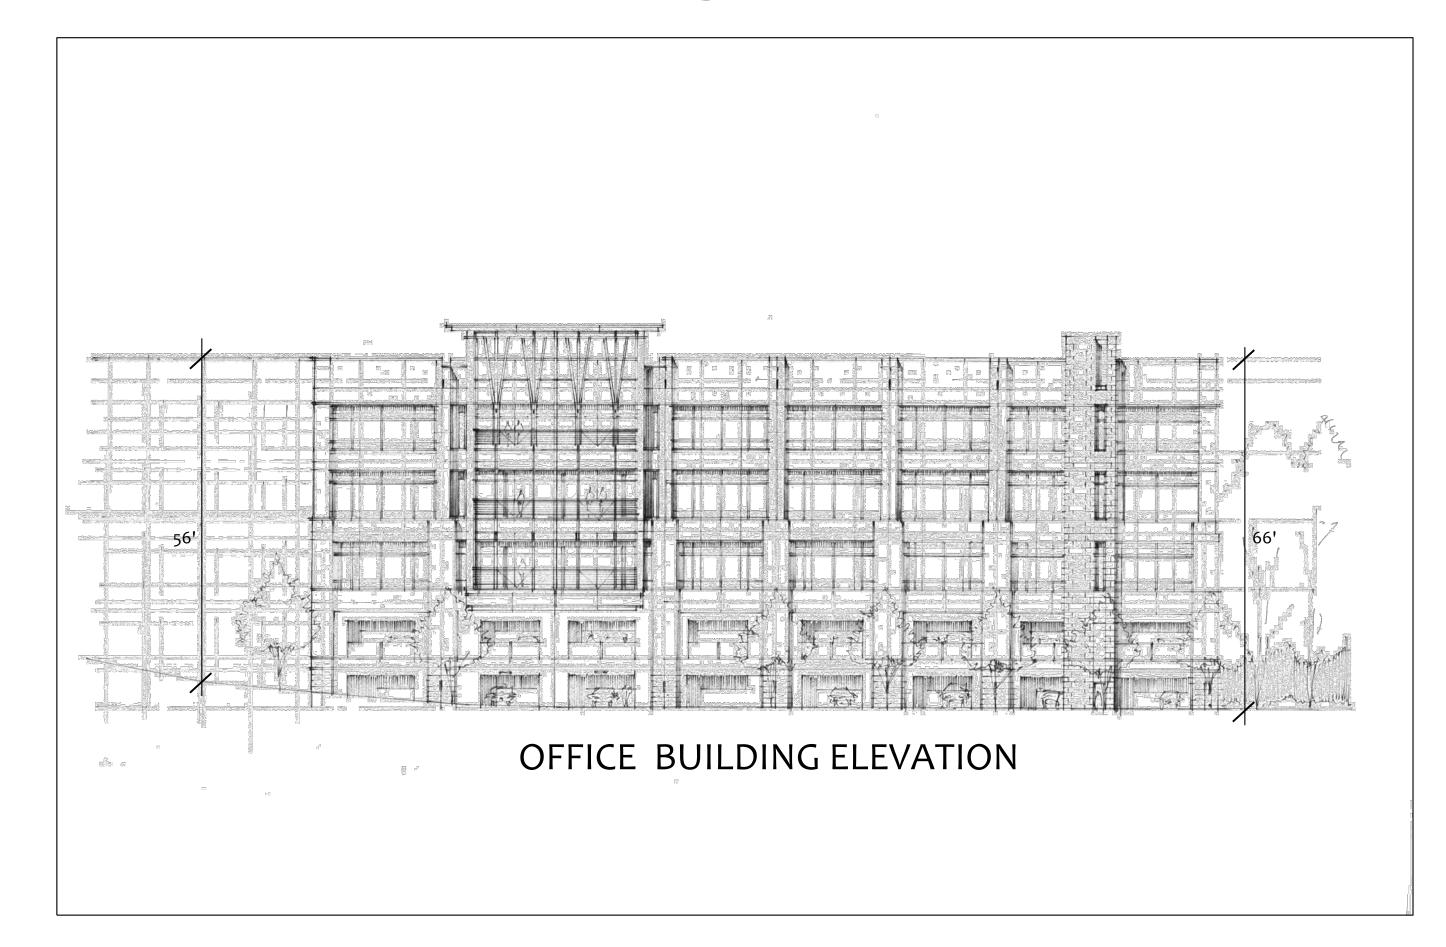



* ALL HVAC EQUIPMENT SHALL BE SCREENED FROM VIEW OF 15-501 AND BARKSDALE DRIVE ON ALL BUILDINGS.

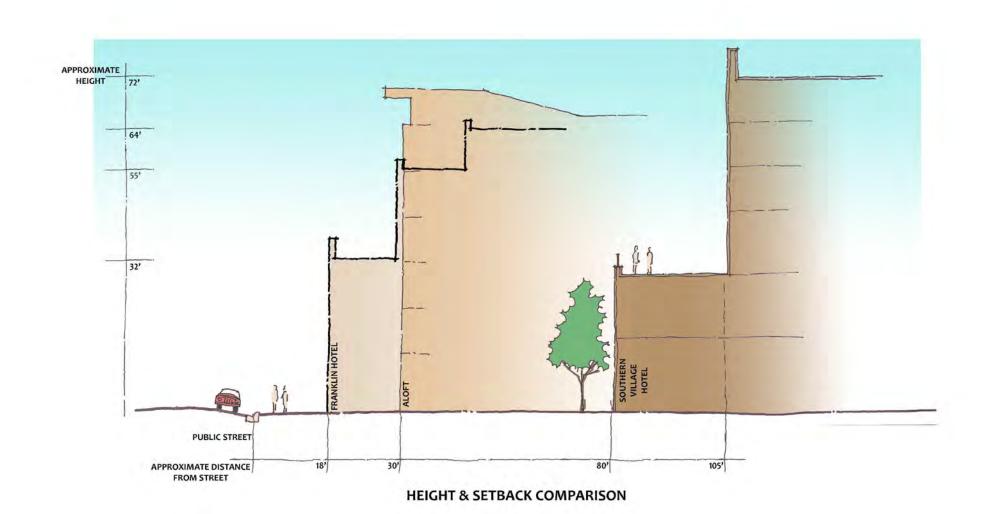

HOTEL ELEVATION

Tony M. Tate
Landscape Architecture, PA

5011 Southpark Drive, Ste 200, Durham, NC 27713
Telephone (919)484-8880 Fax (919)484-8881
3120-A Timberlyne Drive, Mebane, NC 27302
email: tmt.la@verizon.net

RBA Group
1414-A S. Tryon Street

REVISIONS:

PRELIMINARY ARCHITECTURAL ELEVATIONS Southern Village Hotel& Apartments

SCALE: 1"=40' DRAWN BY: T.M.T. PROJECT # 09007

12/01/12

SUP-10

). L



DUKE ENERGY

REVISIONS:

PLAN

V.7.11

LIGHTING PLA

SOUTHERN VILLAGE

Southern Village Chapel

SCALE: 1"=40' DRAWN BY: T.M.T. PROJECT # 09007 DATE: 12/01/12

SUP-11

OF