# 11SIXTY5 WEAVER DAIRY ROAD

1165 WEAVER DAIRY ROAD, CHAPEL HILL, NC 27514


SPECIAL USE PERMIT APPLICATION

SPECIAL USE PERMIT SUBMITTAL: 30 November, 2017

#### PROJECT DATA

PROPERTY ADDRESS	1165 WEAVER DAIRY ROAD
PROPERTY OWNER	COMPROP LLC
PIN DEED REFERENCE	9880350595 BOOK 6055 PAGE 580
EXISTING USE	VACANT LAND
PROPOSED USE	RETAIL, OFFICE, MEDICAL
USE GROUP	CLINIC B, C
LAND AREA GROSS LAND AREA = 78,	78,557 SF .557 SF X 1.10 = 86,412 SF
PROJECT AREA DISTURBED AREA	1.8 ACRES 1.8 ACRES
EXISTING ZONING PROPOSED ZONING	MU-01-1 01-3
PIN	9880350595
FAR (OI—3) MAXIMUM BUILDING SIZE	.566 48,909 SF
MAXIMUM BUILDING SIZE  EXISTING BUILDING SIZE	48,909 SF  O SF (FORMER BUILDING ALREADY REMOVE
MAXIMUM BUILDING SIZE  EXISTING BUILDING SIZE  PROPOSED BUILDING SIZE	48,909 SF  O SF (FORMER BUILDING ALREADY REMOVE 48,624 SF
FAR (OI-3) MAXIMUM BUILDING SIZE EXISTING BUILDING SIZE PROPOSED BUILDING SIZE REQUIRED PARKING PROPOSED PARKING	48,909 SF  O SF (FORMER BUILDING ALREADY REMOVE 48,624 SF  (EXCLUDING PARKING DECK)
MAXIMUM BUILDING SIZE  EXISTING BUILDING SIZE  PROPOSED BUILDING SIZE  REQUIRED PARKING  PROPOSED PARKING	48,909 SF  0 SF (FORMER BUILDING ALREADY REMOVE 48,624 SF (EXCLUDING PARKING DECK)  NOT SPECIFIED IN OI—3 ZONE  1 PER 216 BUILT SF 1 H/C SURFACE SPACE 4 STANDARD SURFACE SPACES 6 H/C SPACES IN PARKING DECK + 214 STANDARD SPACES IN PARKING DECK 225 SPACES TOTAL  ES 2  DE 1 FULL SIZE ON—SITE
MAXIMUM BUILDING SIZE  EXISTING BUILDING SIZE  PROPOSED BUILDING SIZE  REQUIRED PARKING  PROPOSED PARKING  REQUIRED LOADING SPACE  PROPOSED LOADING SPACE	48,909 SF  0 SF (FORMER BUILDING ALREADY REMOVE 48,624 SF (EXCLUDING PARKING DECK)  NOT SPECIFIED IN OI—3 ZONE  1 PER 216 BUILT SF 1 H/C SURFACE SPACE 4 STANDARD SURFACE SPACES 6 H/C SPACES IN PARKING DECK + 214 STANDARD SPACES IN PARKING DECK 225 SPACES TOTAL

#### **VICINITY MAP**

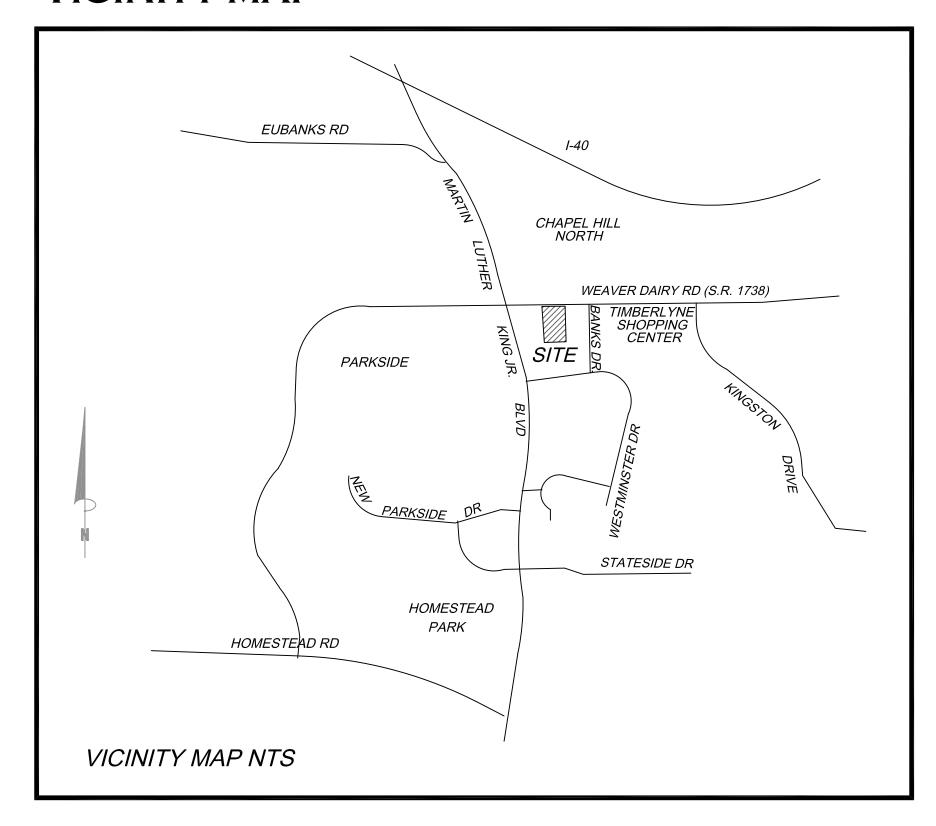

#### LIST OF SHEETS

<b>C-0</b>	COVER SHEET
C-0.1	AREA MAP
C-1.0	EXISTING CONDITIONS, DEMOLITION
	AND TREE PROTECTION PLAN, AND SITE ANALYSIS
C-1.1	CONSTRUCTION MANAGEMENT PLAN
C-2.0	SITE PLAN
C-3.0	GRADING AND STORMWATER PLAN
C-4.0	NOT USED (reserved for Erosion Control Plan)
C-5.0	UTILITY PLAN
C-6.0	NOT USED (reserved for Lighting Plan)
C-7.0	SITE DETAILS
L-1.0	LANDSCAPE AND TREE COVERAGE PLAN
A200	BUILDING ELEVATIONS
A201	BUILDING ELEVATIONS
A203	PARKING DECK ELEVATIONS
A204	PARKING DECK ELEVATIONS
A205	COMPOSITE EAST + WEST ELEVATIONS

#### **DESIGN TEAM**

OWNER/DEVELOPER 727 EASTOWN DRIVE, SUITE 300-D, CHAPEL HILL NC 27514 PETE SLOMIANYJ 919-949-1014 COULTER JEWELL THAMES PA 111 WEST MAIN STREET, DURHAM NC 27701 *WENDI RAMSDEN* 919-682-0368 CIVIL ENGINEER 111 WEST MAIN STREET, DURHAM NC 27701 VINCE CHIRICHELLA 919-682-0368 **ARCHITECT** 501 WASHINGTON STREET, SUITE G, DURHAM NC 27701 SCOTT LAPORTE 919-682-2870

#### **PROJECT NOTES**

GENERAL NOTES:

#### CONSTRUCTION WASTE:

- 1. BY ORANGE COUNTY ORDINANCE, CLEAN WOOD WASTE, SCRAP METAL AND CORRUGATED CARDBOARD, ALL PRESENT IN CONSTRUCTION WASTE, MUST BE RECYCLED.
- 2. BY ORANGE COUNTY ORDINANCE, ALL HAULERS OF CONSTRUCTION WASTE MUST BE PROPERLY LICENSED.
- 3. PRIOR TO ANY DEMOLITION OR CONSTRUCTION ACTIVITY ON THE SITE THE APPLICANT WILL HOLD A PRE-DEMOLITION/PRE-CONSTRUCTION CONFERENCE WITH THE COUNTY'S SOLID WASTE STAFF. THIS MAY BE THE SAME MEETING HELD WITH OTHER DEVELOPMENT OFFICIALS.
- 4. BECAUSE THERE MAY BE REGULATED RECYCLABLE MATERIALS (METAL, WOOD, CARDBOARD) IN SOME OF THE DEMOLITION WORK IN EXCESS OF 500 SQUARE FEET (EXISTING BUILDING) AS WELL AS IN THE NEW CONSTRUCTION OF THE PROPOSED FACILITY, THE APPLICANT WILL NEED TO CONTACT SOLID WASTE MANAGEMENT STAFF TO CONDUCT A PRE-DEMOLITION ASSESSMENT BEFORE BEGINNING WORK. IN ADDITION, THE APPLICANT WILL BE REQUIRED TO OBTAIN A REGULATED RECYCLABLE MATERIALS PERMIT FROM THE TOWN OF CHAPEL HILL.



111 West Main Street **Durham, N.C. 27701** p 919.682.0368 f 919.688.5646 www.cjtpa.com


NC BOARD OF EXAMINERS FOR **ENGINEERS AND SURVEYORS** NC BOARD OF LANDSCAPE ARCHITECTS LIC # C-104



Project

### 11SIXTY5 Weaver Dairy Road

1165 Weaver Dairy Rd. Chapel Hill, NC 27514

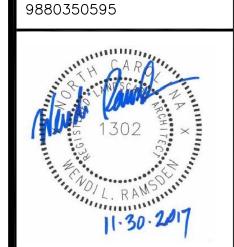

NOT ISSUED FOR CONSTRUCTION

Job Number: 1529


Checked WLR, VJC
Date 11-30-17 Revisions

SPECIAL USE PERMIT


Sheet Title:

COVER SHEET

Sheet Number

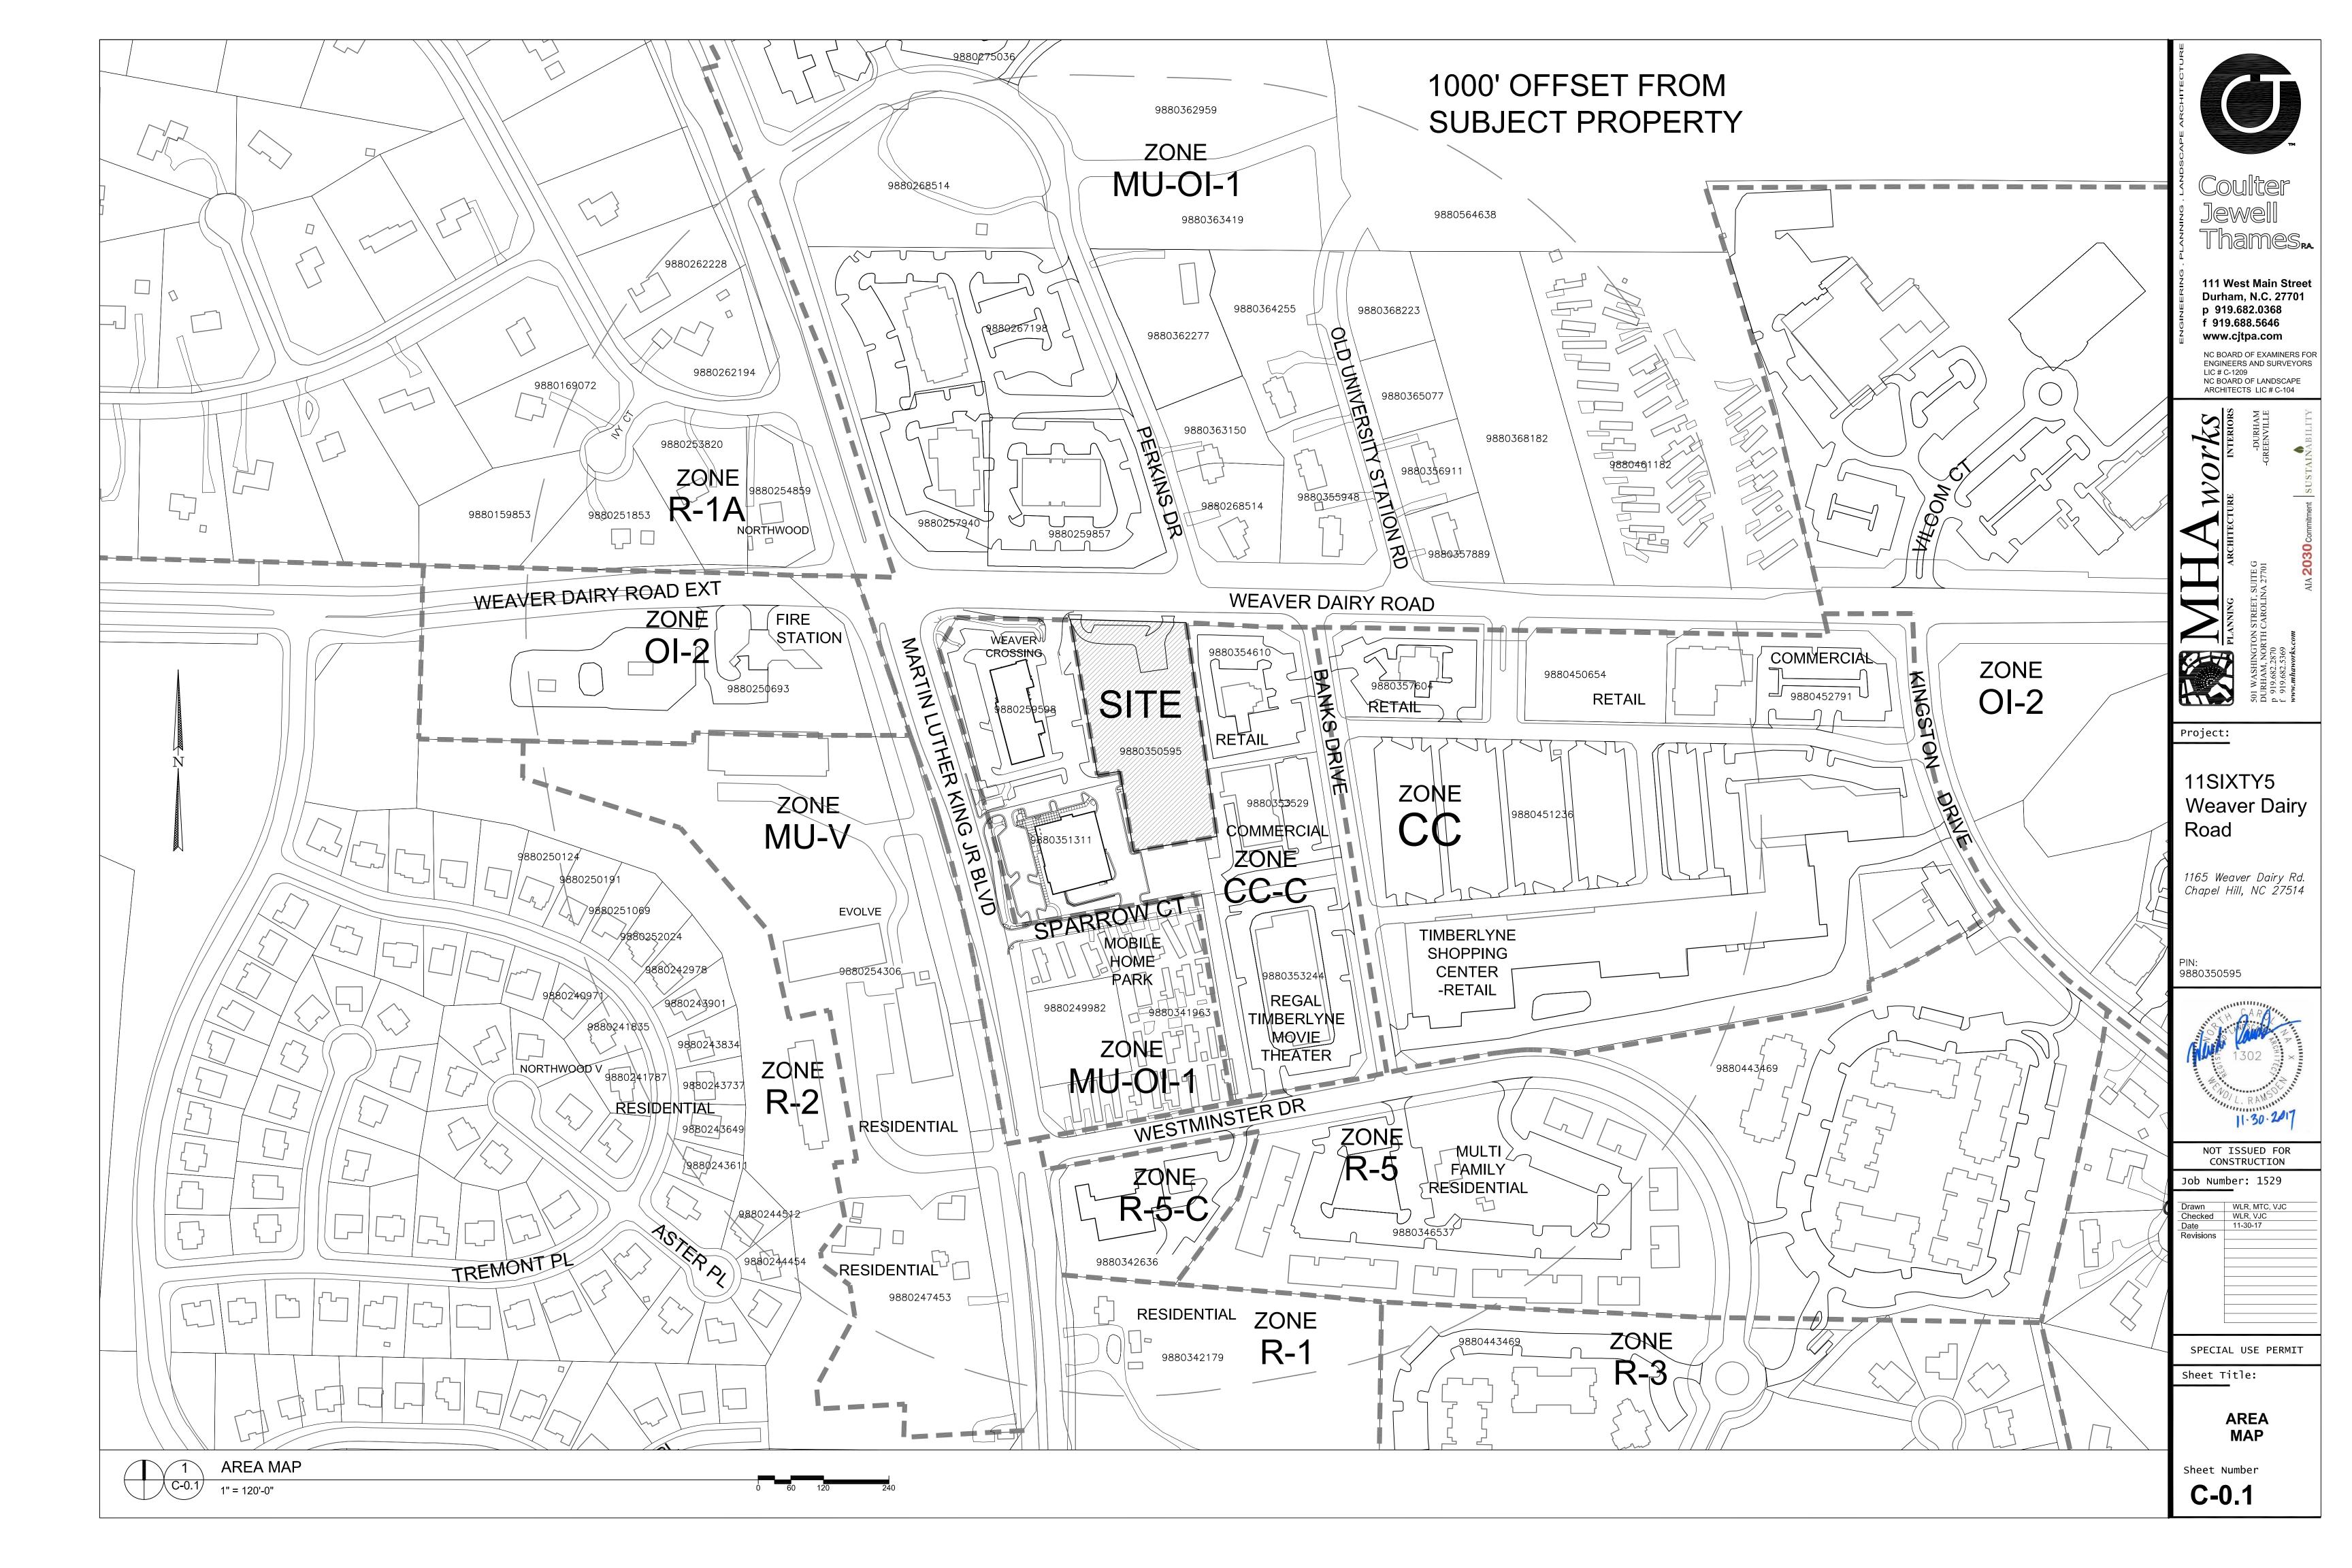



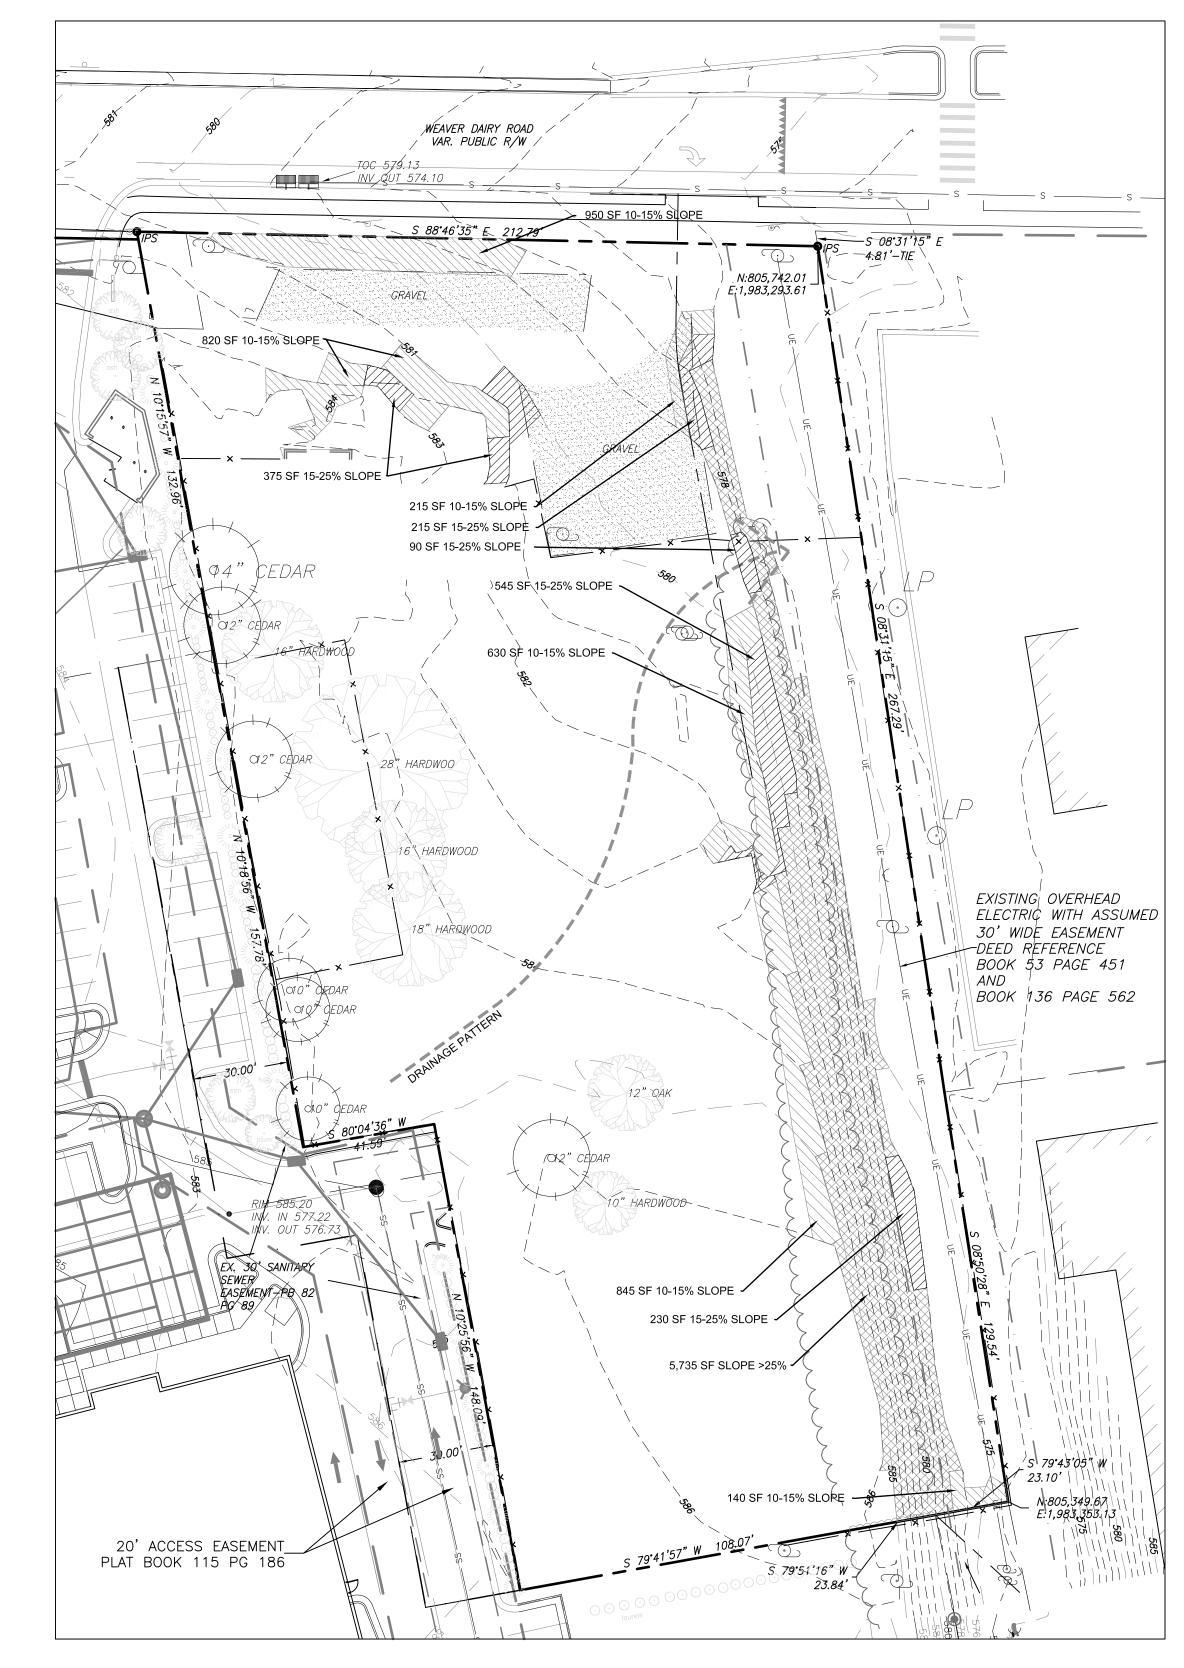

#### **GENERAL:**

THE SITE IS CURRENTLY VACANT WITH FEW SPECIMEN TREES. THERE IS A 40' WIDE ELECTRIC POWER EASEMENT ALONG THE EASTERN PROPERTY LINE.

#### HYDROLOGICAL FEATURES/DRAINAGE THERE ARE NO WATER FEATURES ON THE SITE. THE SITE SITS ON HIGH GROUND AND GENERALLY DRAINS FROM SOUTHWEST TO NORTHEAST.

THE USDA / NRCS WEB SOIL SURVEY CLASSIFIES TWO SOILS ON THIS SITE. THE NORTHERN HALF OF THE SITE IS HrC, A HERDON SILT LOAM WITH 6%-10% SLOPES. THE SOUTH HALF OF THE SITE IS GeB A GEORGEVILLE SILT LOAM WITH 2%-6%

#### FEMA FLOODPLAIN INFORMATION. THERE IS NO MAPPED FLOODPLAIN ON SITE.

SLOPES.

FEMA PANEL 9880.

#### TOPOGRAPHY/SLOPES:

EIGHTLY PERCENT OF THE SITE IS FAIRLY FLAT, WITH AN AVERAGE SLOPE OF ABOUT 3%. THE NORTH PORTION OF THE SITE IS A LITTLE STEEPER AT ABOUT 5-6% SLOPE, AND THE BACK OF THE SITE HAS A FLATTER 2-3% SLOPE.

THE SITE SLOPES FROM SOUTHWEST TO NORTHEAST, AND DROPS APPROXIMATELY 11 FEET OVER THE LENGTH OF THE PARCEL. THE DEVELOPMENT WILL TAKE ADVANTAGE OF THIS DROP BY SETTING PARKING DECK LEVELS TO ACCESS WEAVER DAIRY ROAD GRADES, AND A DIFFERENT ACCESS POINT TO THE ADJACENT WEAVER CROSSING DEVELOPMENT.

THERE ARE STEEP SLOPES ON THE SITE WITHIN THE ELECTRIC EASEMENT. THESE APPEAR TO HAVE BEEN CREATED WHEN THE SITE WAS LEVELED TO BUILD THE FORMER SCHOOL AND / OR EXISTING SHOPPING PLAZA.

#### EXISTING SLOPES:

10-15% = 3,600 SF (4.6% OF THE SITE)15-25% = 1,365 SF (1.7% OF THE SITE)>25% = 5,735 SF (7.3% OF THE SITE) 86.4% OF THE SITE HAS <10% SLOPE

#### SUN/SHADE PATTERNS

THE SUN WILL PASS AROUND THE BACK SIDE OF THE BUILDING AND PARKING STRUCTURE DURING THE COURSE OF THE DAY. THE RETAIL ENTRIES AND THE PLAZA ON THE NORTH SIDE WILL BE IN THE SHADE MOST OF THE DAY. THE OFFICE AND CLINIC ENTRIES ON THE EAST WILL GET THE MORNING SUN. THEY WILL HAVE CANOPIES TO PROTECT PEDESTRIANS FROM SUN AND RAIN. TREES WILL BE ADDED TO THE EAST AND WEST BUILDING FACADE AREAS, AS WELL AS THROUGHOUT THE PEDESTRIAN PLAZA AND ALONG THE SOUTH SIDE OF THE PUBLIC SIDEWALK ON WEAVER DAIRY ROAD.

THE MAJORITY OF PARKING WILL BE IN A DECK. THE FEW SURFACE PARKING SPACES WILL BE SHADED MUCH OF THE DAY BY THE PARKING DECK, AND FROM THE HOT WEST AFTERNOON SUN BY THE BUILDING.



111 West Main Street Durham, N.C. 27701 p 919.682.0368 f 919.688.5646 www.cjtpa.com


NC BOARD OF EXAMINERS FOR ENGINEERS AND SURVEYORS LIC # C-1209 NC BOARD OF LANDSCAPE ARCHITECTS LIC # C-104

Project

### 11SIXTY5 **Weaver Dairy** Road

1165 Weaver Dairy Rd. Chapel Hill, NC 27514

9880350595

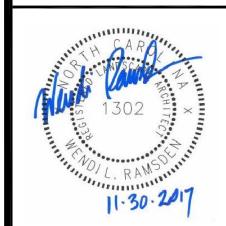

NOT ISSUED FOR CONSTRUCTION

Job Number: 1529

WLR, MTC, VJC Checked WLR, VJC
Date 11-30-17 Revisions


SPECIAL USE PERMIT


Sheet Title:

**EXISTING CONDITIONS** and SITE ANALYSIS

Sheet Number

C-1.0

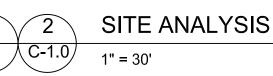

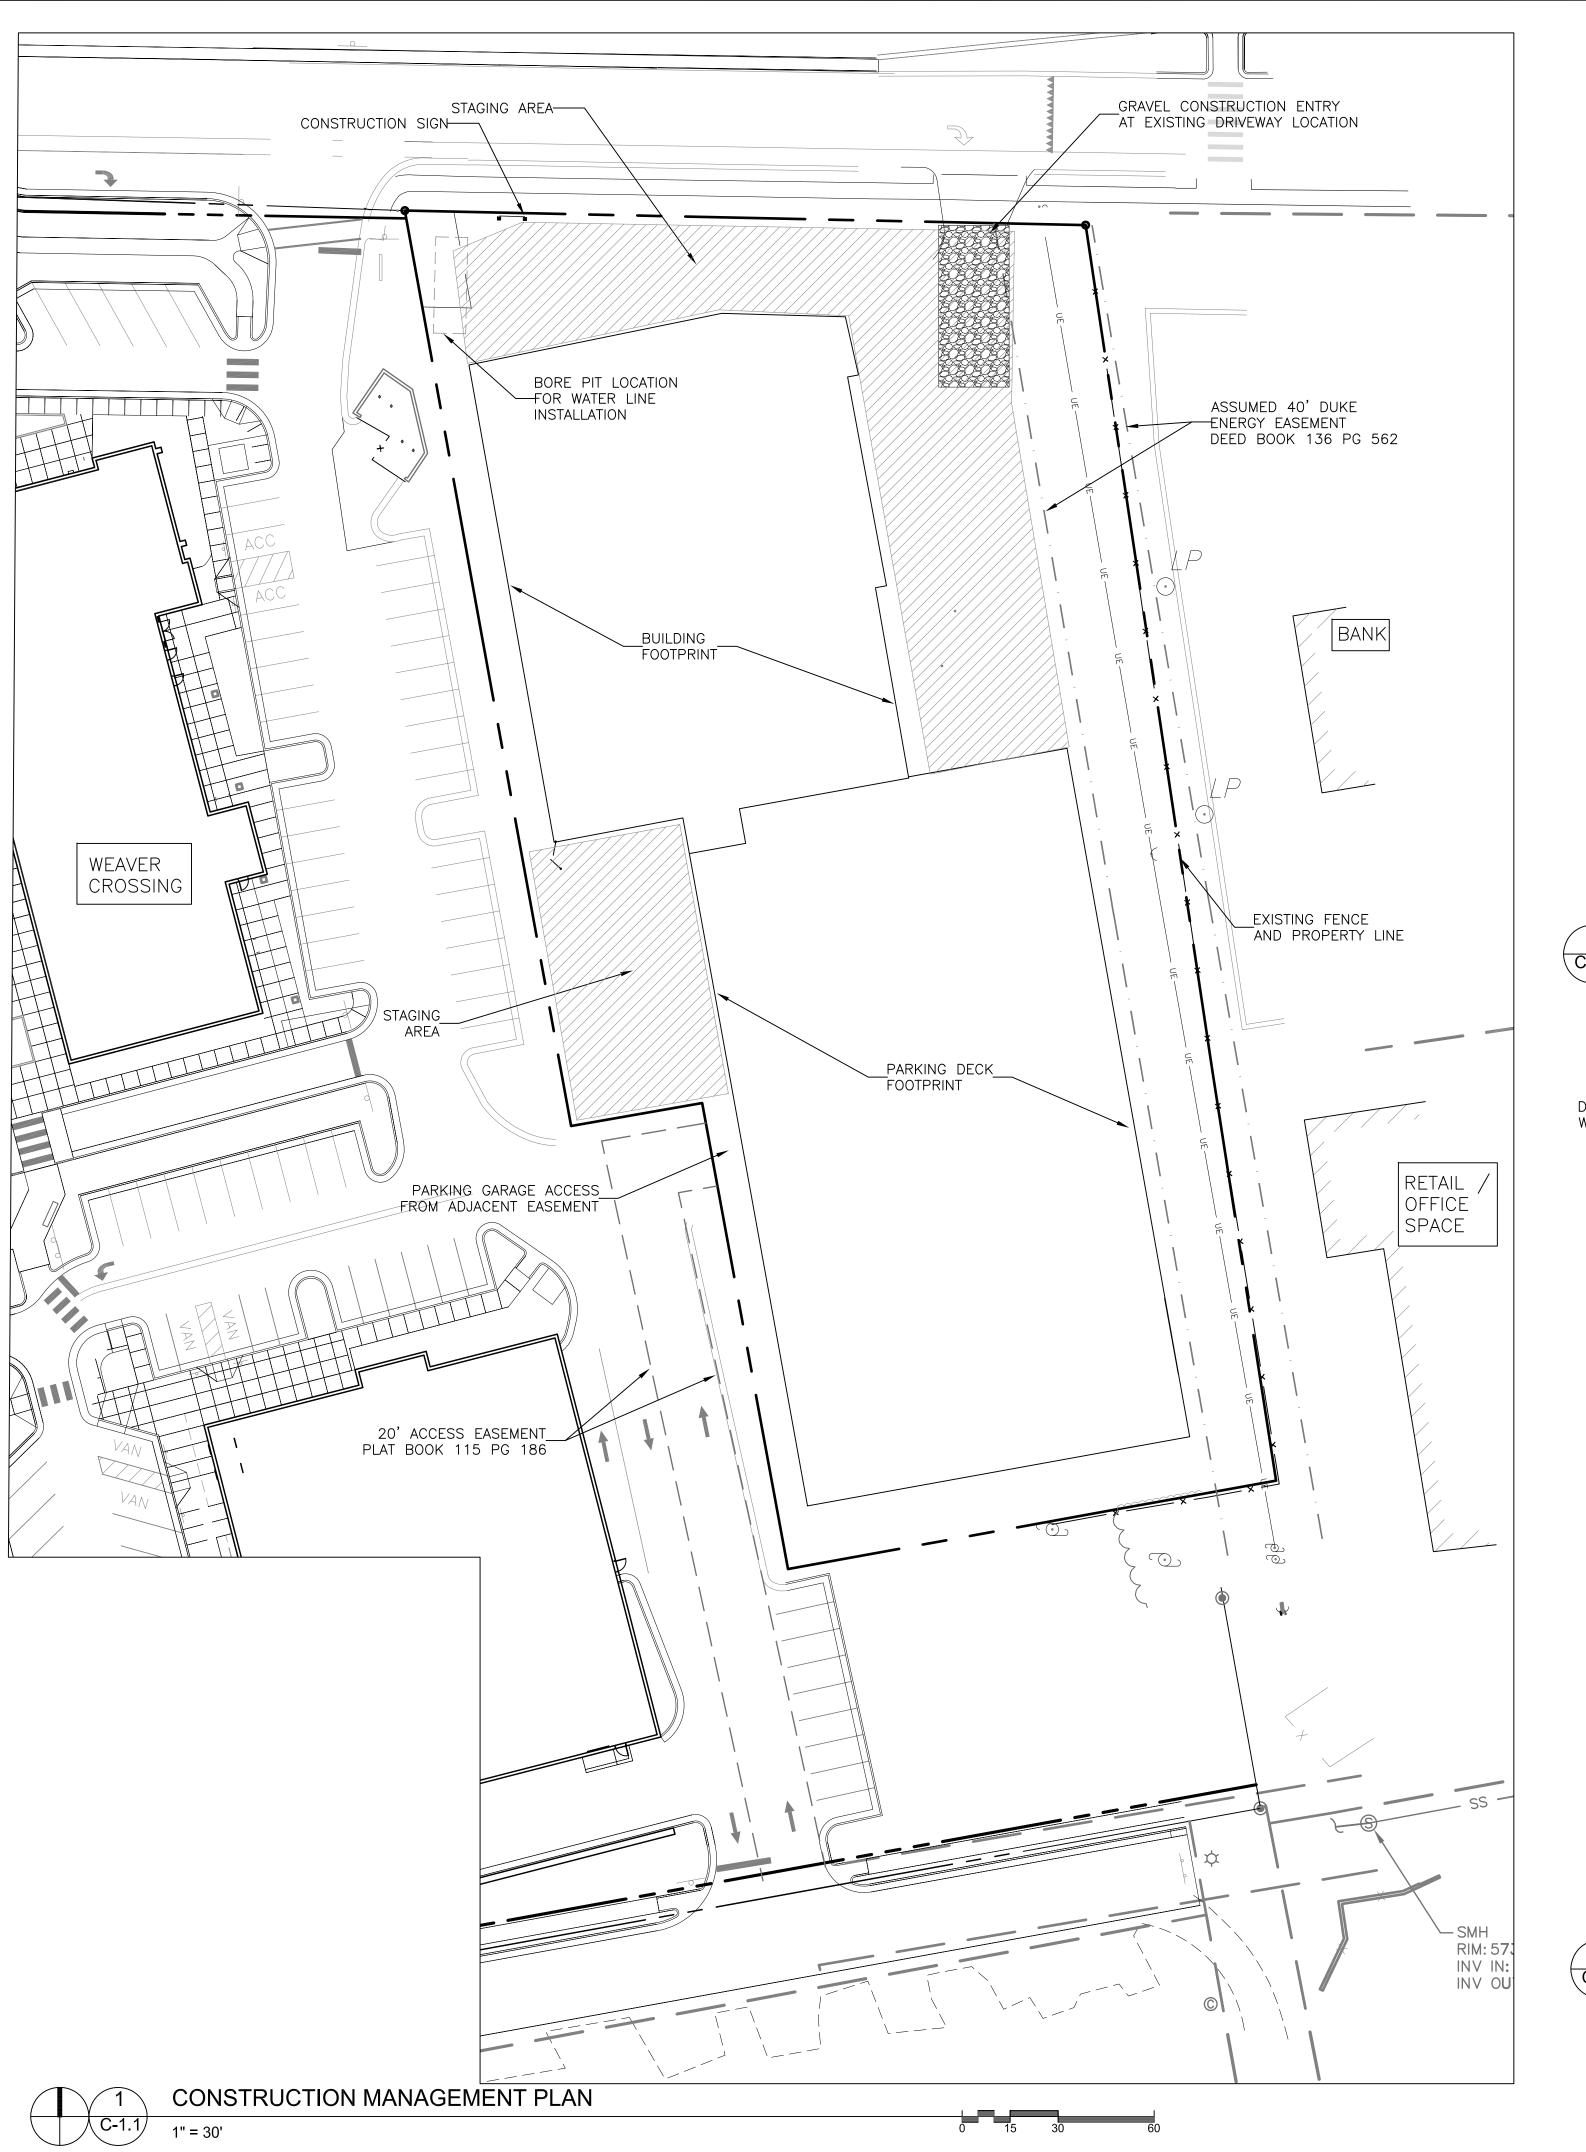

#### TOWN NOISE ORDINANCE:

-COMPLIANCE WITH THE TOWN NOISE ORDINANCE IS REQUIRED DURING THE CONSTRUCTION OF THIS PROJECT.

#### GENERAL CONSTRUCTION NOTES:

-A NCDOT ENCROACHMENT AGREEMENT IS REQUIRED PRIOR TO THE START OF ANY WORK IN THE PUBLIC RIGHT-OF-WAY.

-ALL PUBLIC SITE ELEMENTS MUST COMPLY WITH NCBC 2012 CH 11 AND ICC A 117.1. CONTACT TOWN FOR INSPECTION OF FORMS PRIOR TO PLACING CONCRETE FOR CURB CUTS AND ACCESSIBLE ROUTES. IN ACCORDANCE WITH THESE REGULATIONS, ANY SIDEWALK EXCEEDING 5% SLOPE WILL BE CONSIDERED A RAMP.

#### ON SITE CONSTRUCTION NOTE:

-CURB CUTS AND ACCESSIBLE ROUTES PER ICC A117.1 2009 ED. CROSS SLOPE IS LIMITED TO 1.8%.


#### CONSTRUCTION PARKING NOTE:

-CONSTRUCTION PARKING IS ALLOWED IN CONSTRUCTION STAGING AREAS AND IN THE CONSTRUCTION AREAS ON THE PROJECT SITE DURING THE PROJECT. CONSTRUCTION PARKING WILL NOT BE ALLOWED ON ADJACENT RESIDENTIAL STREETS

#### **CONSTRUCTION STAGING NOTES**

 CONTRACTOR IS TO ARRANGE FOR CONSTRUCTION PARKING WITHIN THE STAGING AREA OR OFF SITE. NO CONSTRUCTION PARKING WILL BE ALLOWED ON ADJACENT RESIDENTIAL STREETS.

## CONSTRUCTION NOTES Output Description: Ou

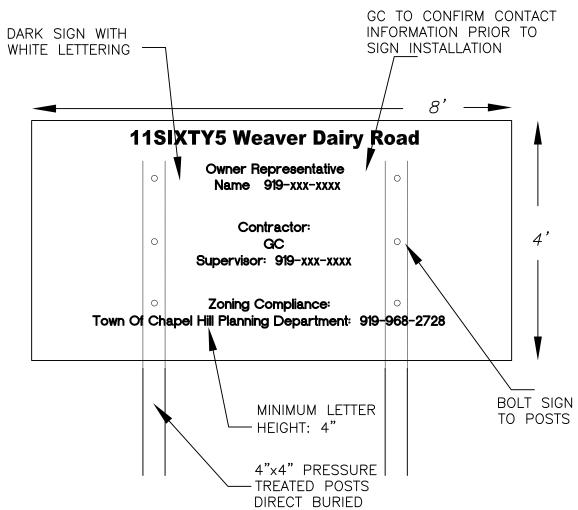

# 1. SIGN IS TO INCLUDE THE FOLLOWING INFORMATION: PROJECT NAME, OWNER CONTACT, CONTRACTOR CONTACT, ZONING COMPLIANCE CONTACT.


- . SIGN IS TO BE A MAXIMUM OF 4' X 8'
  . SIGN IS TO BE REMOVED AT PROJECT COMPLETION
- 3 CONSTRUCTION SIGN


#### FIRE PROTECTION NOTES

- EMERGENCY ACCESS FOR APPARATUS SHALL BE PROVIDED BY THE CONTRACTOR AT ALL TIMES.
- 2. CONTRACTOR SHALL MAINTAIN A FIRE WATCH DURING THE CONSTRUCTION OR DEMOLITION OF "HOT WORK" THAT MAY SUBJECT MATERIALS TO SPONTANEOUS COMBUSTION. THE FIRE WATCH SHALL CONSIST OF AT LEAST ONE PERSON WITH A MEANS OF COMMUNICATING AN ALARM TO 911, SHALL HAVE A WRITTEN ADDRESS POSTED IN A CONSPICUOUS LOCATION, AND SHALL MAINTAIN CONSTANT PATROLS.
- 3. ALL CONSTRUCTION AND DEMOLITION SHALL COMPLY WITH THE CURRENT EDITION OF CHAPTER 14 OF THE NC FPC (FIRE CODE).
- 4. ANY PERMANENT OR TEMPORARY GATES ACROSS FIRE ACCESS DRIVES SHALL BE A MINIMUM WIDTH OF 20', EITHER SWINGING OR SLIDING TYPE, HAVE AN EMERGENCY MEANS OF OPERATION, AND SHALL BE OPERABLE BY EITHER FORCIBLE ENTRY OR KEYED, CAPABLE OF BEING OPERATED BY ONE PERSON, AND SHALL BE INSTALLED AND MAINTAINED ACCORDING TO UL 325 AND ASTM F 2200 NC FPC 2012.

#### TRAFFIC/PEDESTRIAN CONTROL NOTES

- 1. SIGNS SHOWN ON THIS PLAN ARE REQUIRED DURING THE CONSTRUCTION OF THIS PROJECT.
- 2. CONSTRUCTION WILL REQUIRE TEMPORARY SIDEWALK AND LANE CLOSURES ON WEAVER DAIRY ROAD.
- 3. NOTIFY TOWN OF CHAPEL HILL ENGINEERING DEPARTMENT AT 919-968-2833, MINIMUM 72 HOUR NOTICE IS REQUIRED.
- 4. ALL WORK ZONE SIGNAGE SHALL COMPLY WITH APPLICABLE M.U.T.C.D. STANDARDS AND DETAILS.
- 5. TEMPORARY LANE CLOSURES ARE ONLY ALLOWED DURING DAYLIGHT HOURS AND A FLAGMAN MUST BE PRESENT AT ALL TIMES WHEN WORK IS OCCURRING IN THE TRAFFIC LANES.
- 6. PRIOR TO ANY TRAFFIC LANE CLOSURES, IT WILL BE NECESSARY TO CONTACT ERNIE ROGERS AT 919-968-2833, OF THE CHAPEL HILL ENGINEERING DIVISION, AT LEAST 5 WORKING DAYS BEFORE THE PROPOSED WORK TO APPLY FOR A LANE CLOSURE PERMIT.
- 7. SIGNS AND TEMPORARY BARRICADES AS SHOWN BELOW WILL BE PLACED TO DIRECT PEDESTRIANS WHEN SIDEWALKS ARE IN THE CONSTRUCTION AREAS.

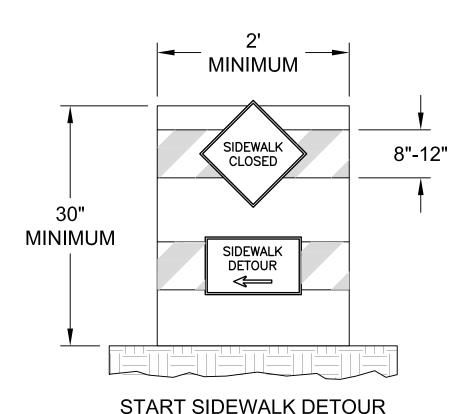

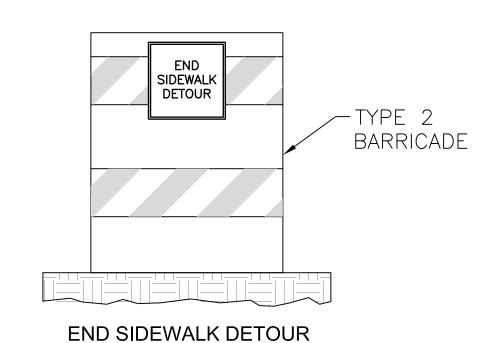



Coulter
Jewell
Thames

111 West Main Street Durham, N.C. 27701 p 919.682.0368 f 919.688.5646 www.cjtpa.com

NC BOARD OF EXAMINERS FOR ENGINEERS AND SURVEYORS LIC # C-1209 NC BOARD OF LANDSCAPE ARCHITECTS LIC # C-104

IG ARCHITECTURE INTERIORS
ET, SUITE G
-DURHAM
LINA 27701
-AIA 2030 Commitment SIISTAINARIITTE


PLANNING
S01 WASHINGTON STREET, SUI
DURHAM, NORTH CAROLINA 2
p 919,682.2870
f 919,682.5369
www.mhaworks.com

Project:

11SIXTY5 Weaver Dairy Road

1165 Weaver Dairy Rd. Chapel Hill, NC 27514

PIN:

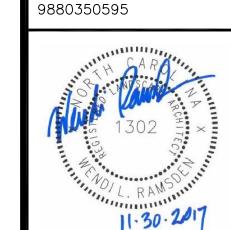

NOT ISSUED FOR CONSTRUCTION

Drawn WLR, MTC, VJC
Checked WLR, VJC
Date 11-30-17
Revisions

Date 11-30-17
Revisions


SPECIAL USE PERMIT

Sheet Title:

CONSTRUCTION MANAGEMENT PLAN


Sheet Number


C-1.1

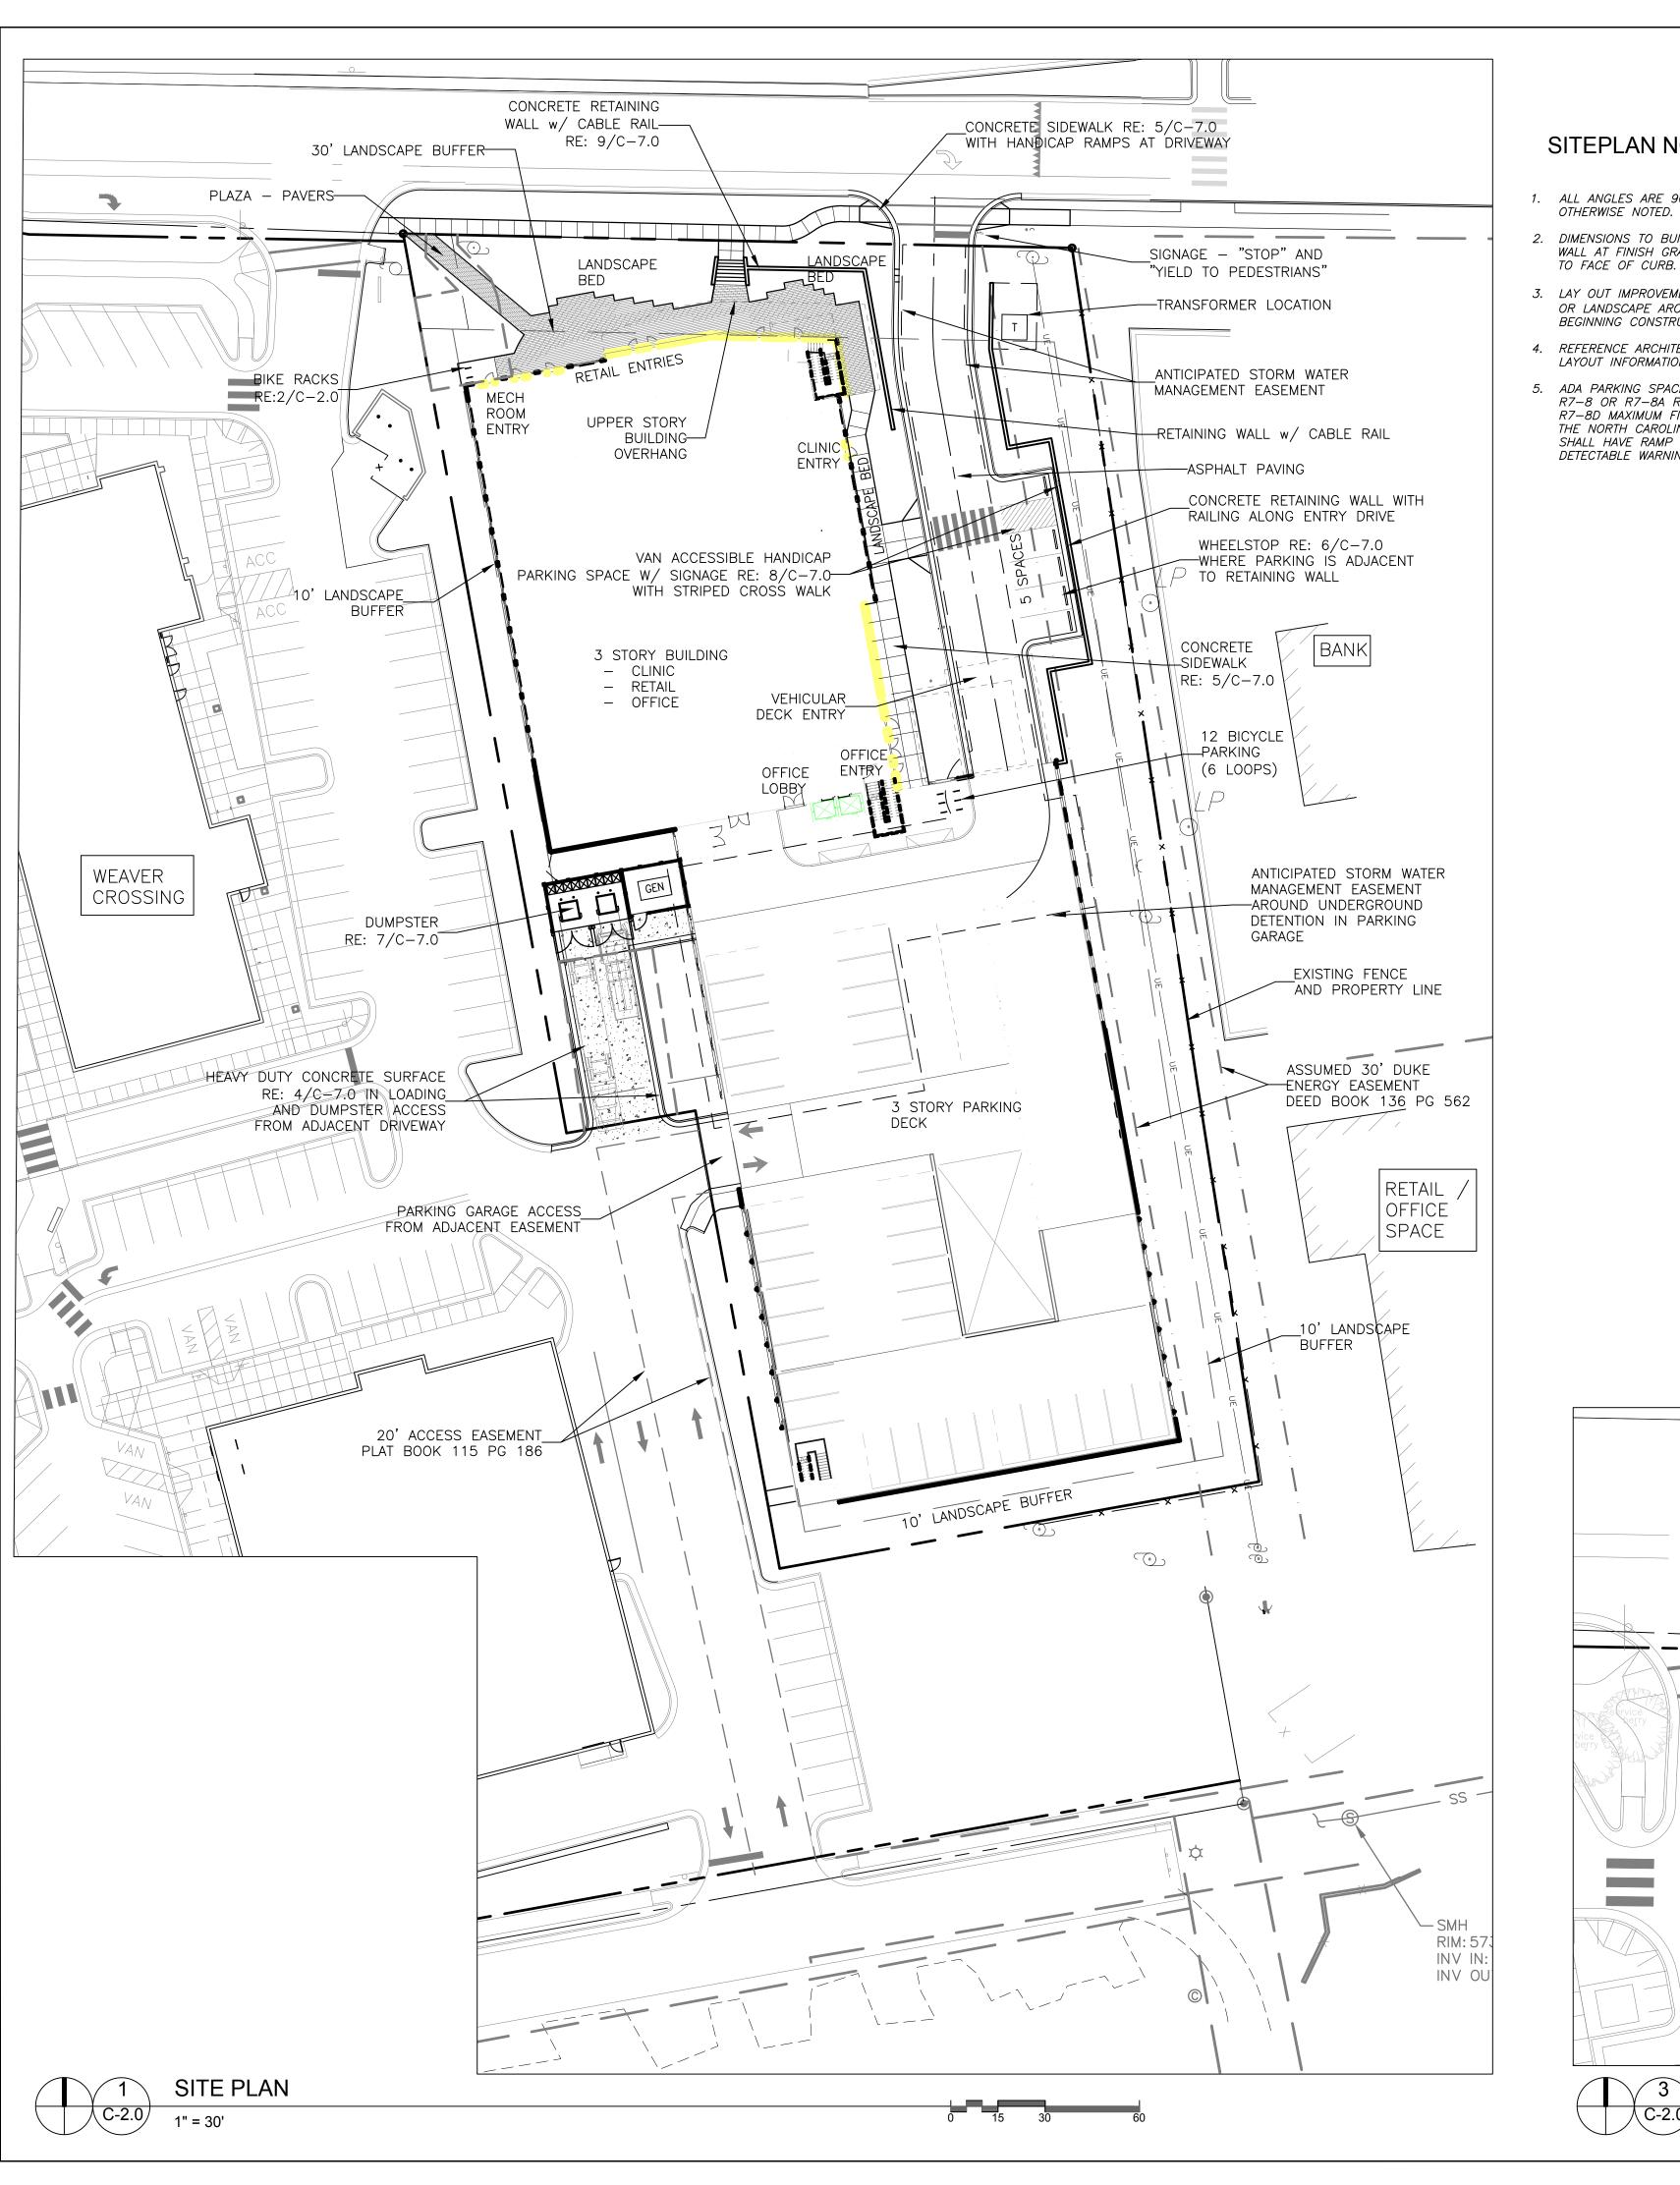

#### SITEPLAN NOTES

- 1. ALL ANGLES ARE 90 DEGREES UNLESS
- 2. DIMENSIONS TO BUILDING WALL ARE TO FACE OF WALL AT FINISH GRADE. DIMENSIONS TO CURB ARE TO FACE OF CURB.
- 3. LAY OUT IMPROVEMENTS FOR THE CIVIL ENGINEER'S OR LANDSCAPE ARCHITECT'S REVIEW PRIOR TO BEGINNING CONSTRUCTION.
- 4. REFERENCE ARCHITECTURAL DRAWINGS FOR BUILDING LAYOUT INFORMATION.
- 5. ADA PARKING SPACES SHALL BE SIGNED WITH TYPE R7-8 OR R7-8A RESERVED PARKING SIGN AND R7-8D MAXIMUM FINE SIGN PER GS 20-37.6 OF THE NORTH CAROLINA HANDICAP CODE. ADA RAMPS SHALL HAVE RAMP SURFACES COVERED WITH DETECTABLE WARNING PATTERN PER ADA STANDARDS.

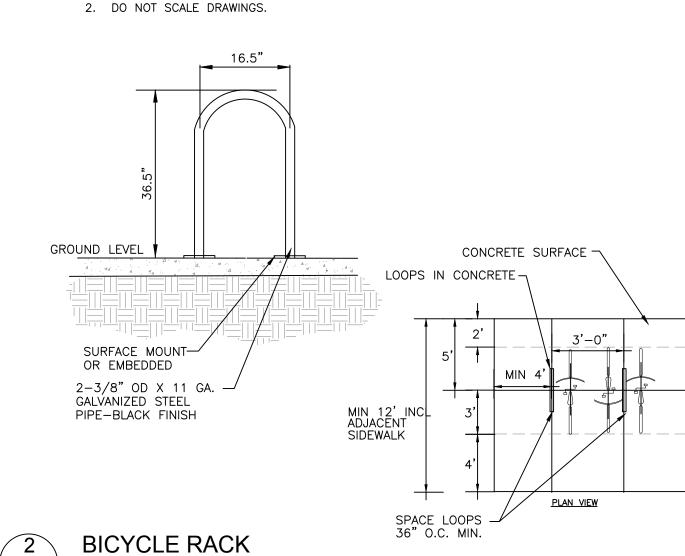

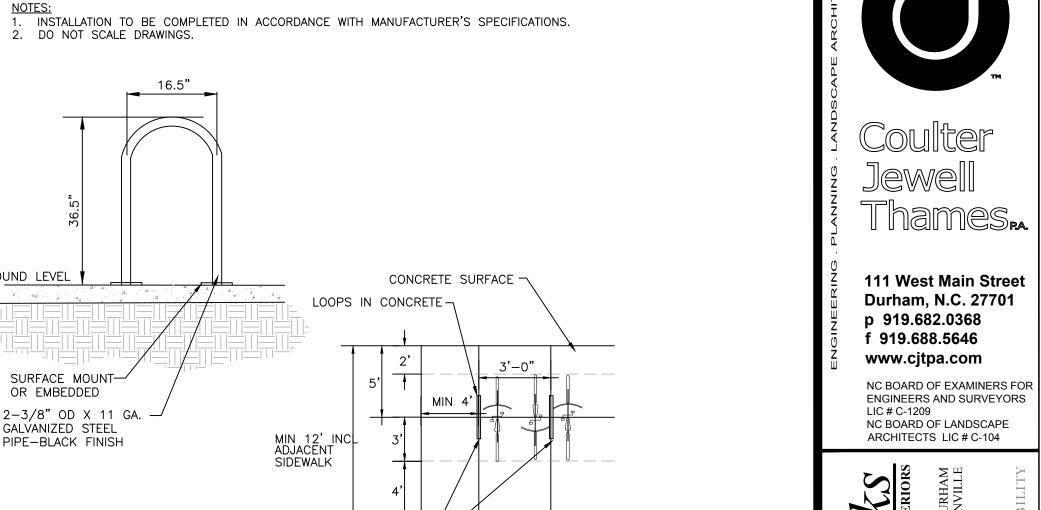




Project:

11SIXTY5 Weaver Dairy Road

1165 Weaver Dairy Rd. Chapel Hill, NC 27514

PIN: 9880350595

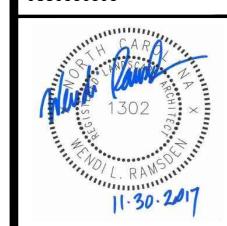

NOT ISSUED FOR CONSTRUCTION


Job Number: 1529 Drawn WLR, MTC, VJC
Checked WLR, VJC
Date 11-30-17
Revisions

SPECIAL USE PERMIT


Sheet Title:


SITE PLAN


Sheet Number C-2.0

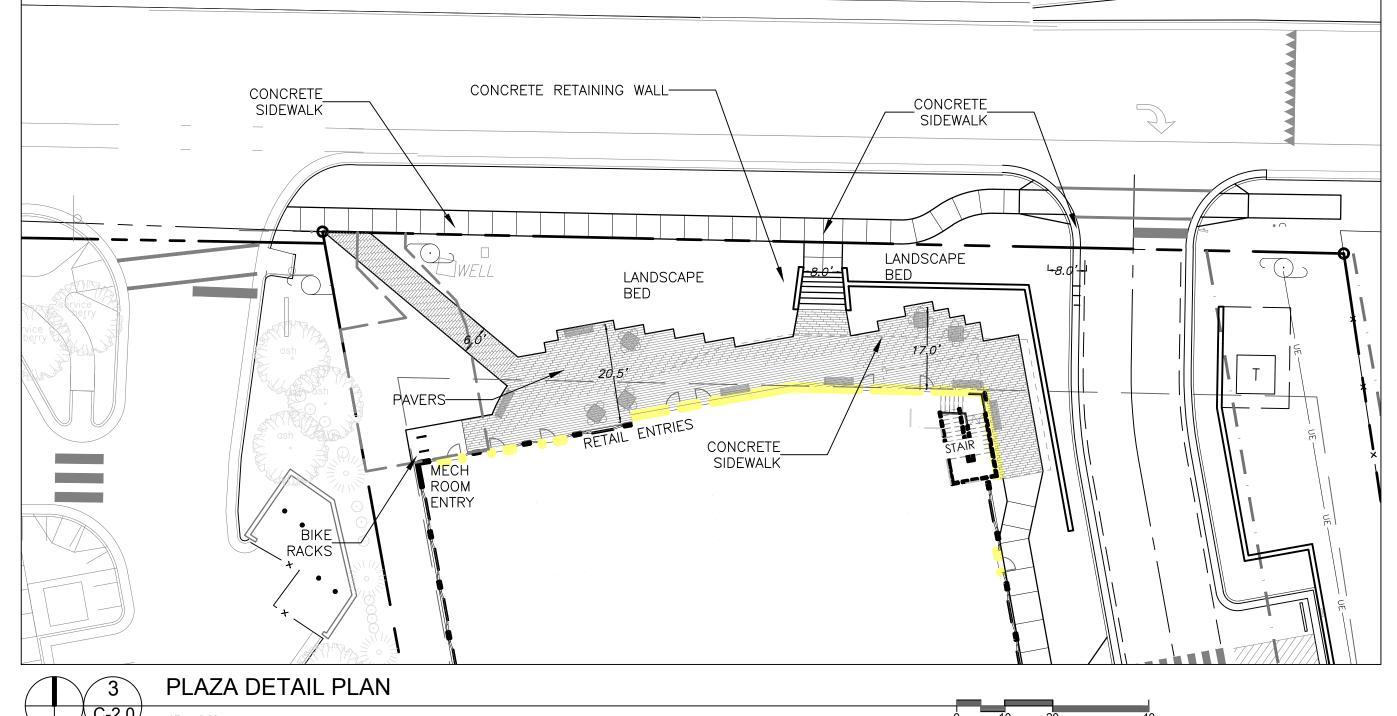

C-2.0

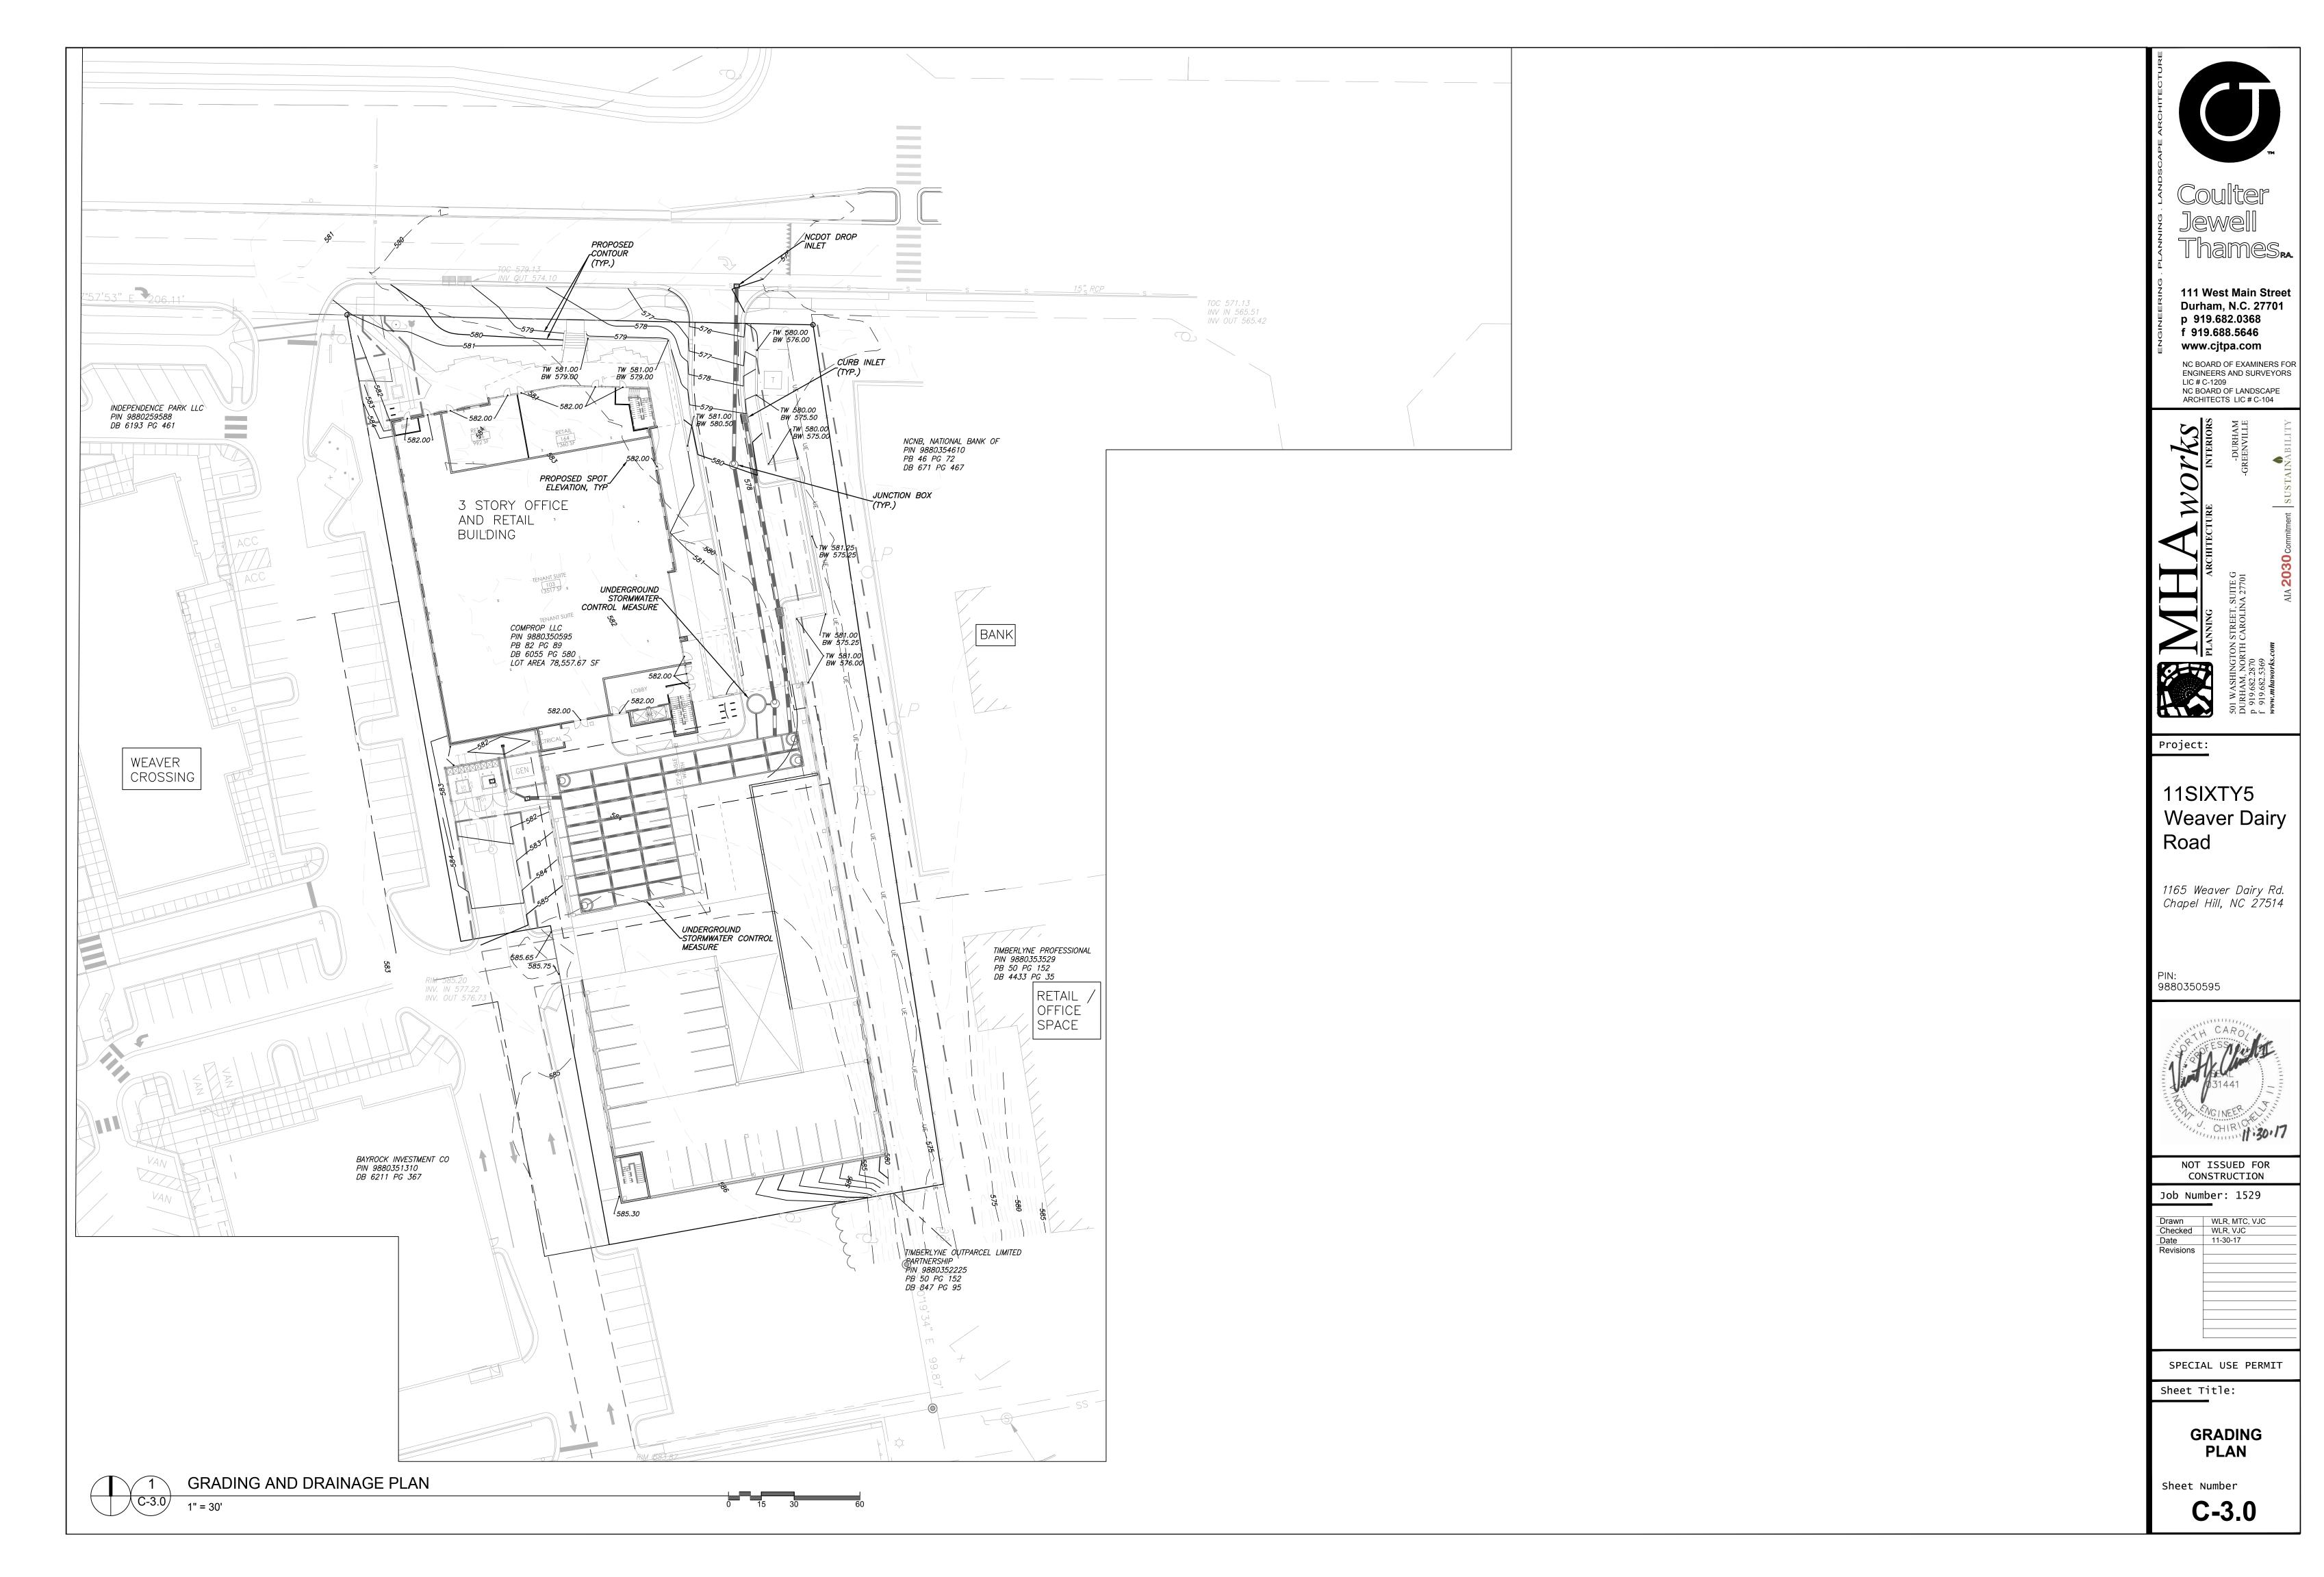

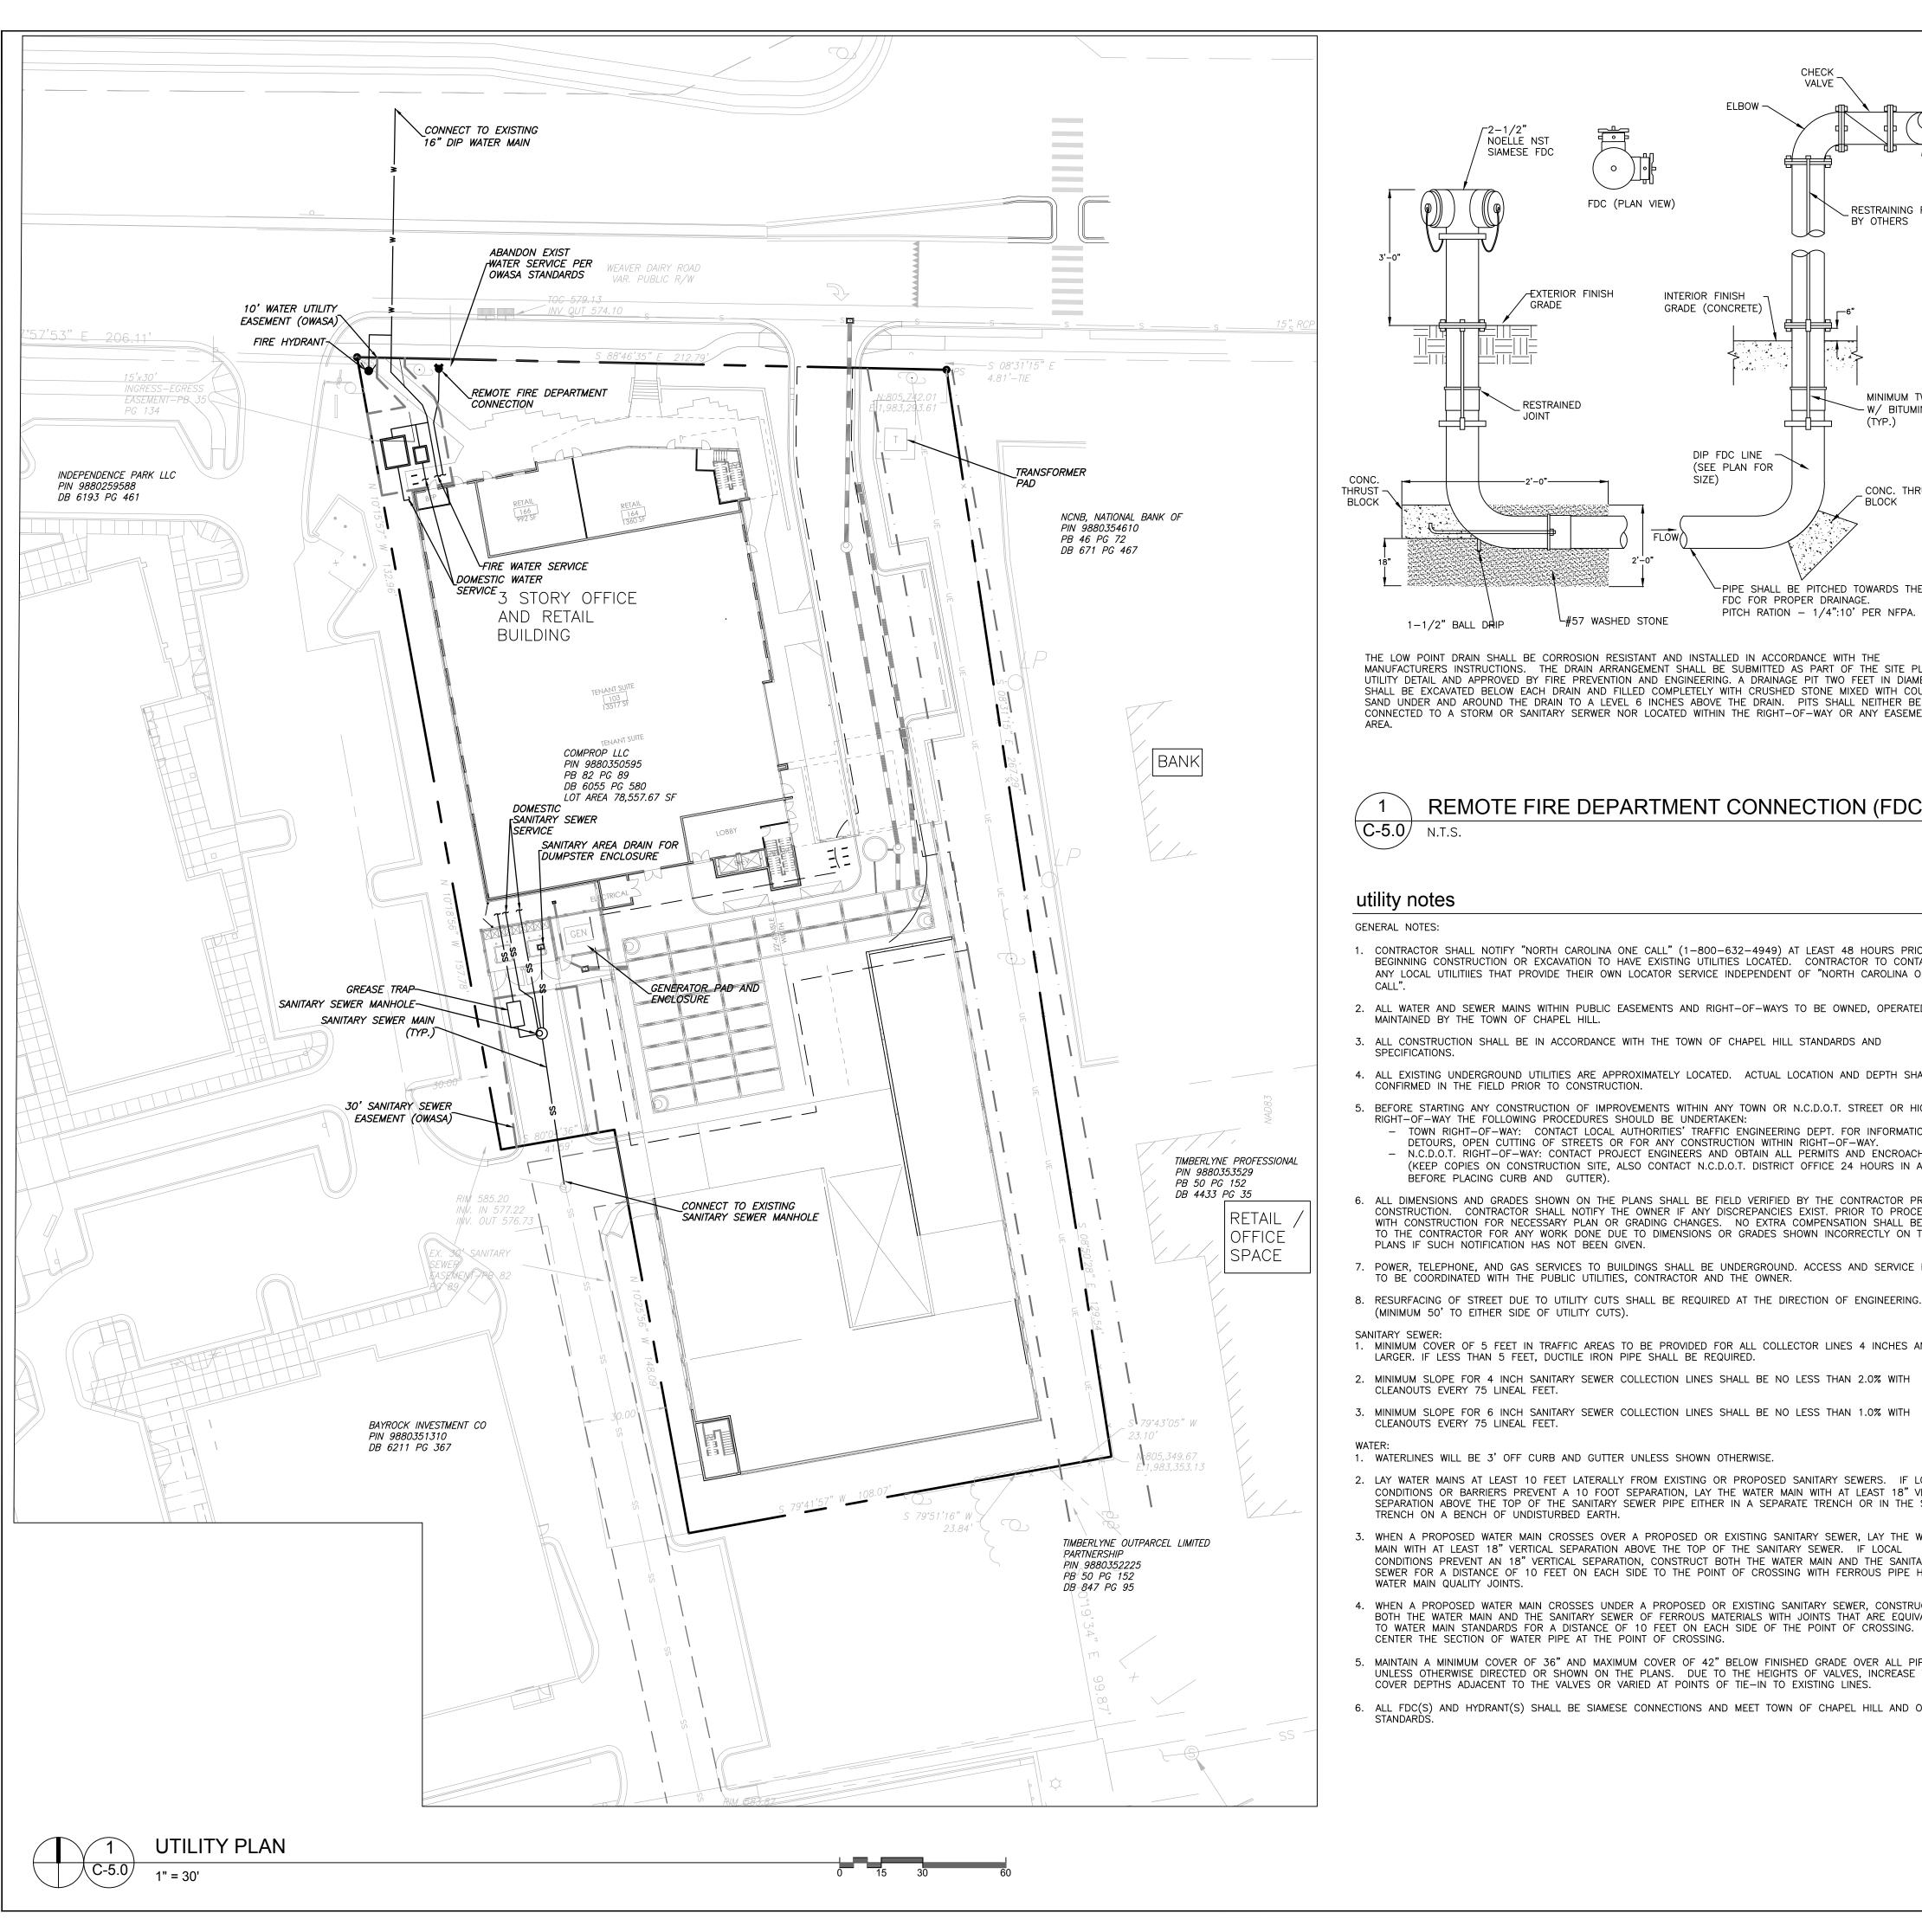

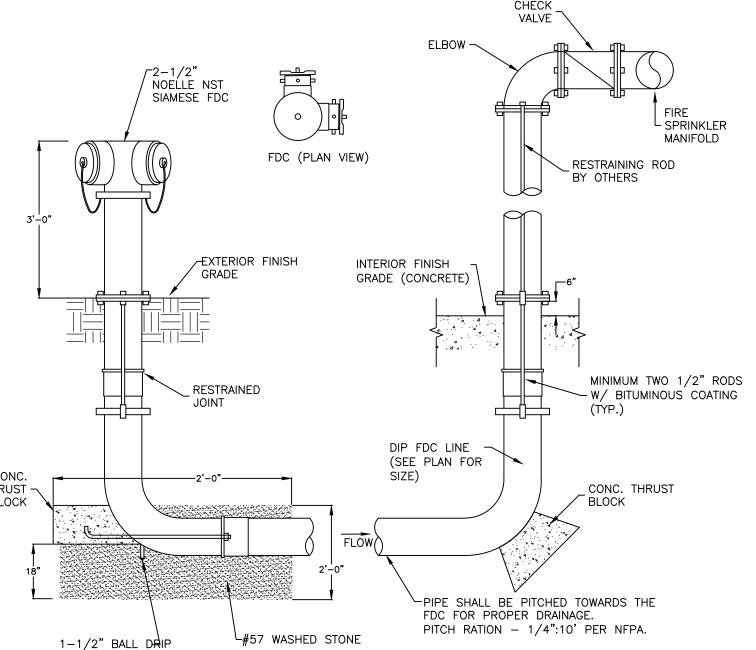

THE LOW POINT DRAIN SHALL BE CORROSION RESISTANT AND INSTALLED IN ACCORDANCE WITH THE MANUFACTURERS INSTRUCTIONS. THE DRAIN ARRANGEMENT SHALL BE SUBMITTED AS PART OF THE SITE PLAN UTILITY DETAIL AND APPROVED BY FIRE PREVENTION AND ENGINEERING, A DRAINAGE PIT TWO FEET IN DIAMETER SHALL BE EXCAVATED BELOW EACH DRAIN AND FILLED COMPLETELY WITH CRUSHED STONE MIXED WITH COURSE SAND UNDER AND AROUND THE DRAIN TO A LEVEL 6 INCHES ABOVE THE DRAIN. PITS SHALL NEITHER BE CONNECTED TO A STORM OR SANITARY SERWER NOR LOCATED WITHIN THE RIGHT-OF-WAY OR ANY EASEMENT

#### REMOTE FIRE DEPARTMENT CONNECTION (FDC) **C-5.0** N.T.S.


#### utility notes

#### GENERAL NOTES:

- 1. CONTRACTOR SHALL NOTIFY "NORTH CAROLINA ONE CALL" (1-800-632-4949) AT LEAST 48 HOURS PRIOR TO BEGINNING CONSTRUCTION OR EXCAVATION TO HAVE EXISTING UTILITIES LOCATED. CONTRACTOR TO CONTACT ANY LOCAL UTILITIES THAT PROVIDE THEIR OWN LOCATOR SERVICE INDEPENDENT OF "NORTH CAROLINA ONE
- 2. ALL WATER AND SEWER MAINS WITHIN PUBLIC EASEMENTS AND RIGHT-OF-WAYS TO BE OWNED, OPERATED AND MAINTAINED BY THE TOWN OF CHAPEL HILL.
- 3. ALL CONSTRUCTION SHALL BE IN ACCORDANCE WITH THE TOWN OF CHAPEL HILL STANDARDS AND
- 4. ALL EXISTING UNDERGROUND UTILITIES ARE APPROXIMATELY LOCATED. ACTUAL LOCATION AND DEPTH SHALL BE CONFIRMED IN THE FIELD PRIOR TO CONSTRUCTION.
- . BEFORE STARTING ANY CONSTRUCTION OF IMPROVEMENTS WITHIN ANY TOWN OR N.C.D.O.T. STREET OR HIGHWAY RIGHT-OF-WAY THE FOLLOWING PROCEDURES SHOULD BE UNDERTAKEN: - TOWN RIGHT-OF-WAY: CONTACT LOCAL AUTHORITIES' TRAFFIC ENGINEERING DEPT. FOR INFORMATION ON DETOURS, OPEN CUTTING OF STREETS OR FOR ANY CONSTRUCTION WITHIN RIGHT-OF-WAY. - N.C.D.O.T. RIGHT-OF-WAY: CONTACT PROJECT ENGINEERS AND OBTAIN ALL PERMITS AND ENCROACHMENTS (KEEP COPIES ON CONSTRUCTION SITE, ALSO CONTACT N.C.D.O.T. DISTRICT OFFICE 24 HOURS IN ADVANCE BEFORE PLACING CURB AND GUTTER).
- 6. ALL DIMENSIONS AND GRADES SHOWN ON THE PLANS SHALL BE FIELD VERIFIED BY THE CONTRACTOR PRIOR TO CONSTRUCTION. CONTRACTOR SHALL NOTIFY THE OWNER IF ANY DISCREPANCIES EXIST. PRIOR TO PROCEEDING WITH CONSTRUCTION FOR NECESSARY PLAN OR GRADING CHANGES. NO EXTRA COMPENSATION SHALL BE PAID TO THE CONTRACTOR FOR ANY WORK DONE DUE TO DIMENSIONS OR GRADES SHOWN INCORRECTLY ON THESE PLANS IF SUCH NOTIFICATION HAS NOT BEEN GIVEN.
- 7. POWER, TELEPHONE, AND GAS SERVICES TO BUILDINGS SHALL BE UNDERGROUND. ACCESS AND SERVICE ROUTES TO BE COORDINATED WITH THE PUBLIC UTILITIES, CONTRACTOR AND THE OWNER.
- (MINIMUM 50' TO EITHER SIDE OF UTILITY CUTS). SANITARY SEWER:
- 1. MINIMUM COVER OF 5 FEET IN TRAFFIC AREAS TO BE PROVIDED FOR ALL COLLECTOR LINES 4 INCHES AND LARGER. IF LESS THAN 5 FEET, DUCTILE IRON PIPE SHALL BE REQUIRED.
- 2. MINIMUM SLOPE FOR 4 INCH SANITARY SEWER COLLECTION LINES SHALL BE NO LESS THAN 2.0% WITH CLEANOUTS EVERY 75 LINEAL FEET.
- 3. MINIMUM SLOPE FOR 6 INCH SANITARY SEWER COLLECTION LINES SHALL BE NO LESS THAN 1.0% WITH CLEANOUTS EVERY 75 LINEAL FEET.

#### 1. WATERLINES WILL BE 3' OFF CURB AND GUTTER UNLESS SHOWN OTHERWISE.

- 2. LAY WATER MAINS AT LEAST 10 FEET LATERALLY FROM EXISTING OR PROPOSED SANITARY SEWERS. IF LOCAL CONDITIONS OR BARRIERS PREVENT A 10 FOOT SEPARATION, LAY THE WATER MAIN WITH AT LEAST 18" VERTICAL SEPARATION ABOVE THE TOP OF THE SANITARY SEWER PIPE EITHER IN A SEPARATE TRENCH OR IN THE SAME TRENCH ON A BENCH OF UNDISTURBED EARTH.
- 3. WHEN A PROPOSED WATER MAIN CROSSES OVER A PROPOSED OR EXISTING SANITARY SEWER, LAY THE WATER MAIN WITH AT LEAST 18" VERTICAL SEPARATION ABOVE THE TOP OF THE SANITARY SEWER. IF LOCAL CONDITIONS PREVENT AN 18" VERTICAL SEPARATION, CONSTRUCT BOTH THE WATER MAIN AND THE SANITARY SEWER FOR A DISTANCE OF 10 FEET ON EACH SIDE TO THE POINT OF CROSSING WITH FERROUS PIPE HAVING WATER MAIN QUALITY JOINTS.
- 4. WHEN A PROPOSED WATER MAIN CROSSES UNDER A PROPOSED OR EXISTING SANITARY SEWER, CONSTRUCT BOTH THE WATER MAIN AND THE SANITARY SEWER OF FERROUS MATERIALS WITH JOINTS THAT ARE EQUIVALENT TO WATER MAIN STANDARDS FOR A DISTANCE OF 10 FEET ON EACH SIDE OF THE POINT OF CROSSING. CENTER THE SECTION OF WATER PIPE AT THE POINT OF CROSSING.
- 5. MAINTAIN A MINIMUM COVER OF 36" AND MAXIMUM COVER OF 42" BELOW FINISHED GRADE OVER ALL PIPES UNLESS OTHERWISE DIRECTED OR SHOWN ON THE PLANS. DUE TO THE HEIGHTS OF VALVES, INCREASE THE COVER DEPTHS ADJACENT TO THE VALVES OR VARIED AT POINTS OF TIE-IN TO EXISTING LINES.
- 6. ALL FDC(S) AND HYDRANT(S) SHALL BE SIAMESE CONNECTIONS AND MEET TOWN OF CHAPEL HILL AND OWASA STANDARĎŚ.

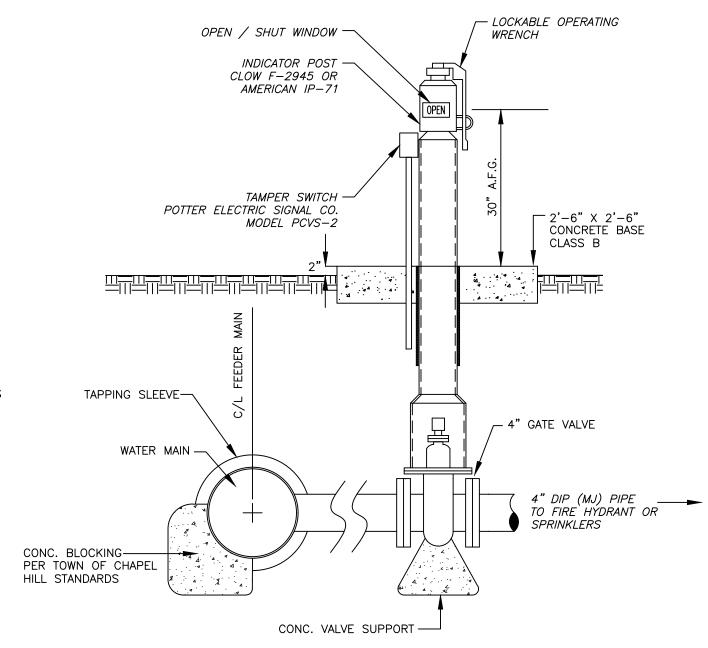

COMPLY WITH NFPA 13 AND NFPA 24 FOR INSTALLATION. PROVIDE TAR PAPER BETWEEN HYDRANT AND HYDRANT THRUST BLOCK.


ALL THRUST BLOCKS AND SUPPORTING CONCRETE TO BE CLASS B. THE CONTRACTOR IS REQUIRED TO RUN UNDERGROUND CONDUITS TO THE POST INDICATOR VALVE, SO THAT IT CAN BE MONITORED VIA TAMPER SWITCH BY THE FIRE ALARM SYSTEM. PROVIDE (2) 1" CONDUITS FROM SPRINKLER VALVE ROOM TO PIV.

#### POST INDICATOR VALVE (PIV) C-5.0 N.T.S.

#### fire protection notes

PROPER ORDER FORM.

- 1. PROVIDE EMERGENCY VEHICLE ACCESS TO THE SITE DURING CONSTRUCTION.
- 2. WHEN FENCING IS PROVIDED AROUND PROJECTS DURING CONSTRUCTION, PROVIDE A MINIMUM OF 20' SWING OR SLIDE GATE FOR EMERGENCY VEHICLE ACCESS.
- 3. FIRE APPARATUS ACCESS ROADS SHALL BE ALL WEATHER AND DESIGNED TO CARRY THE IMPOSED LOAD OF FIRE APPARATUS WEIGHING AT LEAST 80,000 LBS.
- 4. FIRE APPARATUS ACCESS ROADS SHALL HAVE A MINIMUM WIDTH OF 20' WITH AN OVERHEAD CLEARANCE OF AT LEAST 13'-6" FOR STRUCTURES NOT EXCEEDING 30' IN HEIGHT AND SHALL PROVIDE ACCESS TO WITHIN 150' OF ALL EXTERIOR PORTIONS OF THE BUILDING.
- 5. FIRE APPARATUS ACCESS ROADS SHALL NOT EXCEED 10% IN GRADE.
- 6. PRIVATE FIRE MAINS SERVING THE SPRINKLER SYSTEM SHALL BE INSTALLED PER NFPA 24. THE FIRE MAIN SHALL BE FLUSHED PER NFPA 24 AND WITNESSED BY A FIRE INSPECTOR FROM CHAPEL HILL FIRE DEPARTMENT PRIOR TO COVERING THE LINE.
- 7. KEY BOX WILL BE REQUIRED FOR THIS PROJECT. PLEASE CONTACT CHRIS KEARNS AT CHFD FOR

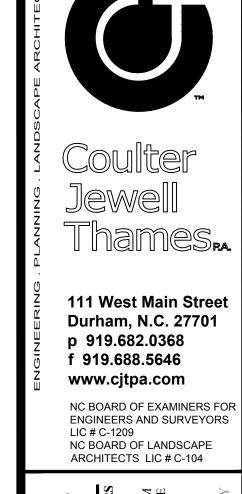




Project:

## 11SIXTY5 Weaver Dairy

1165 Weaver Dairy Rd. Chapel Hill, NC 27514

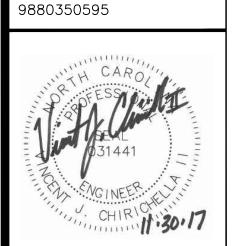

NOT ISSUED FOR CONSTRUCTION

Job Num	ber: 1529		
Drawn	WLR, MTC, VJC		
Checked	WLR, VJC		
Date	11-30-17		
Revisions			

SPECIAL USE PERMIT


Sheet Title:

UTILITY **PLAN** 

Sheet Number C-5.0

-CONTRACTION JOINTS SHALL BE SPACED AT 10 FOOT INTERVALS. EXCEPT THAT A 15 FOOT SPACING MAY BE USED WHEN A MACHINE IS USED OR WHEN SATISFACTORY SUPPORT FOR THE FACE FORM CAN BE OBTAINED WITHOUT THE USE OF TEMPLATES AT 10 FOOT INTERVALS. JOINT SPACING MAY BE ALTERED BY THE ENGINEER TO PREVENT -CONTRACTION JOINTS MAY BE INSTALLED BY THE USE OF TEMPLATES OR FORMED BY OTHER APPROVED METHODS. WHERE SUCH JOINTS ARE NOT FORMED BY TEMPLATES, A MINIMUM DEPTH OF 1 1/2" SHALL BE MAINTAINED. -ALL CONTRACTION JOINTS SHALL BE FILLED WITH JOINT FILLER.


-JOINTS SHALL MATCH LOCATIONS WITH JOINT IN ABUTTING SIDEWALK. -EXPANSION JOINTS SHALL BE SPACED AT 90 FOOT INTERVALS AND ADJACENT TO ALL RIGID OBJECTS.

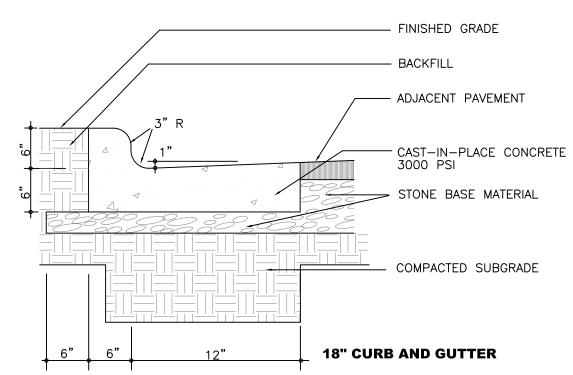

NOTE THAT THIS DETAIL DOES NOT MEET NC DOT REQUIREMENTS. ANY CURB AND GUTTER TO BE CONSTRUCTED IN THE OLD MASON FARM ROAD RIGHT OF WAY IS TO FOLLOW NC DOT STANDARDS RE: 2/C700



#### ON SITE CURB AND GUTTER

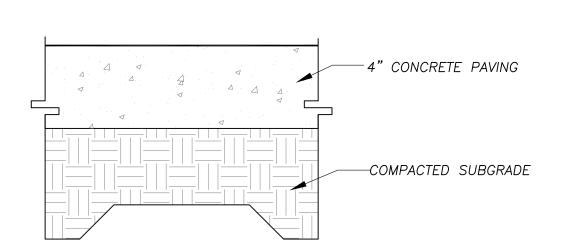


- 1. ALL CONCRETE 3000 PSI. 2. ALL SIDEWALKS SHALL BE CONSTRUCTED WITH TOOLED 1/4" EDGE
- 3. BROOM FINISH
- 4. SIDEWALKS ARE TO HAVE A MAXIMUM CROSS SLOPE OF 2.0%.



NTS



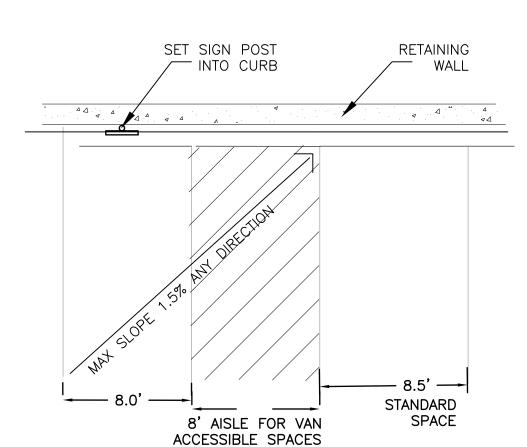


PLAN VIEW


SURFACE HANDICAP PARKING C-7.0

-CONTRACTION JOINTS SHALL BE SPACED AT 10 FOOT INTERVALS. EXCEPT THAT A 15 FOOT SPACING MAY BE USED WHEN A MACHINE IS USED OR WHEN SATISFACTORY SUPPORT FOR THE FACE FORM CAN BE OBTAINED WITHOUT THE USE OF TEMPLATES AT 10 FOOT INTERVALS. JOINT SPACING MAY BE ALTERED BY THE ENGINEER TO PREVENT UNCONTROLLED CRACKING. -CONTRACTION JOINTS MAY BE INSTALLED BY THE USE OF TEMPLATES OR FORMED BY OTHER APPROVED METHODS. WHERE SUCH JOINTS ARE NOT FORMED BY TEMPLATES, A MINIMUM DEPTH OF 1 1/2" SHALL -ALL CONTRACTION JOINTS SHALL BE FILLED WITH JOINT FILLER.


-JOINTS SHALL MATCH LOCATIONS WITH JOINT IN ABUTTING SIDEWALK.
-EXPANSION JOINTS SHALL BE SPACED AT 90 FOOT INTERVALS AND ADJACENT TO ALL RIGID OBJECTS.

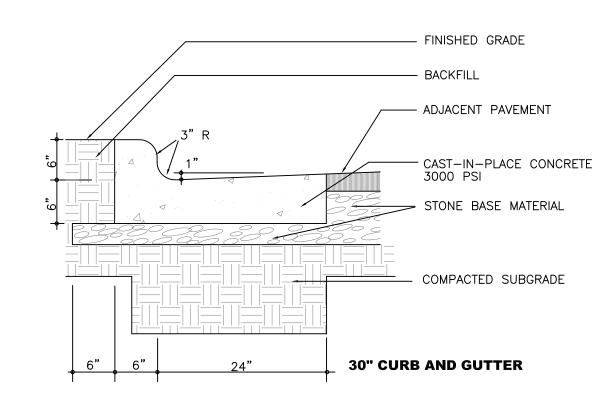




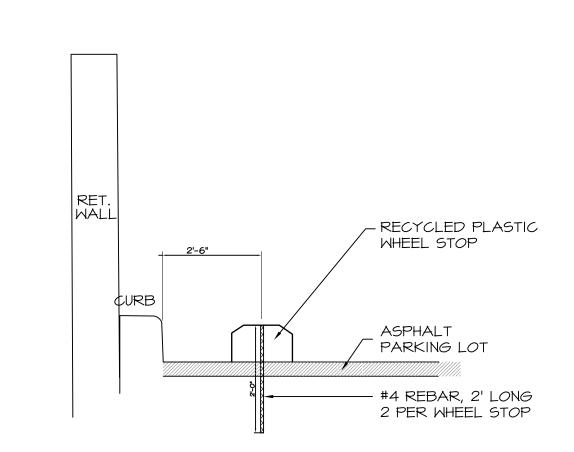




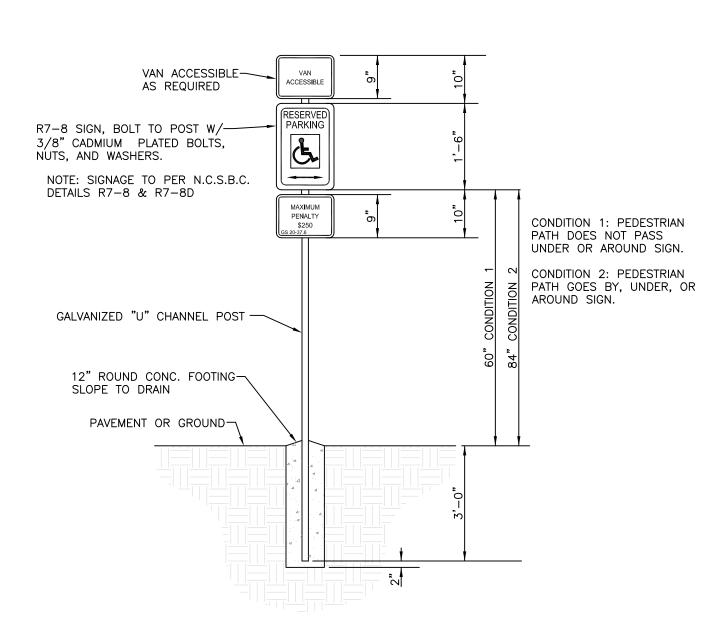

GENERAL NOTES: 1. REGARDLESS OF AGE, ALL ACCESSIBLE SPACES SHALL BE IDENTIFIED BY ABOVE—GROUND SIGNS ONLY. NEW SPACES SHALL NOT USE GROUND-PAINTED SYMBOLS.
 ACCESSIBLE SPACES ARE REQUIRED TO BE STRIPED OFF ONLY; BLUE COLORING IS NOT NECESSARY NOR REQUIRED. 4. STRIPING IS WHITE ON DARK PAVEMENT; BLACK ON LIGHT PAVEMENT. (N.C.D.O.T.)

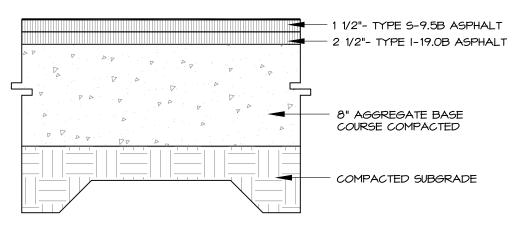

FINAL PAVEMENT SECTION IS PROVIDED BY GEO-TECHNICAL ENGINEER BASED SITE SPECIFIC GEO-TECHNICAL REPORT

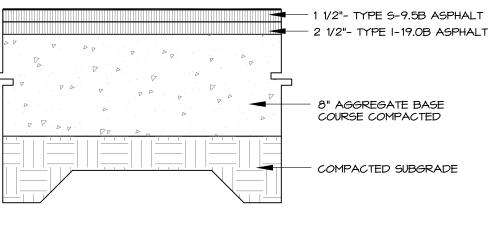



HEAVY DUTY CONCRETE PAVING

C-7.0

NOTES:

MIXES.

1. ALL CONCRETE TO 4000 PSI,

PROPERLY AIR ENTRAINED FOR

SUBGRADE TO BE COMPACTED TO

98% OF THE ASTM D-698 STD.


PROOFROLLED AND APPROVED

BY GEOTECHNICAL PERSONNEL.


EXTERIOR GRADE CONCRETE

2. CABC BASE AND SOIL

PROCTOR MDD AND

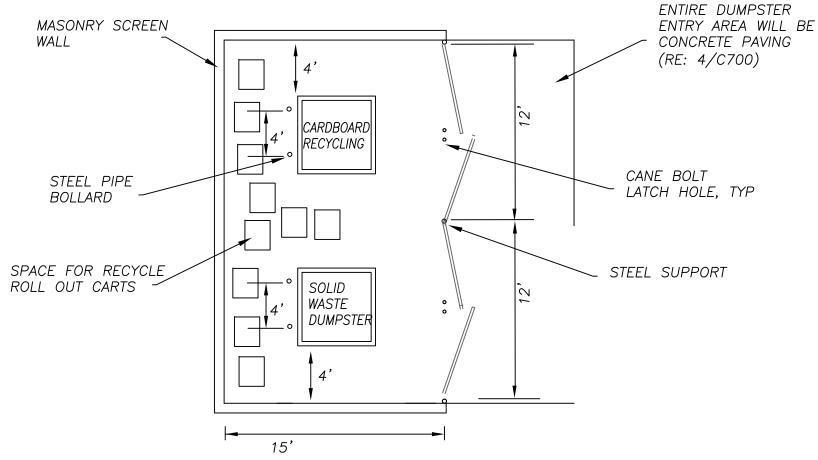



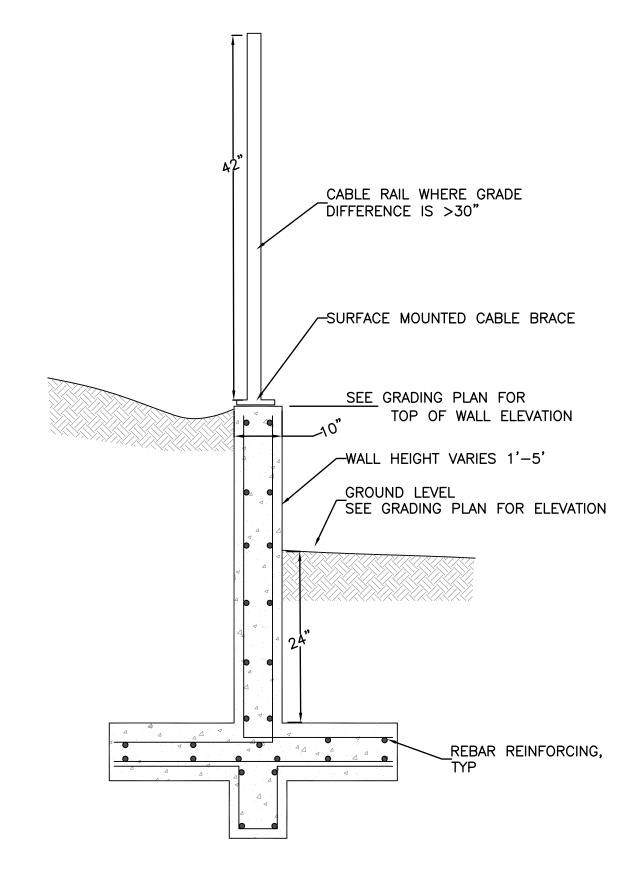

r#4s @ 12" O.C.

CONCRETE PAVEMENT

AGGREGATE BASE COURSE

- COMPACTED SUBGRADE

COMPACTED







111 West Main Street **Durham, N.C. 27701** p 919.682.0368 f 919.688.5646 www.cjtpa.com

NC BOARD OF EXAMINERS FOR ENGINEERS AND SURVEYORS LIC # C-1209 NC BOARD OF LANDSCAPE ARCHITECTS LIC # C-104

11SIXTY5 Weaver Dairy

Project:

Road

1165 Weaver Dairy Rd. Chapel Hill, NC 27514

9880350595



NOT ISSUED FOR CONSTRUCTION

Job Number: 1529


Drawn WLR, MTC, VJC
Checked WLR, VJC
Date 11-30-17
Revisions


SPECIAL USE PERMIT

Sheet Title:

SITE **DETAILS** 

Sheet Number C-7.0

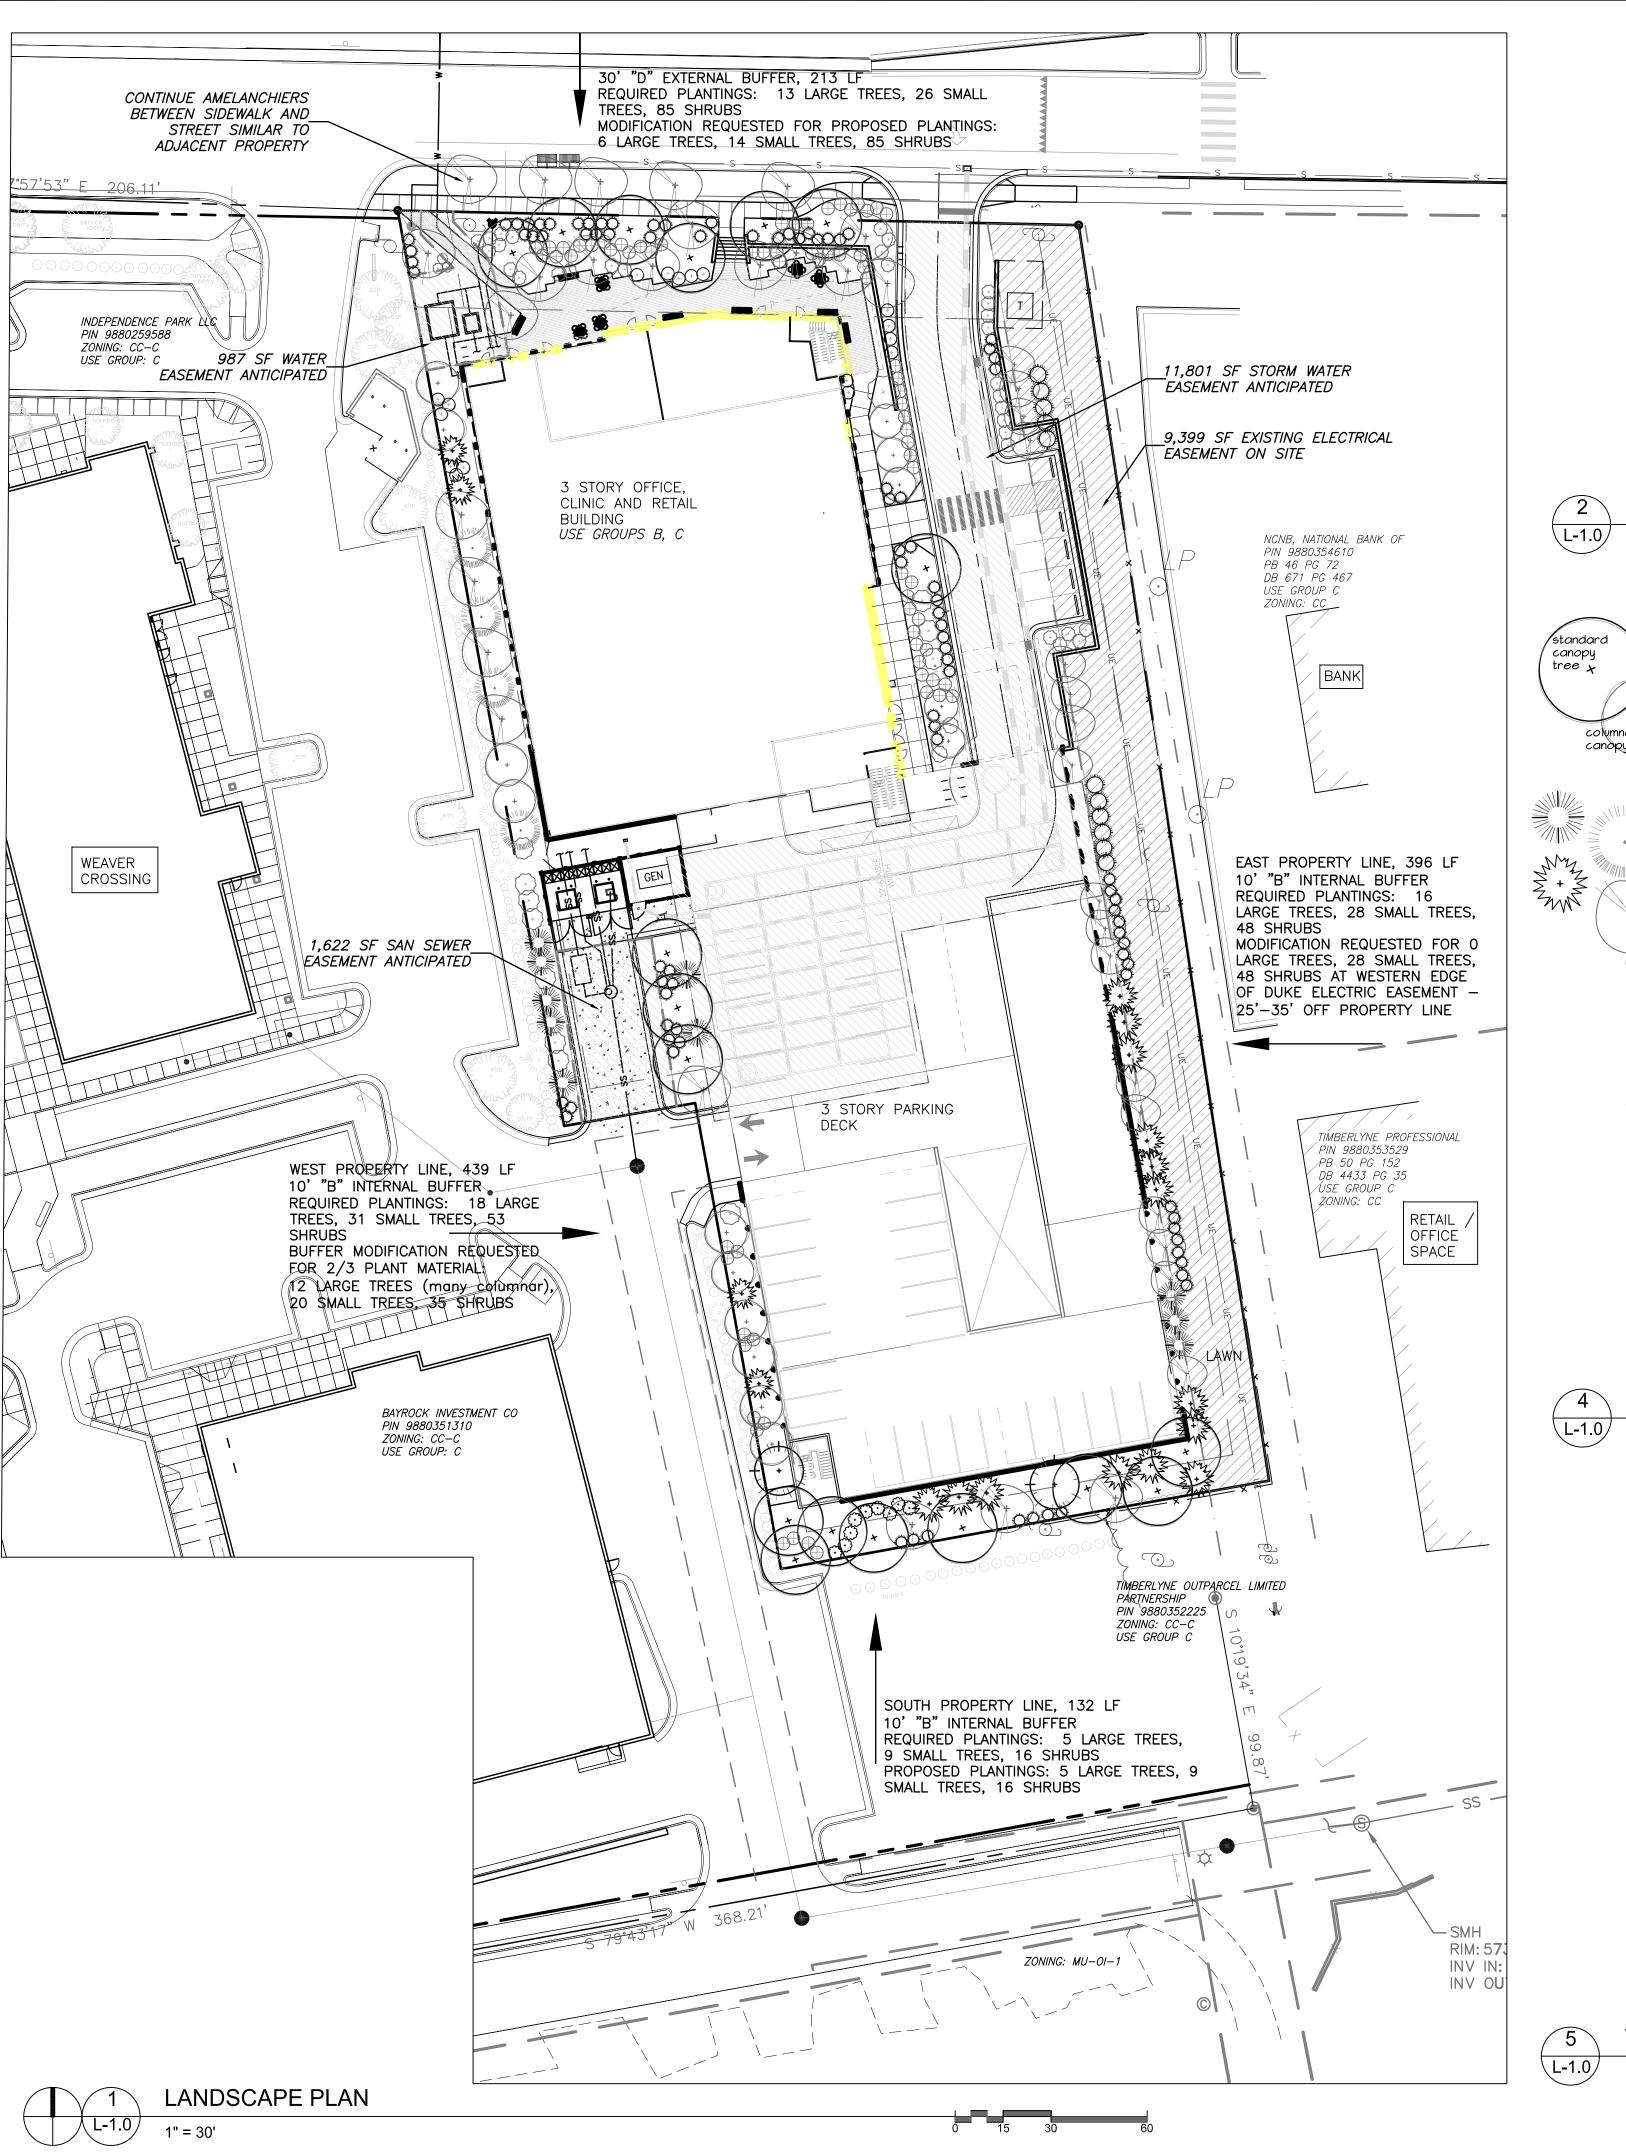

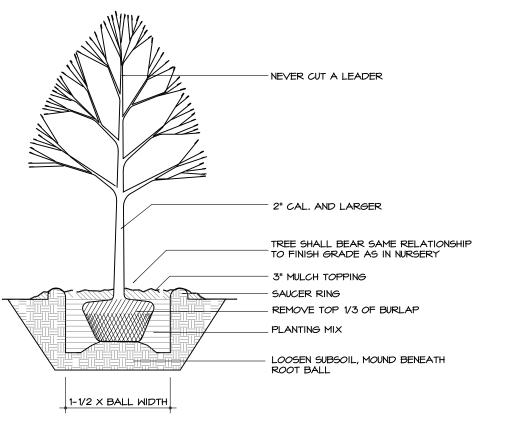

#### TREE PLANTING DETAIL

#### LANDSCAPE BUFFER PLAZA / PLANTINGS WILL INCLUDE A SELECTION FROM:

candpy tree

ACER RUBRUM 'AUTUMN BLAZE' - Autumn Blaze Red Maple ACER SACCHARUM 'Legacy' - Legacy Sugar Maple CARPINUS BETULUS 'Fastigiata' - Upright Hormbeam LIQUIDAMBER STYRACIFLUA 'Rotundiloba' - Fruitless Sweet Gum QUERCUS NUTALLII - Nuttal Oak ULMUS AMERICANA 'Princeton' - Princeton Elm

#### INSTALLATION SIZE WILL BE MIN 2 1/2" CALIPER

AMELANCHEIR SPP AUTUMN BRILLIANCE - Autumn Brilliance Serviceberry CORNUS FLORIDA 'White Cloud' - White Flowering Dogwood CORNUS KOUSA - Kousa Dogwood ILEX CORNUTA 'Steeds' - Steeds Holly LAGERSTROEMIA FAUREI - Crape Myrtle

PRUNUS LAUROCERASUS - Cherry Laurel MYRICA CERIFERA - Southern Wax Myrtle THUJA STANDISH x PLICATA 'Green Ğiant' - Green Giant Arborvitae VITEX AGNUS-CASTUS - Chaste Tree


#### INSTALLATION SIZE WILL BE MIN 6' HEIGHT

SHRUBS/GROUNDCOVER:

ABELIA X GRANDIFLORA - Glossy Abelia BUXUS - Boxwood varieties CAMELLIA JAPONICA - Japanese Camellia CALLICARPA AMERICANA'- American Beautyberry CEPHALOTAXUS HARRINGTONIA 'Fastigiata' - Upright Plum Yew EUONYMUS JAPONICUS 'Moness' - Silver Princes's Euonymus GARDENIA JASMINOIDES - Gardenia varieties HELLEBORUS ORIENTALIS - Lenten Rose

ILEX GLABRA - Inkberry ILEX VERTICILLATA - Deciduous Holly ILLICIUM PARVIFLORUM - Anise LIRIOPE MUSCARI - Liriope MUHLENBERGIA CAPILLA'RIS - Pink Muhly Grass MYRICA CERIFERA - Southern Waxmyrtle PANICUM - Switchgrass ROSA - Drift Roses

INSTALLATION SIZE WILL VARY: 24"-30" ht for larger shrubs 12"-15" ht for low growing / spreading shrubs

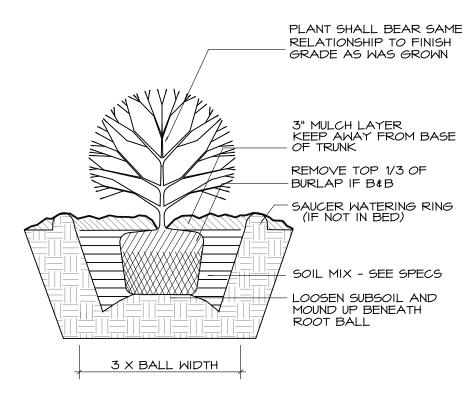

#### SHRUB PLANTING DETAIL

\L-1.0/

LANDSCAPE BUFFER PLANTINGS IN DUKE ENERGY EASEMENT WILL INCLUDE A SELECTION FROM:

UNDERSTORY TREES: AMELANCHEIR CANADENSIS - Serviceberry

CHIONANTHUS VIRGINICUS - Fringe Tree HAMAMELIS VERNALIS - Vernal Witch Hazal ILEX CORNUTA 'Steeds' - Steeds Holly MAGNOLIA STELLATA - Star Magnolia MAGNOLIA GRANDIFLOR 'Little Gem' - Little Gem Magnolia VITEX AGNUS-CASTUS - Chaste Tree

INSTALLATION SIZE WILL BE MIN 6' HEIGHT

MYRICA CERIFERA - Southern Waxmyrtle

SHRUBS/GROUNDCOVER: ABELIA X GRANDIFLORA - Glossy Abelia BUXUS - Boxwood varieties CAMELLIA JAPONICA - Japanese Camellia CALLICARPA AMERICANA'- American Beautyberry CEPHALOTAXUS HARRINGTONIA 'Fastigiata' - Upright Plum Yew ILEX GLABRA - Inkberry ILLICIUM PARVIFLORUM - Anise

INSTALLATION SIZE: 24"-36" ht

PARKING LOT PLANTINGS WILL INCLUDE A SELECTION FROM:

ACER RUBRUM 'October Glory' - October Glory Red Maple

CARPINUS BETULUS 'Fastiqiata' - Columnar Hornbeam ULMUS PARVIFOLIA - Chinese Elm ZELKOVA SERRATA 'Village Green' - Village Green Zelkova INSTALLATION SIZE WILL BE MIN. 2 1/2" CALIBER

SHRUBS/GROUNDCOVER:

ILEX - Small hollies JUNIPERUS SARGENTII - Low growing Juniper LOROPETALUM CHINENSIS - Iow growing varieties Loropetalum MUHLENBERGIA CAPILLARIS - Pink Muhly Grass PANICUM VIRGATUM 'Shenandoah' - Shenandoah Switchgrass

INSTALLATION SIZE WILL VARY 18"-30" ht for large shrubs, 12"-15" ht for small/spreading shrubs

PLANT LIST

#### TREE COVERAGE CALCULATIONS

NET LAND AREA: = 78,557 SF

LESS OVERHEAD UTILITY EASEMENT OF 9,399 SF LESS ANTICIPATED STORM EASEMENT OF 11,801 SF LESS ANTICIPATED SANITARY SEWER EASEMENT OF 1,622 SF LESS ANTICIPATED WATER EASEMENT OF 987 F

NET SITE SIZE = 54,748 SF

REQUIRED TREE COVERAGE 30% OF SITE = 16,424 SF

PROVIDED TREE COVERAGE: NO EXISTING CANOPY COVERAGE RETAINED 33 NEW CANOPY TREES FOR 16,500 SF COVERAGE CREDIT

TREE COVERAGE SUMMARY



111 West Main Street **Durham, N.C. 27701** p 919.682.0368 f 919.688.5646 www.cjtpa.com

NC BOARD OF EXAMINERS FOR ENGINEERS AND SURVEYORS LIC # C-1209 NC BOARD OF LANDSCAPE ARCHITECTS LIC # C-104

Project

#### 11SIXTY5 **Weaver Dairy** Road

1165 Weaver Dairy Rd. Chapel Hill, NC 27514



NOT ISSUED FOR CONSTRUCTION

Job Number: 1529 WLR, MTC, VJC

Drawn WLR, MIO, vo.
Checked WLR, VJC
11-30-17 Date Revisions


SPECIAL USE PERMIT

Sheet Title:

LANDSCAPE AND TREE CANOPY **PLAN** 

Sheet Number

L-1.0

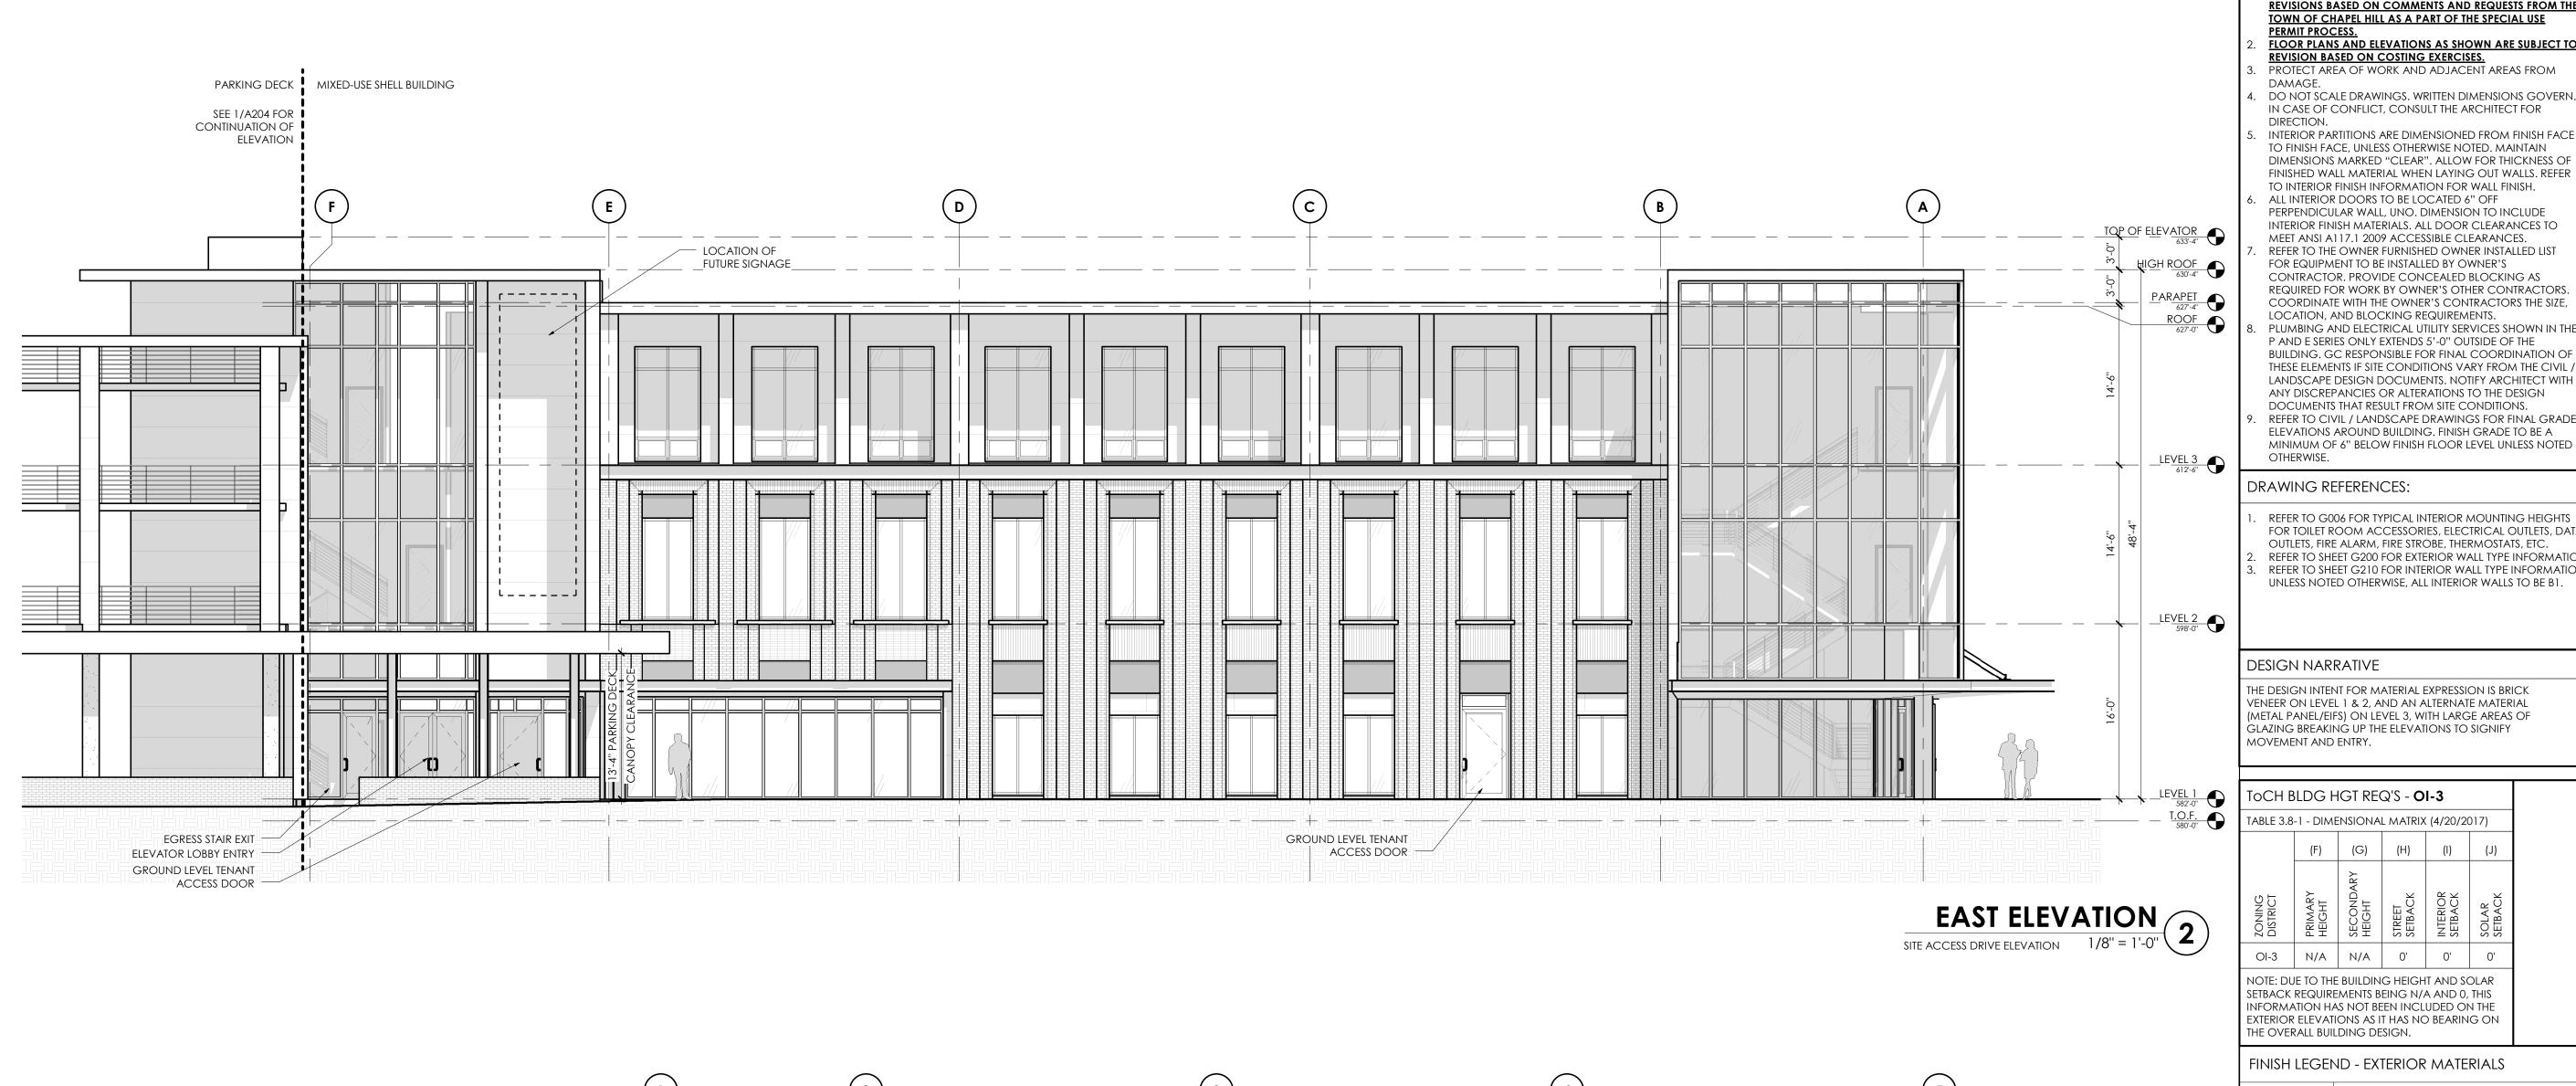


LOCATION OF

MONUMENTAL STAIR EXIT

**FUTURE SIGNAGE** 

LEVEL 3

LEVEL 2\_598'-0"

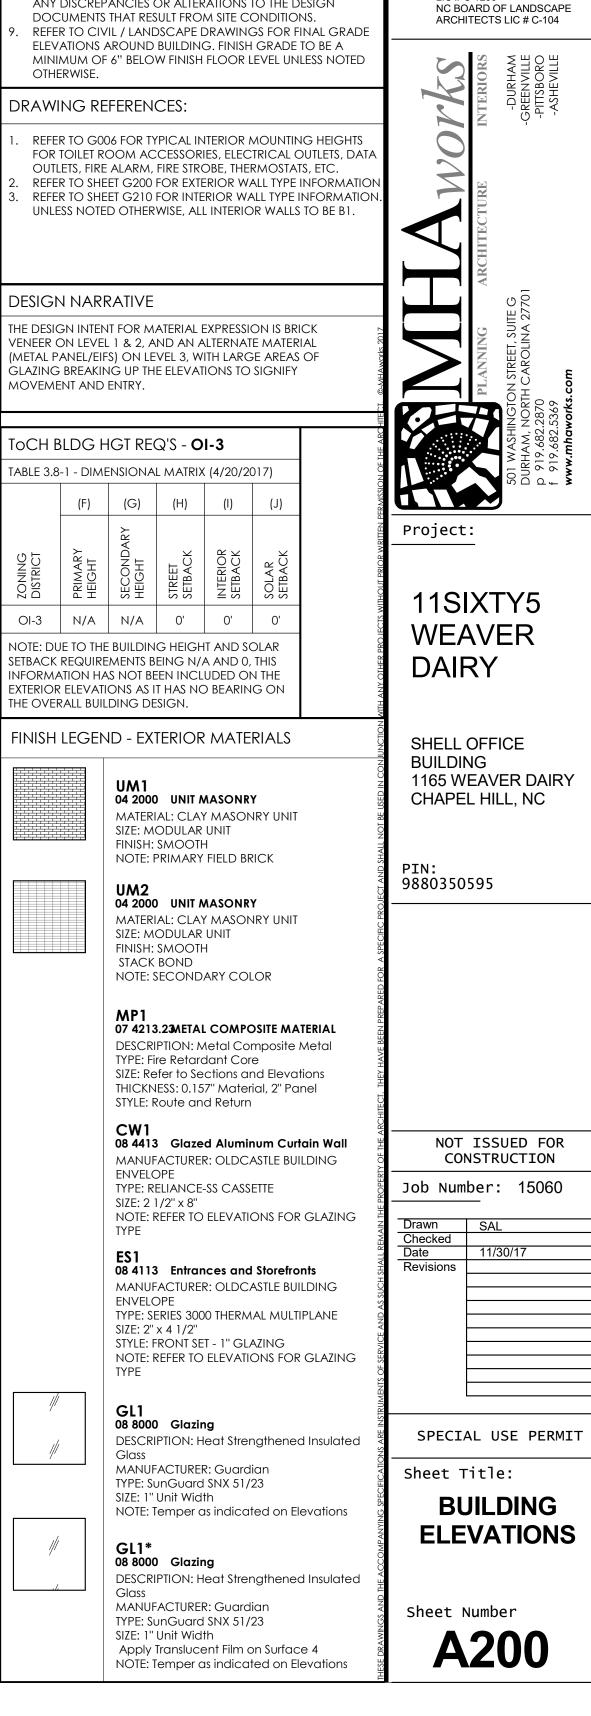



WEAVER DAIRY ELEVATION

111 West Main Street

**Durham, N.C. 27701** 

NC BOARD OF EXAMINERS FOR

ENGINEERS AND SURVEYORS

p 919.682.0368

f 919.688.5646

www.cjtpa.com

LIC # C-1209

FLOOR PLANS AND ELEVATIONS AS SHOWN ARE SUBJECT TO REVISION BASED ON COSTING EXERCISES. PROTECT AREA OF WORK AND ADJACENT AREAS FROM

DO NOT SCALE DRAWINGS. WRITTEN DIMENSIONS GOVERN IN CASE OF CONFLICT, CONSULT THE ARCHITECT FOR DIRECTION. INTERIOR PARTITIONS ARE DIMENSIONED FROM FINISH FACE


FLOOR PLANS AND ELEVATIONS AS SHOWN ARE SUBJECT TO


**GENERAL NOTES:** 

TO FINISH FACE, UNLESS OTHERWISE NOTED. MAINTAIN DIMENSIONS MARKED "CLEAR". ALLOW FOR THICKNESS OF FINISHED WALL MATERIAL WHEN LAYING OUT WALLS. REFER TO INTERIOR FINISH INFORMATION FOR WALL FINISH. ALL INTERIOR DOORS TO BE LOCATED 6" OFF PERPENDICULAR WALL, UNO. DIMENSION TO INCLUDE INTERIOR FINISH MATERIALS. ALL DOOR CLEARANCES TO MEET ANSI A117.1 2009 ACCESSIBLE CLEARANCES. REFER TO THE OWNER FURNISHED OWNER INSTALLED LIST FOR EQUIPMENT TO BE INSTALLED BY OWNER'S

CONTRACTOR. PROVIDE CONCEALED BLOCKING AS REQUIRED FOR WORK BY OWNER'S OTHER CONTRACTORS. COORDINATE WITH THE OWNER'S CONTRACTORS THE SIZE, LOCATION, AND BLOCKING REQUIREMENTS. PLUMBING AND ELECTRICAL UTILITY SERVICES SHOWN IN THE P AND E SERIES ONLY EXTENDS 5'-0" OUTSIDE OF THE BUILDING. GC RESPONSIBLE FOR FINAL COORDINATION OF THESE ELEMENTS IF SITE CONDITIONS VARY FROM THE CIVIL / LANDSCAPE DESIGN DOCUMENTS. NOTIFY ARCHITECT WITH ANY DISCREPANCIES OR ALTERATIONS TO THE DESIGN

TABLE 3.8-1 - DIMENSIONAL MATRIX (4/20/2017)

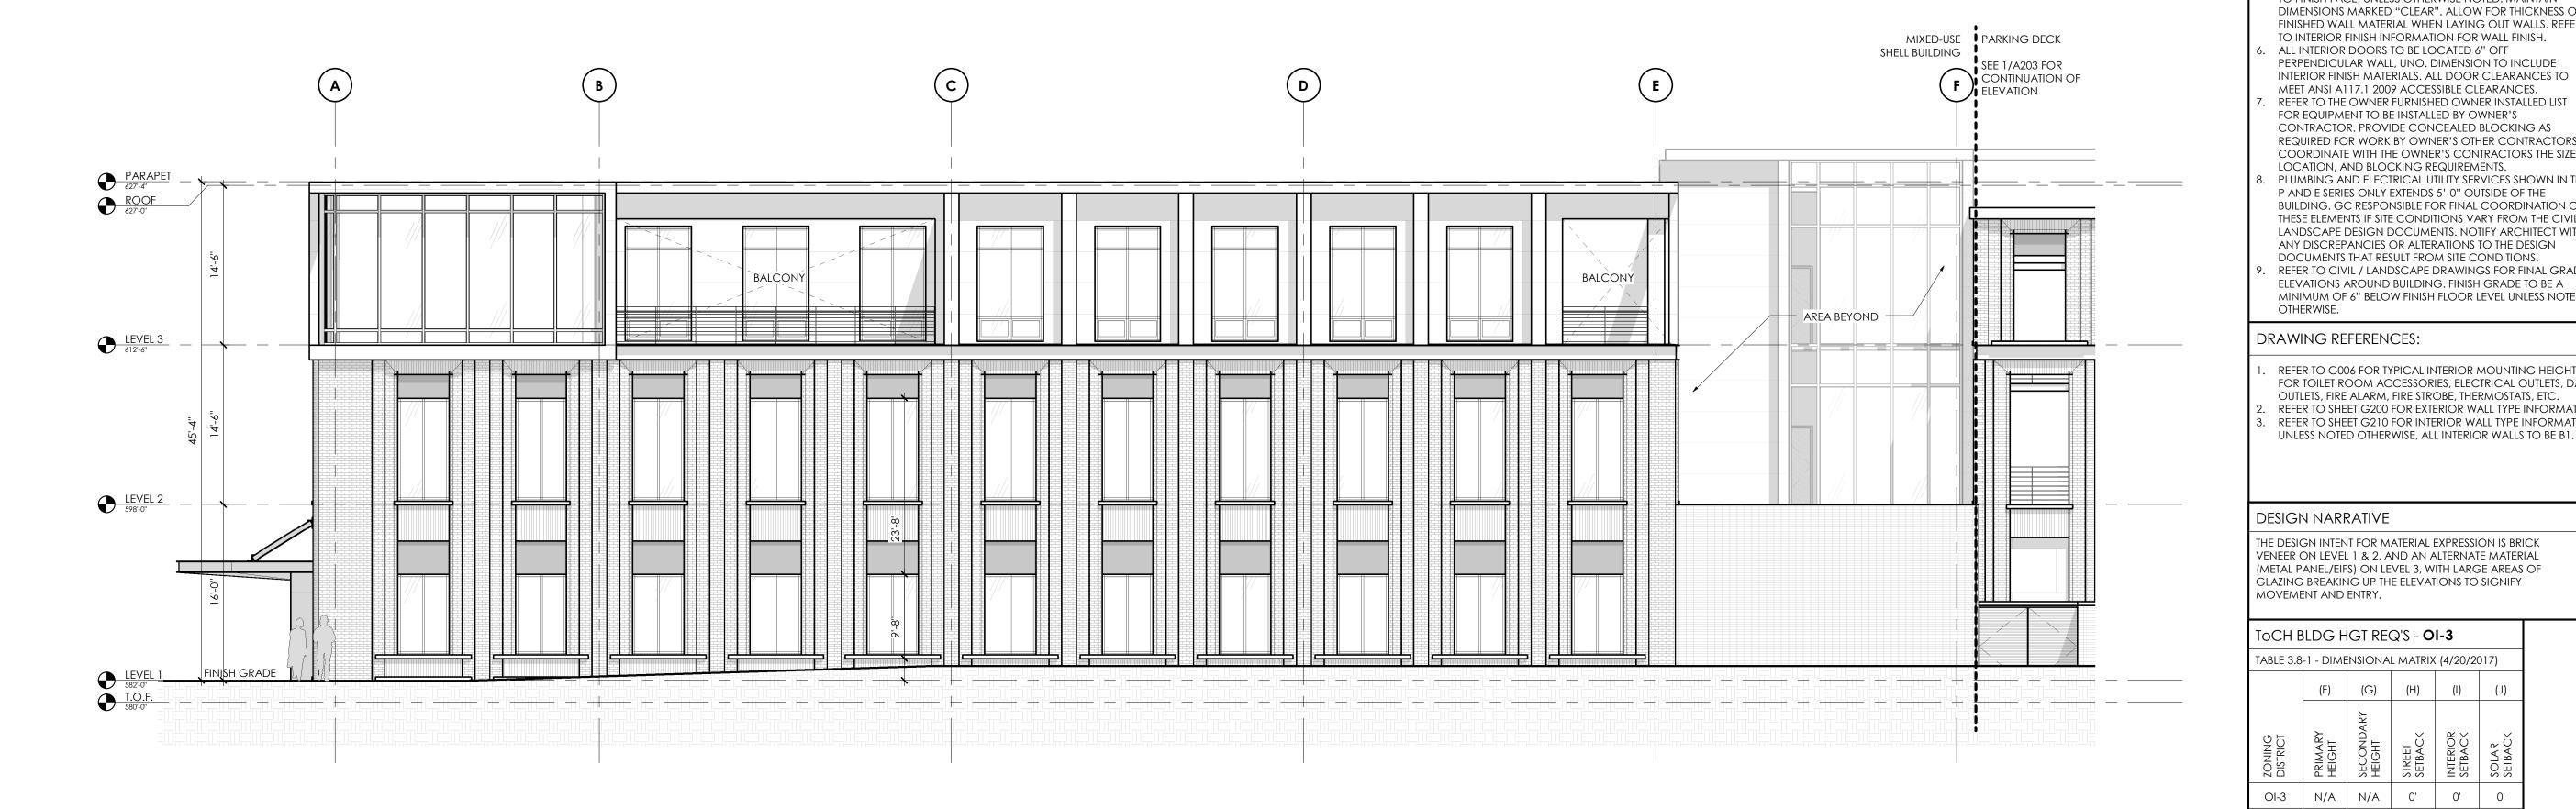

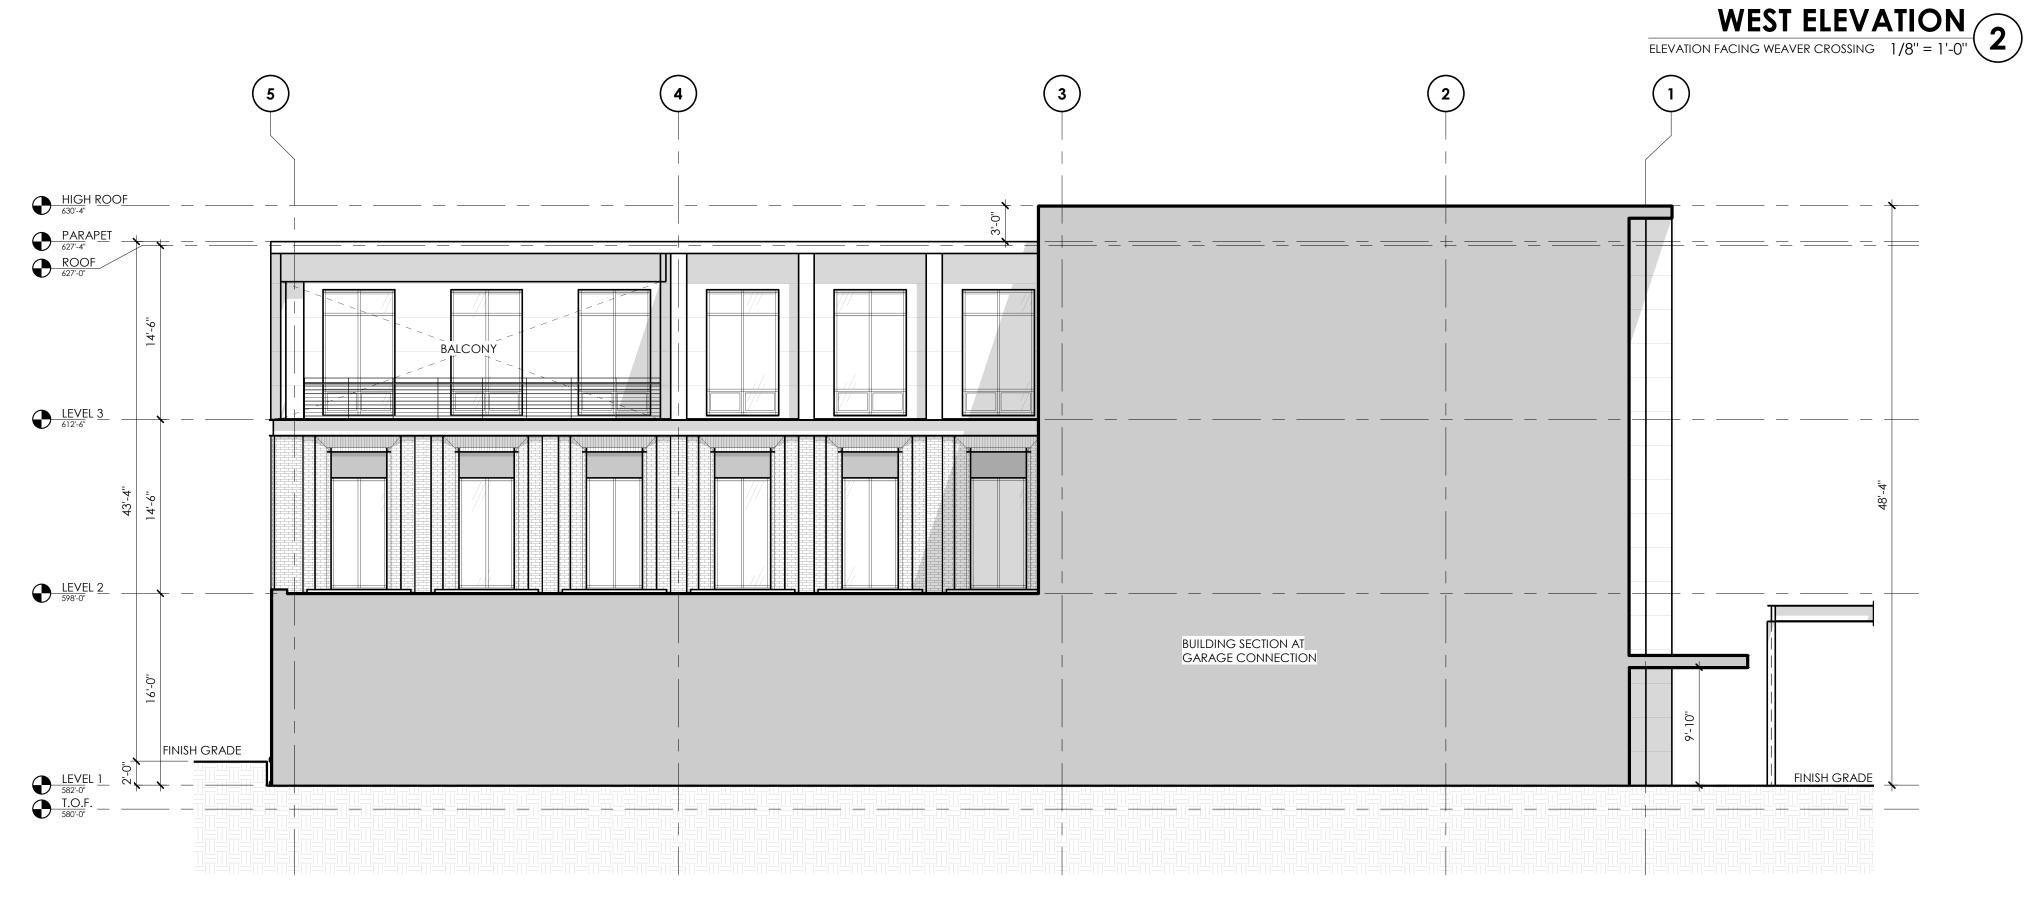

FLOOR PLANS AND ELEVATIONS AS SHOWN ARE SUBJECT TO REVISIONS BASED ON COMMENTS AND REQUESTS FROM THE TOWN OF CHAPEL HILL AS A PART OF THE SPECIAL USE FLOOR PLANS AND ELEVATIONS AS SHOWN ARE SUBJECT TO REVISION BASED ON COSTING EXERCISES.
PROTECT AREA OF WORK AND ADJACENT AREAS FROM DO NOT SCALE DRAWINGS. WRITTEN DIMENSIONS GOVERN. IN CASE OF CONFLICT, CONSULT THE ARCHITECT FOR INTERIOR PARTITIONS ARE DIMENSIONED FROM FINISH FACE TO FINISH FACE, UNLESS OTHERWISE NOTED. MAINTAIN DIMENSIONS MARKED "CLEAR". ALLOW FOR THICKNESS OF FINISHED WALL MATERIAL WHEN LAYING OUT WALLS. REFER 111 West Main Street Durham, N.C. 27701 REQUIRED FOR WORK BY OWNER'S OTHER CONTRACTORS. p 919.682.0368 COORDINATE WITH THE OWNER'S CONTRACTORS THE SIZE, f 919.688.5646 www.cjtpa.com PLUMBING AND ELECTRICAL UTILITY SERVICES SHOWN IN THE BUILDING. GC RESPONSIBLE FOR FINAL COORDINATION OF THESE ELEMENTS IF SITE CONDITIONS VARY FROM THE CIVIL / NC BOARD OF EXAMINERS FOR ENGINEERS AND SURVEYORS LANDSCAPE DESIGN DOCUMENTS. NOTIFY ARCHITECT WITH LIC # C-1209 NC BOARD OF LANDSCAPE ARCHITECTS LIC # C-104 REFER TO CIVIL / LANDSCAPE DRAWINGS FOR FINAL GRADE MINIMUM OF 6" BELOW FINISH FLOOR LEVEL UNLESS NOTED REFER TO G006 FOR TYPICAL INTERIOR MOUNTING HEIGHTS FOR TOILET ROOM ACCESSORIES, ELECTRICAL OUTLETS, DATA REFER TO SHEET G200 FOR EXTERIOR WALL TYPE INFORMATION REFER TO SHEET G210 FOR INTERIOR WALL TYPE INFORMATION. Project: **WEAVER** DAIRY SHELL OFFICE BUILDING 1165 WEAVER DAIRY CHAPEL HILL, NC 9880350595 NOT ISSUED FOR CONSTRUCTION Job Number: 15060 Drawn SAL
Checked
Date 11/30/17
Revisions NOTE: REFER TO ELEVATIONS FOR GLAZING

EXTERIOR ELEVATIONS AS IT HAS NO BEARING ON THE OVERALL BUILDING DESIGN.

NOTE: DUE TO THE BUILDING HEIGHT AND SOLAR SETBACK REQUIREMENTS BEING N/A AND 0, THIS INFORMATION HAS NOT BEEN INCLUDED ON THE

FINISH LEGEND - EXTERIOR MATERIALS

**GENERAL NOTES:** 

DIRECTION.

UM1 04 2000 UNIT MASONRY MATERIAL: CLAY MASONRY UNIT SIZE: MODULAR UNIT FINISH: SMOOTH NOTE: PRIMARY FIELD BRICK

> UM2 04 2000 UNIT MASONRY MATERIAL: CLAY MASONRY UNIT SIZE: MODULAR UNIT FINISH: SMOOTH STACK BOND

NOTE: SECONDARY COLOR 07 4213.23METAL COMPOSITE MATERIAL

DESCRIPTION: Metal Composite Metal TYPE: Fire Retardant Core SIZE: Refer to Sections and Elevations THICKNESS: 0.157" Material, 2" Panel STYLE: Route and Return

CW1 08 4413 Glazed Aluminum Curtain Wall MANUFACTURER: OLDCASTLE BUILDING ENVELOPE
TYPE: RELIANCE-SS CASSETTE SIZE: 2 1/2" x 8" NOTE: REFER TO ELEVATIONS FOR GLAZING

TYPE ES1 08 4113 Entrances and Storefronts MANUFACTURER: OLDCASTLE BUILDING ENVELOPE TYPE: SERIES 3000 THERMAL MULTIPLANE SIZE: 2" x 4 1/2" STYLE: FRONT SET - 1" GLAZING

GL1 08 8000 Glazing

DESCRIPTION: Heat Strengthened Insulated MANUFACTURER: Guardian TYPE: SunGuard SNX 51/23 SIZE: 1" Unit Width

Apply Translucent Film on Surface 4 NOTE: Temper as indicated on Elevations

NOTE: Temper as indicated on Elevations

**ELEVATIONS GL1\*** 08 8000 Glazing DESCRIPTION: Heat Strengthened Insulated MANUFACTURER: Guardian Sheet Number TYPE: SunGuard SNX 51/23 SIZE: 1" Unit Width


SPECIAL USE PERMIT


**BUILDING** 


Sheet Title:

SOUTH ELEVATION

ELEVATION FACING PARKING DECK 1/8" = 1'-0"

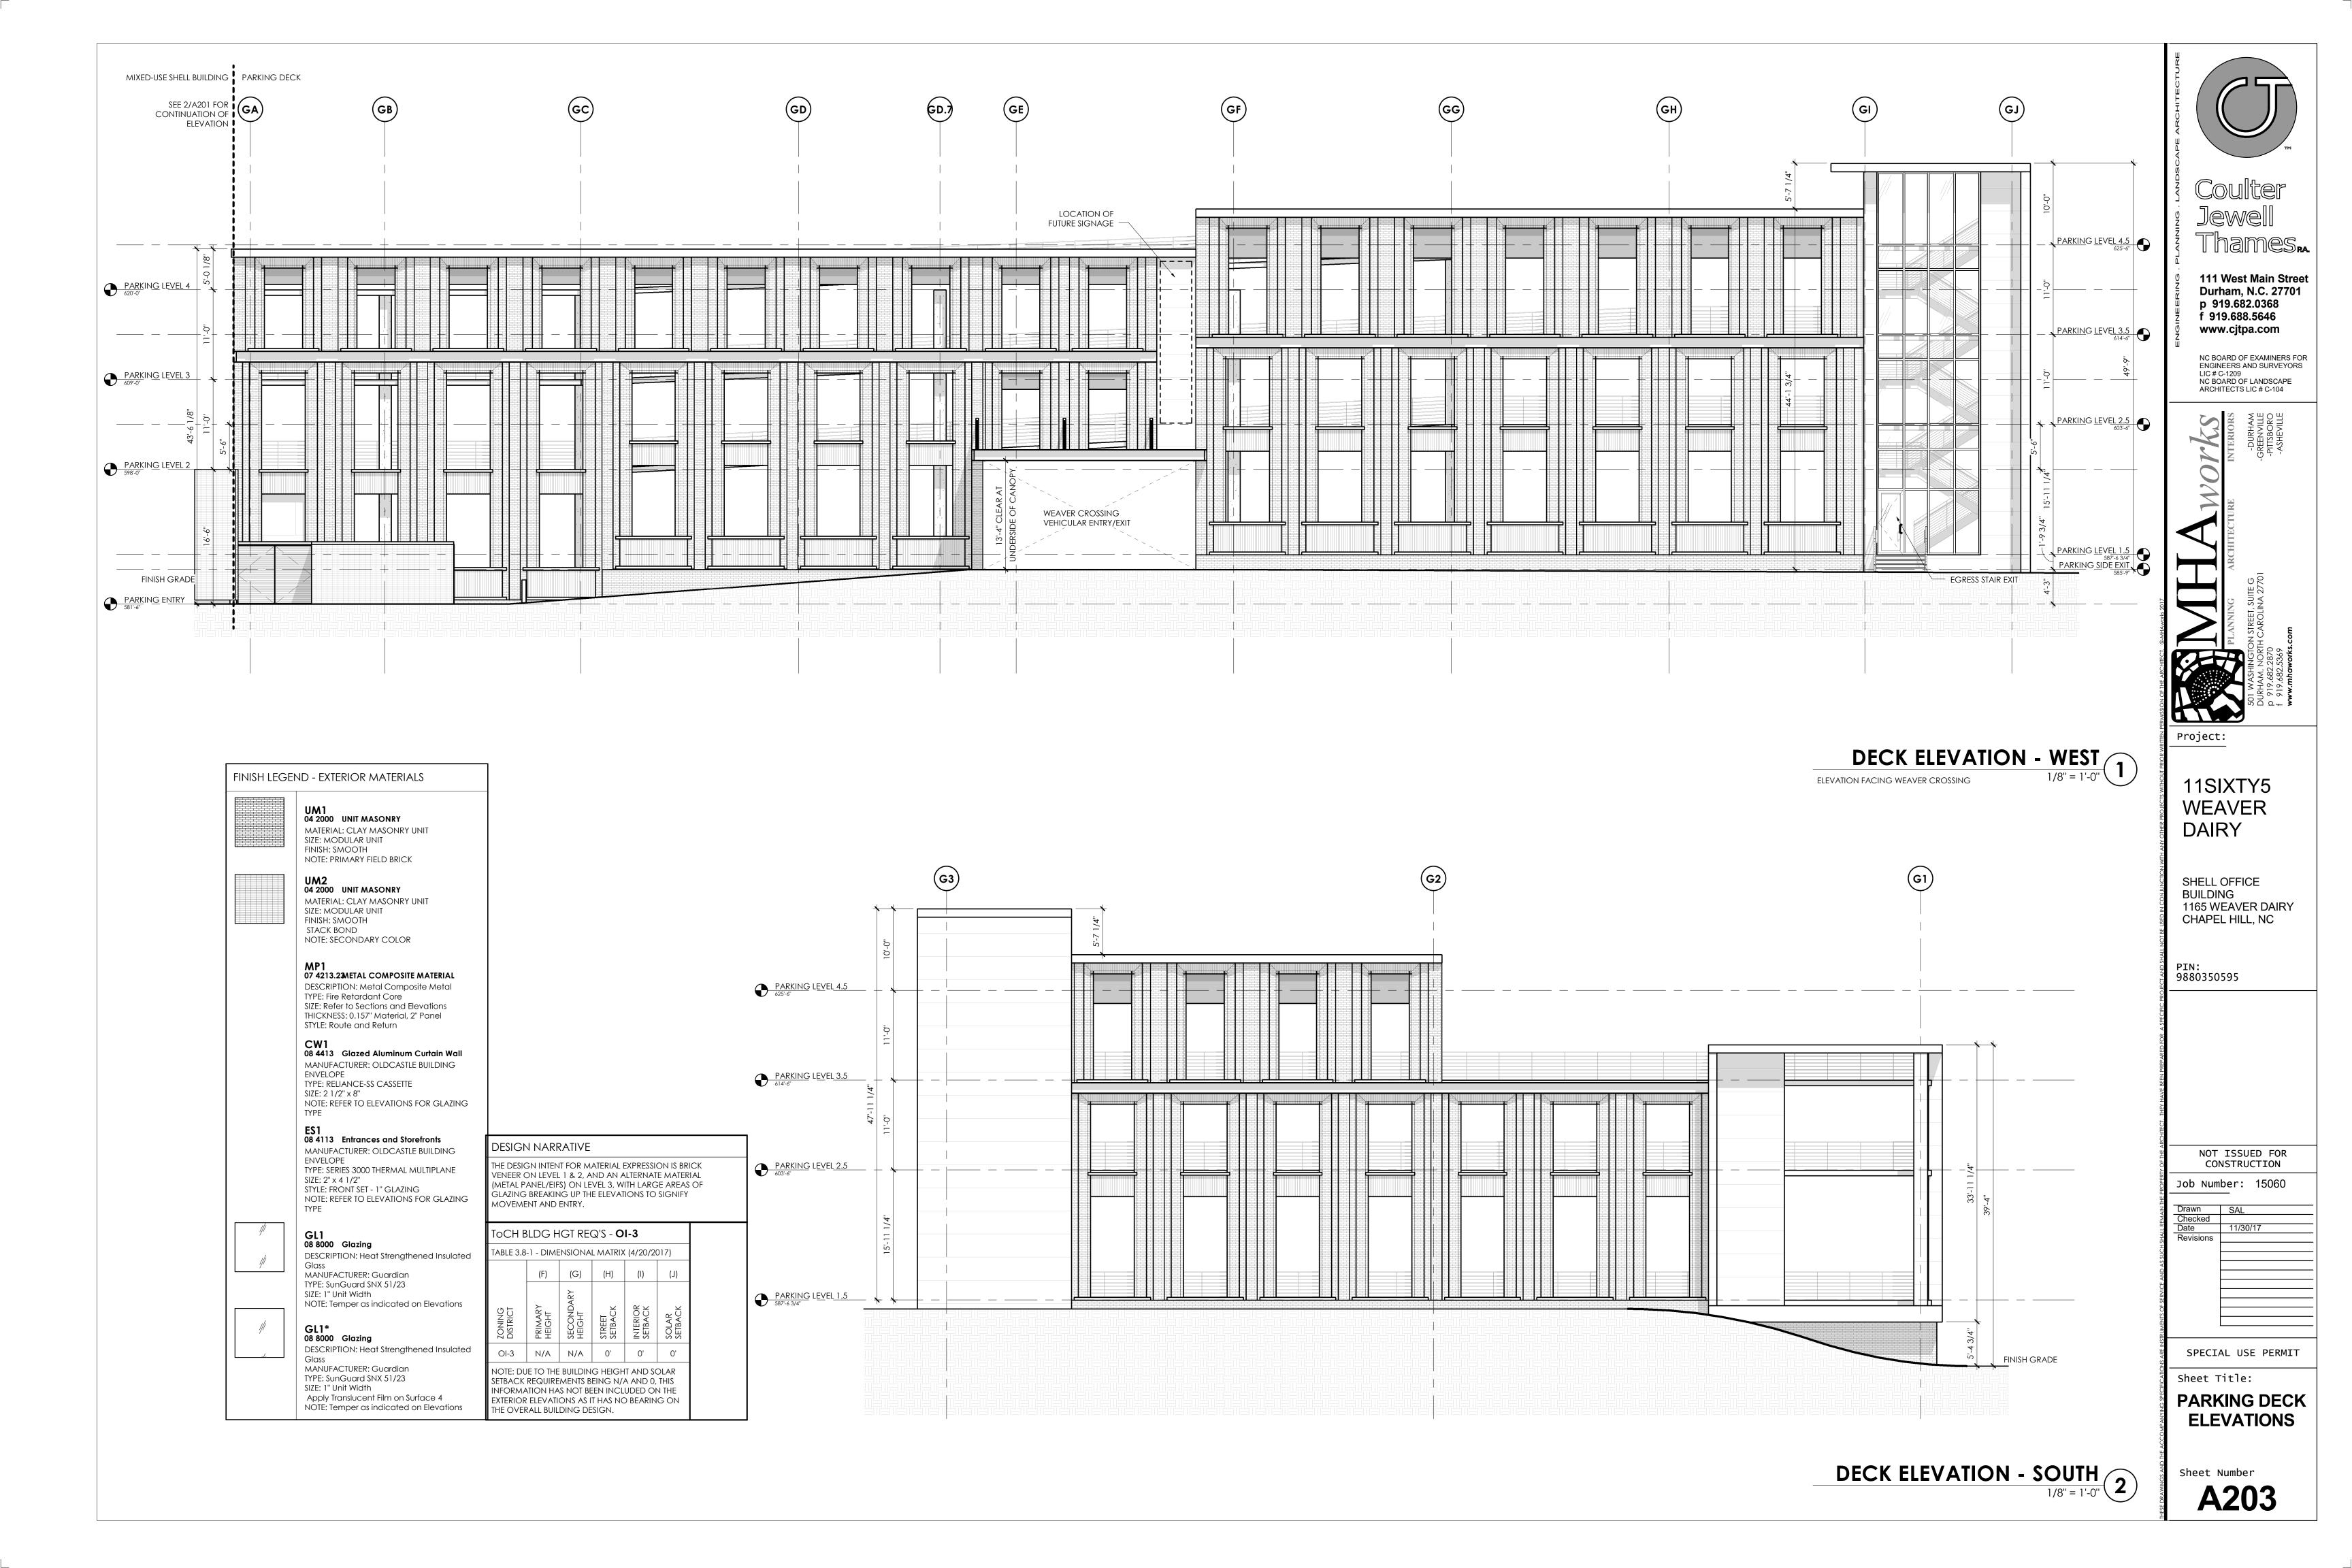

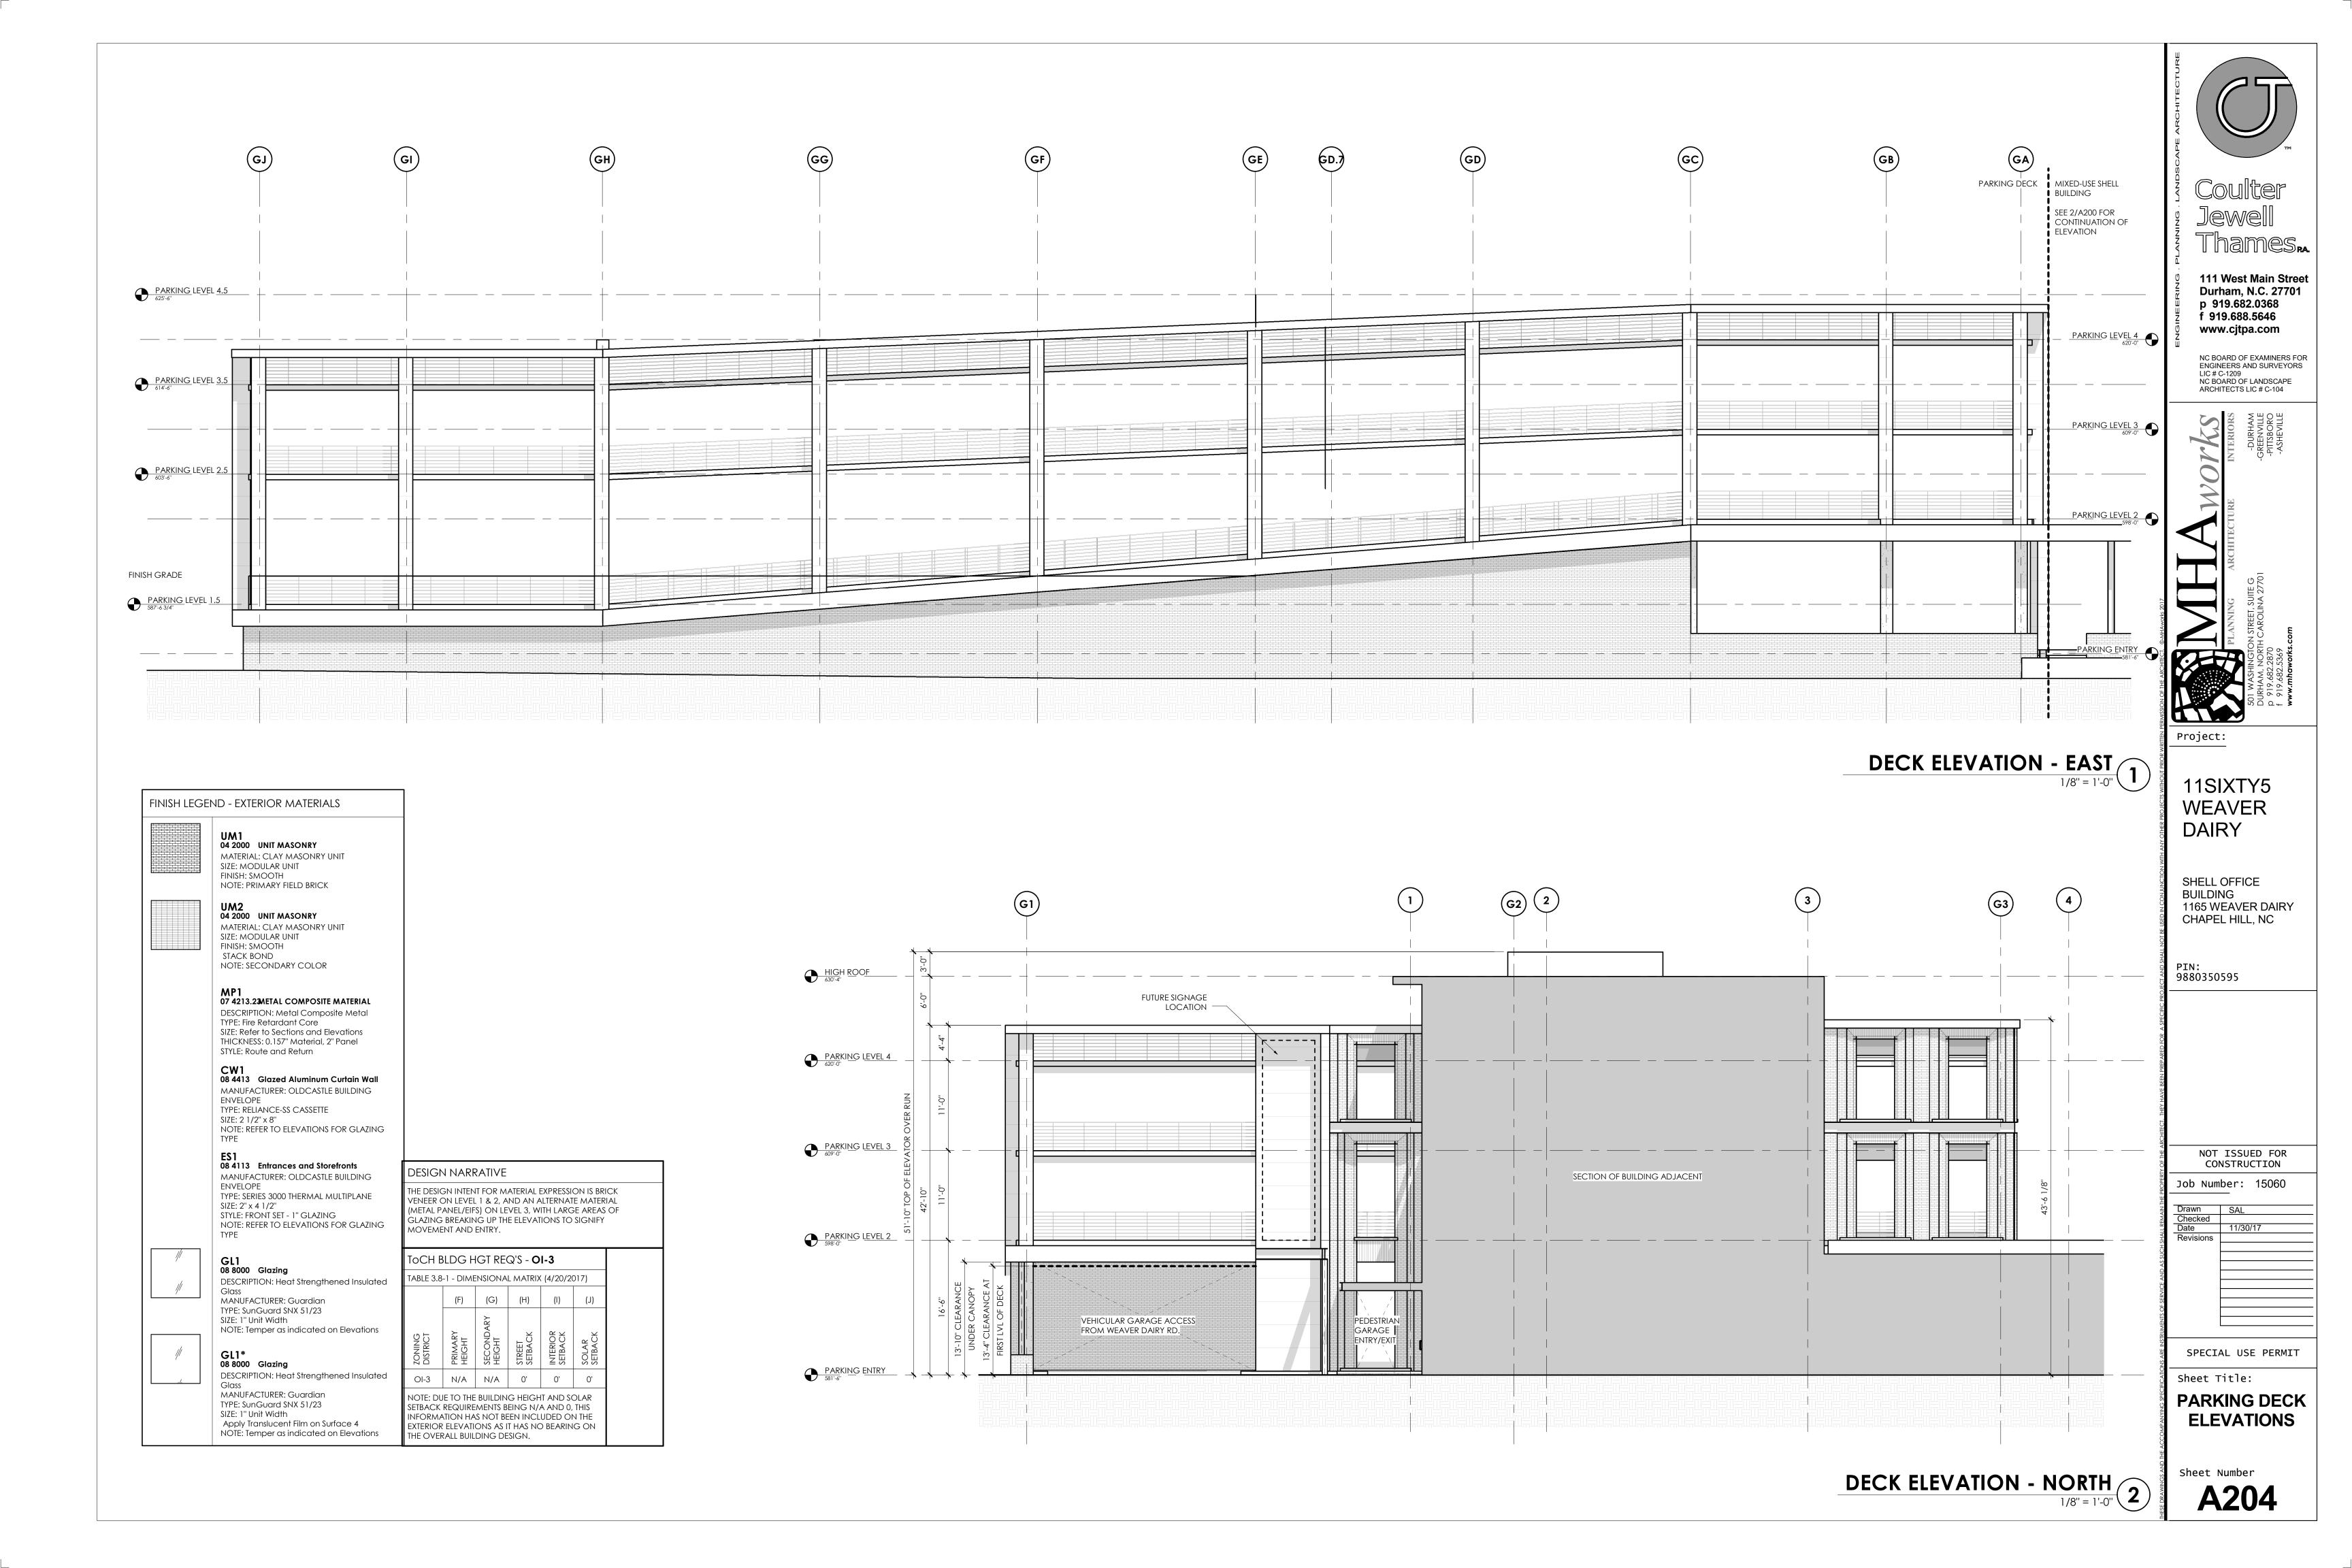

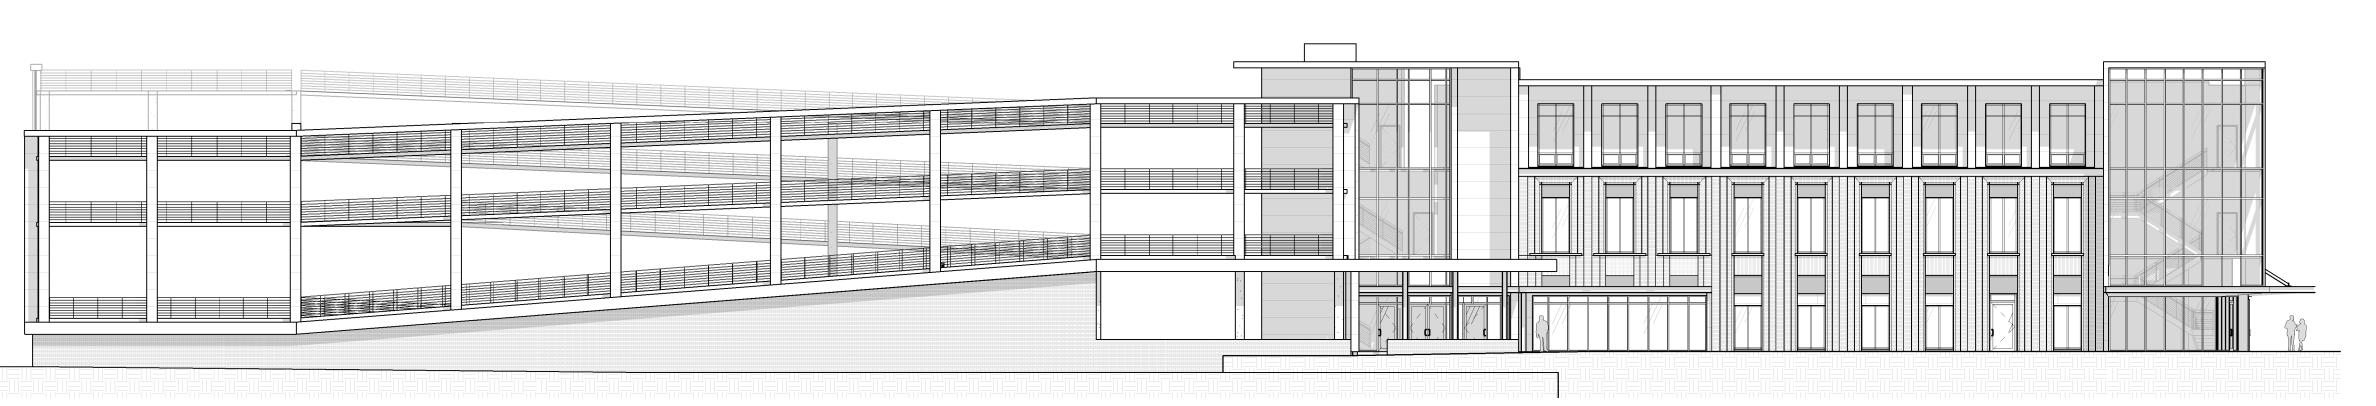

OVERALL EAST ELEVATION
1/16" = 1'-0"
2

PARKING DECK SIDE EXIT TO WEAVER CROSSING

OVERALL WEST ELEVATION 1

**GENERAL NOTES:** 

- FLOOR PLANS AND ELEVATIONS AS SHOWN ARE SUBJECT TO REVISIONS BASED ON COMMENTS AND REQUESTS FROM THE TOWN OF CHAPEL HILL AS A PART OF THE SPECIAL USE
- PERMIT PROCESS. FLOOR PLANS AND ELEVATIONS AS SHOWN ARE SUBJECT TO REVISION BASED ON COSTING EXERCISES.
- PROTECT AREA OF WORK AND ADJACENT AREAS FROM DO NOT SCALE DRAWINGS. WRITTEN DIMENSIONS GOVERN. IN CASE OF CONFLICT, CONSULT THE ARCHITECT FOR
- DIRECTION. INTERIOR PARTITIONS ARE DIMENSIONED FROM FINISH FACE TO FINISH FACE, UNLESS OTHERWISE NOTED. MAINTAIN DIMENSIONS MARKED "CLEAR". ALLOW FOR THICKNESS OF FINISHED WALL MATERIAL WHEN LAYING OUT WALLS. REFER TO INTERIOR FINISH INFORMATION FOR WALL FINISH.
- ALL INTERIOR DOORS TO BE LOCATED 6" OFF PERPENDICULAR WALL, UNO. DIMENSION TO INCLUDE INTERIOR FINISH MATERIALS. ALL DOOR CLEARANCES TO MEET ANSI A117.1 2009 ACCESSIBLE CLEARANCES.
- REFER TO THE OWNER FURNISHED OWNER INSTALLED LIST FOR EQUIPMENT TO BE INSTALLED BY OWNER'S CONTRACTOR. PROVIDE CONCEALED BLOCKING AS REQUIRED FOR WORK BY OWNER'S OTHER CONTRACTORS. COORDINATE WITH THE OWNER'S CONTRACTORS THE SIZE, LOCATION, AND BLOCKING REQUIREMENTS.
- PLUMBING AND ELECTRICAL UTILITY SERVICES SHOWN IN THE P AND E SERIES ONLY EXTENDS 5'-0" OUTSIDE OF THE BUILDING. GC RESPONSIBLE FOR FINAL COORDINATION OF THESE ELEMENTS IF SITE CONDITIONS VARY FROM THE CIVIL / LANDSCAPE DESIGN DOCUMENTS. NOTIFY ARCHITECT WITH ANY DISCREPANCIES OR ALTERATIONS TO THE DESIGN DOCUMENTS THAT RESULT FROM SITE CONDITIONS.
- REFER TO CIVIL / LANDSCAPE DRAWINGS FOR FINAL GRADE ELEVATIONS AROUND BUILDING. FINISH GRADE TO BE A MINIMUM OF 6" BELOW FINISH FLOOR LEVEL UNLESS NOTED OTHERWISE.

#### DRAWING REFERENCES:

- REFER TO G006 FOR TYPICAL INTERIOR MOUNTING HEIGHTS FOR TOILET ROOM ACCESSORIES, ELECTRICAL OUTLETS, DATA
- OUTLETS, FIRE ALARM, FIRE STROBE, THERMOSTATS, ETC. REFER TO SHEET G200 FOR EXTERIOR WALL TYPE INFORMATION
- REFER TO SHEET G210 FOR INTERIOR WALL TYPE INFORMATION. UNLESS NOTED OTHERWISE, ALL INTERIOR WALLS TO BE B1.

#### Toch bldg hgt req's - **OI-3**

table 3.8-1 - dimensional matrix (4/20/20						
	(F)	(G)	(H)	(1)	(.	
ZONING DISTRICT	PRIMARY HEIGHT	SECONDARY HEIGHT	Street Setback	INTERIOR SETBACK	SOLAR	
$\bigcirc$	N1/A	N1/A	ام	ام	_ ا	

OI-3 | N/A | N/A | 0' | 0' | 0' NOTE: DUE TO THE BUILDING HEIGHT AND SOLAR SETBACK REQUIREMENTS BEING N/A AND 0, THIS INFORMATION HAS NOT BEEN INCLUDED ON THE EXTERIOR ELEVATIONS AS IT HAS NO BEARING ON THE OVERALL BUILDING DESIGN.

111 West Main Street **Durham, N.C. 27701** p 919.682.0368 f 919.688.5646 www.cjtpa.com

NC BOARD OF EXAMINERS FOR ENGINEERS AND SURVEYORS LIC # C-1209 NC BOARD OF LANDSCAPE ARCHITECTS LIC # C-104



Project:

**WEAVER** DAIRY

SHELL OFFICE

1165 WEAVER DAIRY CHAPEL HILL, NC

NOT ISSUED FOR

CONSTRUCTION

SPECIAL USE PERMIT

COMPOSITE

**EAST + WEST** 

**ELEVATIONS** 


Job Number: 15060

Drawn SAL
Checked
Date 11/30/17
Revisions

BUILDING

PIN: 9880350595

FINISH LEGEND - EXTERIOR MATERIALS

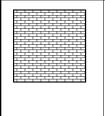

04 2000 UNIT MASONRY MATERIAL: CLAY MASONRY UNIT

SIZE: MODULAR UNIT FINISH: SMOOTH NOTE: PRIMARY FIELD BRICK

UM2 04 2000 UNIT MASONRY MATERIAL: CLAY MASONRY UNIT SIZE: MODULAR UNIT FINISH: SMOOTH STACK BOND

NOTE: SECONDARY COLOR

07 4213.23METAL COMPOSITE MATERIAL DESCRIPTION: Metal Composite Metal TYPE: Fire Retardant Core SIZE: Refer to Sections and Elevations THICKNESS: 0.157" Material, 2" Panel STYLE: Route and Return

08 4413 Glazed Aluminum Curtain Wall MANUFACTURER: OLDCASTLE BUILDING ENVELOPE TYPE: RELIANCE-SS CASSETTE SIZE: 2 1/2" x 8"

NOTE: REFER TO ELEVATIONS FOR GLAZING TYPE ES1 08 4113 Entrances and Storefronts

MANUFACTURER: OLDCASTLE BUILDING ENVELOPE TYPE: SERIES 3000 THERMAL MULTIPLANE SIZE: 2" x 4 1/2" STYLE: FRONT SET - 1" GLAZING NOTE: REFER TO ELEVATIONS FOR GLAZING

GL1 08 8000 Glazing

DESCRIPTION: Heat Strengthened Insulated

MANUFACTURER: Guardian TYPE: SunGuard SNX 51/23 SIZE: 1" Unit Width NOTE: Temper as indicated on Elevations

**GL1\*** 08 8000 Glazing DESCRIPTION: Heat Strengthened Insulated MANUFACTURER: Guardian

TYPE: SunGuard SNX 51/23

Apply Translucent Film on Surface 4 NOTE: Temper as indicated on Elevations

SIZE: 1" Unit Width

Sheet Number

Sheet Title: