### **EROSION CONTROL NOTES:**

- 1. EROSION AND SEDIMENT CONTROL DEVICES MUST BE INSTALLED AND INSPECTED PRIOR TO ANY GRADING ON SITE. THE CONTRACTOR SHALL CALL FOR A INSPECTION BY ORANGE COUNTY SEDIMENTATION AND EROSION CONTROL (SEC) ONCE INITIAL MEASURES ARE IN PLACE.
- 2. REQUIRED TREE PROTECTION FENCING SHALL BE INSTALLED AND A PRE-CONSTRUCTION CONFERENCE SCHEDULED WITH THE TOWN'S URBAN FORESTER PRIOR TO BEGINNING LAND DISTURBANCE.
- 3. SEDIMENT/EROSION CONTROL DEVICES MUST BE CHECKED AFTER EACH STORM EVENT. EACH DEVICE IS TO BE MAINTAINED OR REPLACED IF SEDIMENT ACCUMULATION HAS REACHED ONE HALF THE CAPACITY OF THE
- 4. IN ADDITION TO THE REQUIREMENT DURING CONSTRUCTION FOR THE INSPECTION OF EROSION CONTROL DEVICES AFTER EVERY RAINFALL, THE CONTRACTOR SHALL INSPECT THE EROSION AND SEDIMENT CONTROL DEVICES AND OFFSITE ROADWAYS DAILY, MAKE ANY NECESSARY REPAIRS OR ADJUSTMENTS TO THE DEVICES, REMOVE DEPOSITION OF WET OR DRY SILT ON ADJACENT ROADWAYS AND MAINTAIN INSPECTION LOGS DOCUMENTING THE DAILY INSPECTIONS AND ANY NECESSARY REPAIRS.
- 5. A COPY OF THE APPROVED EROSION CONTROL PLAN MUST BE ON FILE AT THE JOB SITE AT ALL TIMES.
- 6. CONSTRUCTION, MAINTENANCE, AND REMOVAL OF ALL EROSION CONTROL DEVICES ARE THE RESPONSIBILITY OF THE GRADING CONTRACTOR UNLESS OTHERWISE NOTED.
- 7. ANY GRADING BEYOND THE DENUDED LIMITS SHOWN ON THE PLAN IS A VIOLATION OF THE COUNTY EROSION CONTROL ORDINANCE AND IS SUBJECT TO A FINE.
- 8. NO DEBRIS SHALL BE TRACKED ONTO ANY EXISTING PAVED AREAS OR PUBLIC RIGHT OF WAY. IF THE SITUATION OCCURS WHERE MUD, ROCK AND DEBRIS IS TRACKED ONTO PAVEMENT, THE CONTRACTOR SHALL CLEAN THE
- PAVEMENT AND INSTALL ADDITIONAL MEASURES TO PREVENT THE FUTURE OCCURRENCE. 9. DURING THE CONSTRUCTION PHASE, ADDITIONAL EROSION AND SEDIMENT CONTROLS MAY BE REQUIRED IF THE PROPOSED MEASURES DO NOT CONTAIN THE SEDIMENT ON SITE. THE EROSION CONTROL INSPECTOR MAY REQUIRE ADDITIONAL FIELD MEASURES AS NECESSARY TO PROVIDE ADEQUATE PROTECTION FROM RECEIVING
- 10. PROTECTION OF EXISTING VEGETATION: AT THE START OF GRADING INVOLVING THE STRIPPING OF TOPSOIL OR LOWERING OF EXISTING GRADE AROUND A TREE, A CLEAN, SHARP, VERTICAL CUT SHALL BE MADE AT THE EDGE OF THE TREE SAVE AREA AT THE SAME TIME AS OTHER EROSION CONTROL MEASURES ARE INSTALLED. THE TREE PROTECTION FENCING SHALL BE INSTALLED ON THE SIDE OF THE CUT FARTHEST AWAY FROM THE TREE TRUNK AND SHALL REMAIN IN PLACE UNTIL ALL CONSTRUCTION IN THE VICINITY OF THE TREES IS COMPLETE. NO STORAGE OF MATERIALS, FILL, OR EQUIPMENT AND NO TRESPASSING SHALL BE ALLOWED WITHIN THE BOUNDARY OF THE PROTECTED AREA AND SHALL BE POSTED ON THE PROTECTION FENCE. A PROTECTION FENCE CONSTRUCTED OF MATERIAL RESISTANT TO DEGRADATION BY SUN, WIND, AND MOISTURE FOR THE DURATION OF THE CONSTRUCTION, SHALL BE INSTALLED AT THE SAME TIME AS THE EROSION CONTROL MEASURES AND SHALL BE IN PLACE UNTIL ALL CONSTRUCTION IN THE VICINITY OF THE TREES IS COMPLETE.
- 11. A CONSTRUCTION SEQUENCE HAS BEEN PROVIDED. INSTALLATION OF ALL PROPOSED SEDIMENTATION & EROSION CONTROL MEASURES IN THE SEQUENCE(S) PROVIDED AND MAINTENANCE OF THOSE DEVICES IS REQUIRED. THE CONTRACTOR MAY BE ALLOWED, WITH PRIOR APPROVAL FROM THE OWNER, TO COORDINATE CHANGES TO THE PLAN WITH THE ON-SITE SEDIMENTATION & EROSION CONTROL INSPECTOR AND THE
- 12. PROVIDE INLET PROTECTION AROUND ALL SITE STORM INLETS. PROTECT OPEN PIPES UNDER CONSTRUCTION WITH EITHER PLYWOOD OR WITH MESH AND GRAVEL WEIRS. RUNOFF SHALL NOT BE ALLOWED IN ANY OPEN
- 13. CONTRACTOR TO VERIFY SILT FENCE OUTLET PLACEMENT AT LOW POINTS AS THEY EXIST OR DEVELOP. ADDITIONAL SILT FENCE OUTLETS MAY BE REQUIRED TO PREVENT EROSION DURING AND AFTER CONSTRUCTION AND LAND DISTURBANCE ACTIVITIES. IF ADDITIONAL SILT FENCE OUTLETS ARE NECESSARY, CONTRACTOR TO ADD ADDITIONAL SILT FENCE OUTLETS PER ENGINEER. NCDEQ EROSION CONTROL INSPECTOR. OR OWNER DIRECTION. IF PONDING OF WATER OR SEDIMENT OCCURS ALONG SILT FENCE, CONTRACTOR SHALL INSTALL AN ADDITIONAL SILT FENCE OUTLET.
- 14. TEMPORARY DIVERSIONS SHALL BE MAINTAINED DAILY BY CONTRACTOR SO THAT THEY ARE FUNCTIONAL AT THE END OF EACH WORKDAY AND WHEN STOPPING WORK FOR RAIN.

### **CONSTRUCTION SEQUENCE - STAGE 1**

1. OBTAIN A LAND-DISTURBING PERMIT AND SCHEDULE A PRECONSTRUCTION CONFERENCE WITH ORANGE COUNTY EROSION CONTROL OFFICER, WESLEY POOLE (919)245.2587. THE PRECONSTRUCTION MEETING SHALL INCLUDE A REPRESENTATIVE FROM OWASA, TOWN OF CHAPEL HILL, TOWN OF CHAPEL HILL URBAN

NOTE: INSTALL A RURAL TYPE MAILBOX ON THE SITE TO HOLD A COPY OF THE APPROVED EROSION CONTROL PLAN AND TO PROVIDE A PLACE FOR INSPECTORS TO LEAVE INSPECTION REPORT, COMPLIANCE NOTICES, ETC.

2. INSTALL GRAVEL CONSTRUCTION ENTRANCE(S) PER PLAN. ALSO INSTALL TEMPORARY SILT FENCING WITH OUTLETS AS SHOWN

3. CONTRACTOR SHALL CLEAR ONLY THOSE AREAS NECESSARY TO ACCESS AND INSTALL INITIAL PERIMETER

- DEVICES. INSTALL INLET PROTECTION ON EXISTING INLETS AS SHOWN.
- 4. INSTALL INLET PROTECTION PER ORANGE COUNTY SEC STANDARDS AND SPECIFICATIONS ON ALL SPECIFIED
- 5. CALL 919.245.2587 FOR ON-SITE INSPECTION BY ORANGE COUNTY EROSION CONTROL.
- 6. BEGIN CLEARING, DEMOLITION OF EXISTING ASPHALT AND GRAVEL AREAS, AND GENERAL GRADING OF STAGE 1
- 7. NO MUD SHALL BE TRACKED ONTO EXISTING PAVEMENT OR A NOTICE OF VIOLATION FROM THE EROSION CONTROL DEPARTMENT MAY ENSUE. ADDITIONAL MEASURES MAY BE NECESSARY TO ASSURE THAT NO SEDIMENT LEAVES THE SITE.
- 8. PROVIDE ALL DISTURBED AREAS WITH GROUND COVER WITHIN 14 CALENDAR DAYS AFTER COMPLETION OF ANY PHASE OF CLEARING, GRUBBING OR GRADING. THE SEEDING, SEEDBED PREPARATION, MULCH AND/OR ROLLED EROSION CONTROL PRODUCT INSTALLATION MUST BE IN ACCORDANCE WITH THE SEEDING SCHEDULE PROVIDED IN THIS S&E PLAN. NOTE: SLOPES IN EXCESS OF 3H:1V SHALL BE STABILIZED WITHIN 7 DAYS AND FOR MODERATE SLOPES (SLOPES LESS THAN 3H:1V) SHALL BE STABILIZED WITHIN 14 DAYS.
- 9. WITH APPROVAL FROM ORANGE COUNTY EROSION CONTROL INSPECTOR, CONTINUE TO STAGE 2.

### CONSTRUCTION SEQUENCE - STAGE 2

- CONTINUE MASS GRADING FROM STAGE 1.
- 2. UTILIZE THE SUITABLE BACKFILL MATERIAL FROM EXCAVATION. RELOCATE AND ADJUST TEMPORARY DIVERSION DITCHES AS NECESSARY. DIVERSION DITCHES SHALL REMAIN IN PLACE AND OPERATIONAL UNTIL SITE IS STABILIZED.
- 3. CONSTRUCT STORM DRAIN SYSTEM AS SHOWN.
- 4. INSTALL INLET PROTECTION ON ALL INLET STRUCTURES DURING CONSTRUCTION.
- 5. PROVIDE ALL DISTURBED AREAS WITH GROUND COVER WITHIN 14 CALENDAR DAYS AFTER COMPLETION OF ANY PHASE OF CLEARING, GRUBBING OR GRADING. THE SEEDING, SEEDBED PREPARATION, MULCH AND/OR ROLLED EROSION CONTROL PRODUCT INSTALLATION MUST BE IN ACCORDANCE WITH THE SEEDING SCHEDULE PROVIDED IN THIS S&E PLAN. NOTE: SLOPES IN EXCESS OF 3H:1V SHALL BE STABILIZED WITHIN 7 DAYS AND FOR MODERATE SLOPES (SLOPES LESS THAN 3H:1V) SHALL BE STABILIZED WITHIN 14 DAYS.
- 6. AT THE CONCLUSION OF BUILDING OR IF LAND-DISTURBING ACTIVITY IS STOPPED FOR MORE THAN 14 CONSECUTIVE CALENDAR DAYS, PERMANENT VEGETATIVE COVER SHALL BE INSTALLED IN ACCORDANCE WITH
- 7. WHEN SITE IS AT FINAL GRADE AND NO FURTHER GRADING IS NECESSARY, CONTRACTOR SHALL STABILIZE PORTIONS OF THE SITE WITH SEED/MULCH UNTIL FINAL LANDSCAPING IS INSTALLED.

### **CONSTRUCTION SEQUENCE - STAGE 3**

- 1. CONTINUE MASS GRADING FROM STAGE 2.
- 2. UTILIZE THE SUITABLE BACKFILL MATERIAL FROM EXCAVATION. RELOCATE AND ADJUST TEMPORARY DIVERSION DITCHES AS NECESSARY. DIVERSION DITCHES SHALL REMAIN IN PLACE AND OPERATIONAL UNTIL SITE IS STABILIZED.
- 3. PROVIDE ALL DISTURBED AREAS WITH GROUND COVER WITHIN 14 CALENDAR DAYS AFTER COMPLETION OF ANY PHASE OF CLEARING, GRUBBING OR GRADING. THE SEEDING, SEEDBED PREPARATION, MULCH AND/OR ROLLED EROSION CONTROL PRODUCT INSTALLATION MUST BE IN ACCORDANCE WITH THE SEEDING SCHEDULE PROVIDED IN THIS S&E PLAN. NOTE: SLOPES IN EXCESS OF 3H:1V SHALL BE STABILIZED WITHIN 7 DAYS AND FOR MODERATE SLOPES (SLOPES LESS THAN 3H:1V) SHALL BE STABILIZED WITHIN 14 DAYS.
- 4. AT THE CONCLUSION OF BUILDING OR IF LAND-DISTURBING ACTIVITY IS STOPPED FOR MORE THAN 14 CONSECUTIVE CALENDAR DAYS, PERMANENT VEGETATIVE COVER SHALL BE INSTALLED IN ACCORDANCE WITH
- 5. WHEN SITE IS AT FINAL GRADE AND NO FURTHER GRADING IS NECESSARY, CONTRACTOR SHALL STABILIZE PORTIONS OF THE SITE WITH SEED/MULCH UNTIL FINAL LANDSCAPING IS INSTALLED.
- 6. WHEN CONSTRUCTION IS COMPLETE, CALL OCEC TO OBTAIN FINAL INSPECTION AND CERTIFICATE OF COMPLETION TO CLOSE OUT EROSION CONTROL PERMIT.

### **TEMPORARY SEEDING SCHEDULE**

SEEDING DATE	SEEDING MIXTURE	APPLICATION RA
JAN 1 — MAY 1	RYE (GRAIN)	120 LBS/AC
	KOBE LESPEDEZA	50 LBS/AC
MAY 1 - AUG 15	GERMAN MILLET	40 LBS/AC
AUG 15 - DEC 30	RYE (GRAIN)	120 LBS/AC

### SOIL AMENDMENTS FOLLOW RECOMMENDATIONS OF SOIL TESTS OR APPLY 4,000 LB/AC GROUND AGRICULTURE LIMESTONE AND 750 LB/AC 10-10-10 FERTILIZER (FROM AUG 15 - DEC 30, INCREASE 10-10-10 FERTILIZER TO 1000 LB/AC).

APPLY 4000 LB/AC STRAW, ANCHOR STRAW BY TACKING WITH ASPHALT, NETTING, OR A MULCH ANCHORING TOOL. A DISK WITH BLADES SET NEARLY STRAIGHT CAN BE USED AS A MULCH ANCHORING TOOL.

### <u>MAINTENANCE</u>

REFERTILIZE IF GROWTH IS NOT FULLY ADEQUATE. RESEED, REFERTILIZE, AND MULCH IMMEDIATELY FOLLOWING EROSION OR OTHER DAMAGE.

### JAN 1 - AUG 15:

REPAIR AND REFERTILIZE DAMAGED AREAS IMMEDIATELY. TOP DRESS WITH 50 LB/AC AUG 15 - DEC 30: OF NITROGEN IN MARCH. IF IT IS NECESSARY TO EXTEND TEMPORARY COVER

### BEYOND JUNE 15, OVERSEED WITH 50 LB/AC KOBE LESPEDEZA IN LATE FEBRUARY OR EARLY MARCH.

NOTE: USE THE TEMPORARY SEEDING SCHEDULE ONLY WHEN DATE IS NOT CORRECT TO USE THE PERMANENT

### PERMANENT SEEDING SCHEDULE

SEEDING DATE	SEEDING MIXTURE	APPLICATION RATE
AUG 25 - OCT (BEST)	TALL FESCUE	200 LBS/AC
	RYE (GRAIN)	50 LBS/AC
	GERMAN MILLET	50 LBS/AC
FEB - APR 15 (POSSIBLE)	TALL FESCUE	200 LBS/AC
	RYE (GRAIN)	50 LBS/AC
	GERMAN MILLET	50 LBS/AC

FOLLOW RECOMMENDATIONS OF SOIL TESTS OR APPLY 4,000 LB/AC GROUND AGRICULTURE LIMESTONE AND 1000 LB/AC 10-10-10 FERTILIZER.

### APPLY 4000 LB/AC STRAW. ANCHOR STRAW BY TACKING WITH ASPHALT, NETTING, OR A MULCH ANCHORING TOOL. A DISK WITH BLADES SET NEARLY STRAIGHT CAN BE USED AS A MULCH ANCHORING TOOL.

INSPECT AND REPAIR MULCH FREQUENTLY. REFERTILIZE IN LATE WINTER OF THE FOLLOWING YEAR; USE SOIL TESTS OR APPLY 150 LB/AC 10-10-10 FERTLIZER. MOW REGULARLY TO A HEIGHT OF 2-4 INCHES.

### SEEDBED PREPARATION

FERTILIZER: 17 LBS / 1,000 SF

AREAS TO BE SEEDED TO BE SCARIFIED 4" DEEP. A FIRM, WELL PULVERIZED, UNIFORM SEEDBED SHOULD BE PROVIDED. FERTILIZER SHALL BE PLACED DURING SCARIFICATION AS FOLLOWS: LIME: 45 LBS / 1,000 SF PHOSPHOROUS: 20 LBS / 1,000 SF

## CONTRACTOR'S MAINTENANCE PLAN:

- ALL EROSION AND SEDIMENT CONTROL MEASURES SHALL BE CHECKED FOR STABILITY AND OPERATION FOLLOWING EVERY RUNOFF-PRODUCING RAINFALL BUT IN NO CASE LESS THAN ONCE EVERY WEEK. ANY NEEDED REPAIRS SHALL BE MADE IMMEDIATELY TO MAINTAIN ALL MEASURES AS DESIGNED.
- SEDIMENT BASINS SHALL BE INSPECTED REGULARLY DURING LAND DISTURBING ACTIVITIES AND AFTER EACH RUNOFF-PRODUCING RAINFALL. SEDIMENT SHALL BE REMOVED AND THE BASIN RESTORED TO ITS ORIGINAL DIMENSIONS WHEN SEDIMENT HAS ACCUMULATED TO ONE-HALF THE DESIGN DEPTH OF EACH BASIN. PORTIONS OF THE BASIN'S GRAVEL FACING THAT ARE CONTAMINATED BY SEDIMENT SHALL BE REPLACED WITH FRESH GRAVEL DURING EACH SEDIMENT REMOVAL EPISODE.
- SEDIMENT FENCES SHALL BE INSPECTED AT LEAST ONCE A WEEK AND AFTER EACH RUNOFF PRODUCING RAINFALL. REPAIRS SHALL BE MADE IMMEDIATELY. SEDIMENT DEPOSITS SHALL BE REMOVED AS NEEDED TO PROVIDE ADEQUATE STORAGE VOLUME FOR THE NEXT RAINFALL EVENT, AND TO REDUCE PRESSURE ON THE FENCE. FENCING MATERIALS AND SEDIMENT DEPOSITS SHALL BE REMOVED, AND THE AREA BROUGHT TO GRADE FOLLOWING STABILIZATION OF UPGRADIENT DISTURBED AREAS.
- 4. DIVERSION DITCHES MUST REMAIN IN PLACE UNTIL PROJECT IS STABILIZED.
- EROSION CONTROL DURING SITE CONSTRUCTION WILL BE ACCOMPLISHED BY USE OF SILT FENCING AND SILT FENCE OUTLETS. DEVICES MUST BE EMPTIED WHEN SEDIMENT ACCUMULATION HAS REACHED 6" DEPTH.

GROUND STABILI	ROUND STABILIZATION			
SITE AREA DESCRIPTION	STABILIZATION TIME FRAME	STABILIZATION TIME FRAME EXCEPTIONS		
PERIMETER DIKES, SWALES, DITCHES AND SLOPES	7 DAYS	NONE		
HIGH QUALITY WATER (HQW) ZONES	7 DAYS	NONE		
SLOPES STEEPER THAN 3:1	7 DAYS	IF SLOPES ARE 10' OR LES IN LENGTH AND ARE NO STEEPER THAN 2:1, 14 DAYS ARE ALLOWED		
SLOPES 3:1 OR FLATTER	14 DAYS	7-DAYS FOR SLOPES GREATER THAN 50 FEET I LENGTH		
ALL OTHER AREAS WITH SLOPES FLATTER THAN 4:1	14 DAYS	NONE (EXCEPT FOR PERIMETERS AND HQW ZONES)		

### **BUILDING WASTES HANDLING**

DEDICATED AREAS FOR DEMOLITION, CONSTRUCTION AND OTHER WASTES MUST BE LOCATED 50' FROM STORM DRAINS AND STREAMS UNLESS NO REASONABLE ALTERNATIVES AVAILABLE.

CONCRETE MATERIALS MUST BE CONTROLLED TO AVOID CONTACT



CONTRACTOR SHALL NOTIFY "NC811" (811) OR (1-800-632-4949) AT LEAST 3 FULL BUSINESS DAYS PRIOR TO BEGINNING CONSTRUCTION OR EXCAVATION TO HAVE EXISTING UTILITIES LOCATED. CONTRACTOR SHALL CONTACT ANY LOCAL UTILITIES THAT PROVIDE THEIR OWN LOCATOR SERVICES INDEPENDENT OF "NC811". REPORT ANY DISCREPANCIES TO THE ENGINEER IMMEDIATELY

EARTHEN-MATERIAL STOCKPILES MUST BE LOCATED 50' FROM STORM DRAINS AND STREAMS UNLESS NO REASONABLE ALTERNATIVES AVAILABLE.

WITH SURFACE WATER, WETLANDS, OR BUFFERS.



PLAN INFORMATION

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Durham, NC 27713

phone 919. 361. 5000

fax 919. 361. 2269

license number: C-0293

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127 W. WORTHINGTON AVE, SUITE 290

CHARLOTTE, NORTH CAROLINA 28203

CLIENT

RAM REALTY

PROJECT NO. 2021110354 FILENAME RAM19000-EC1

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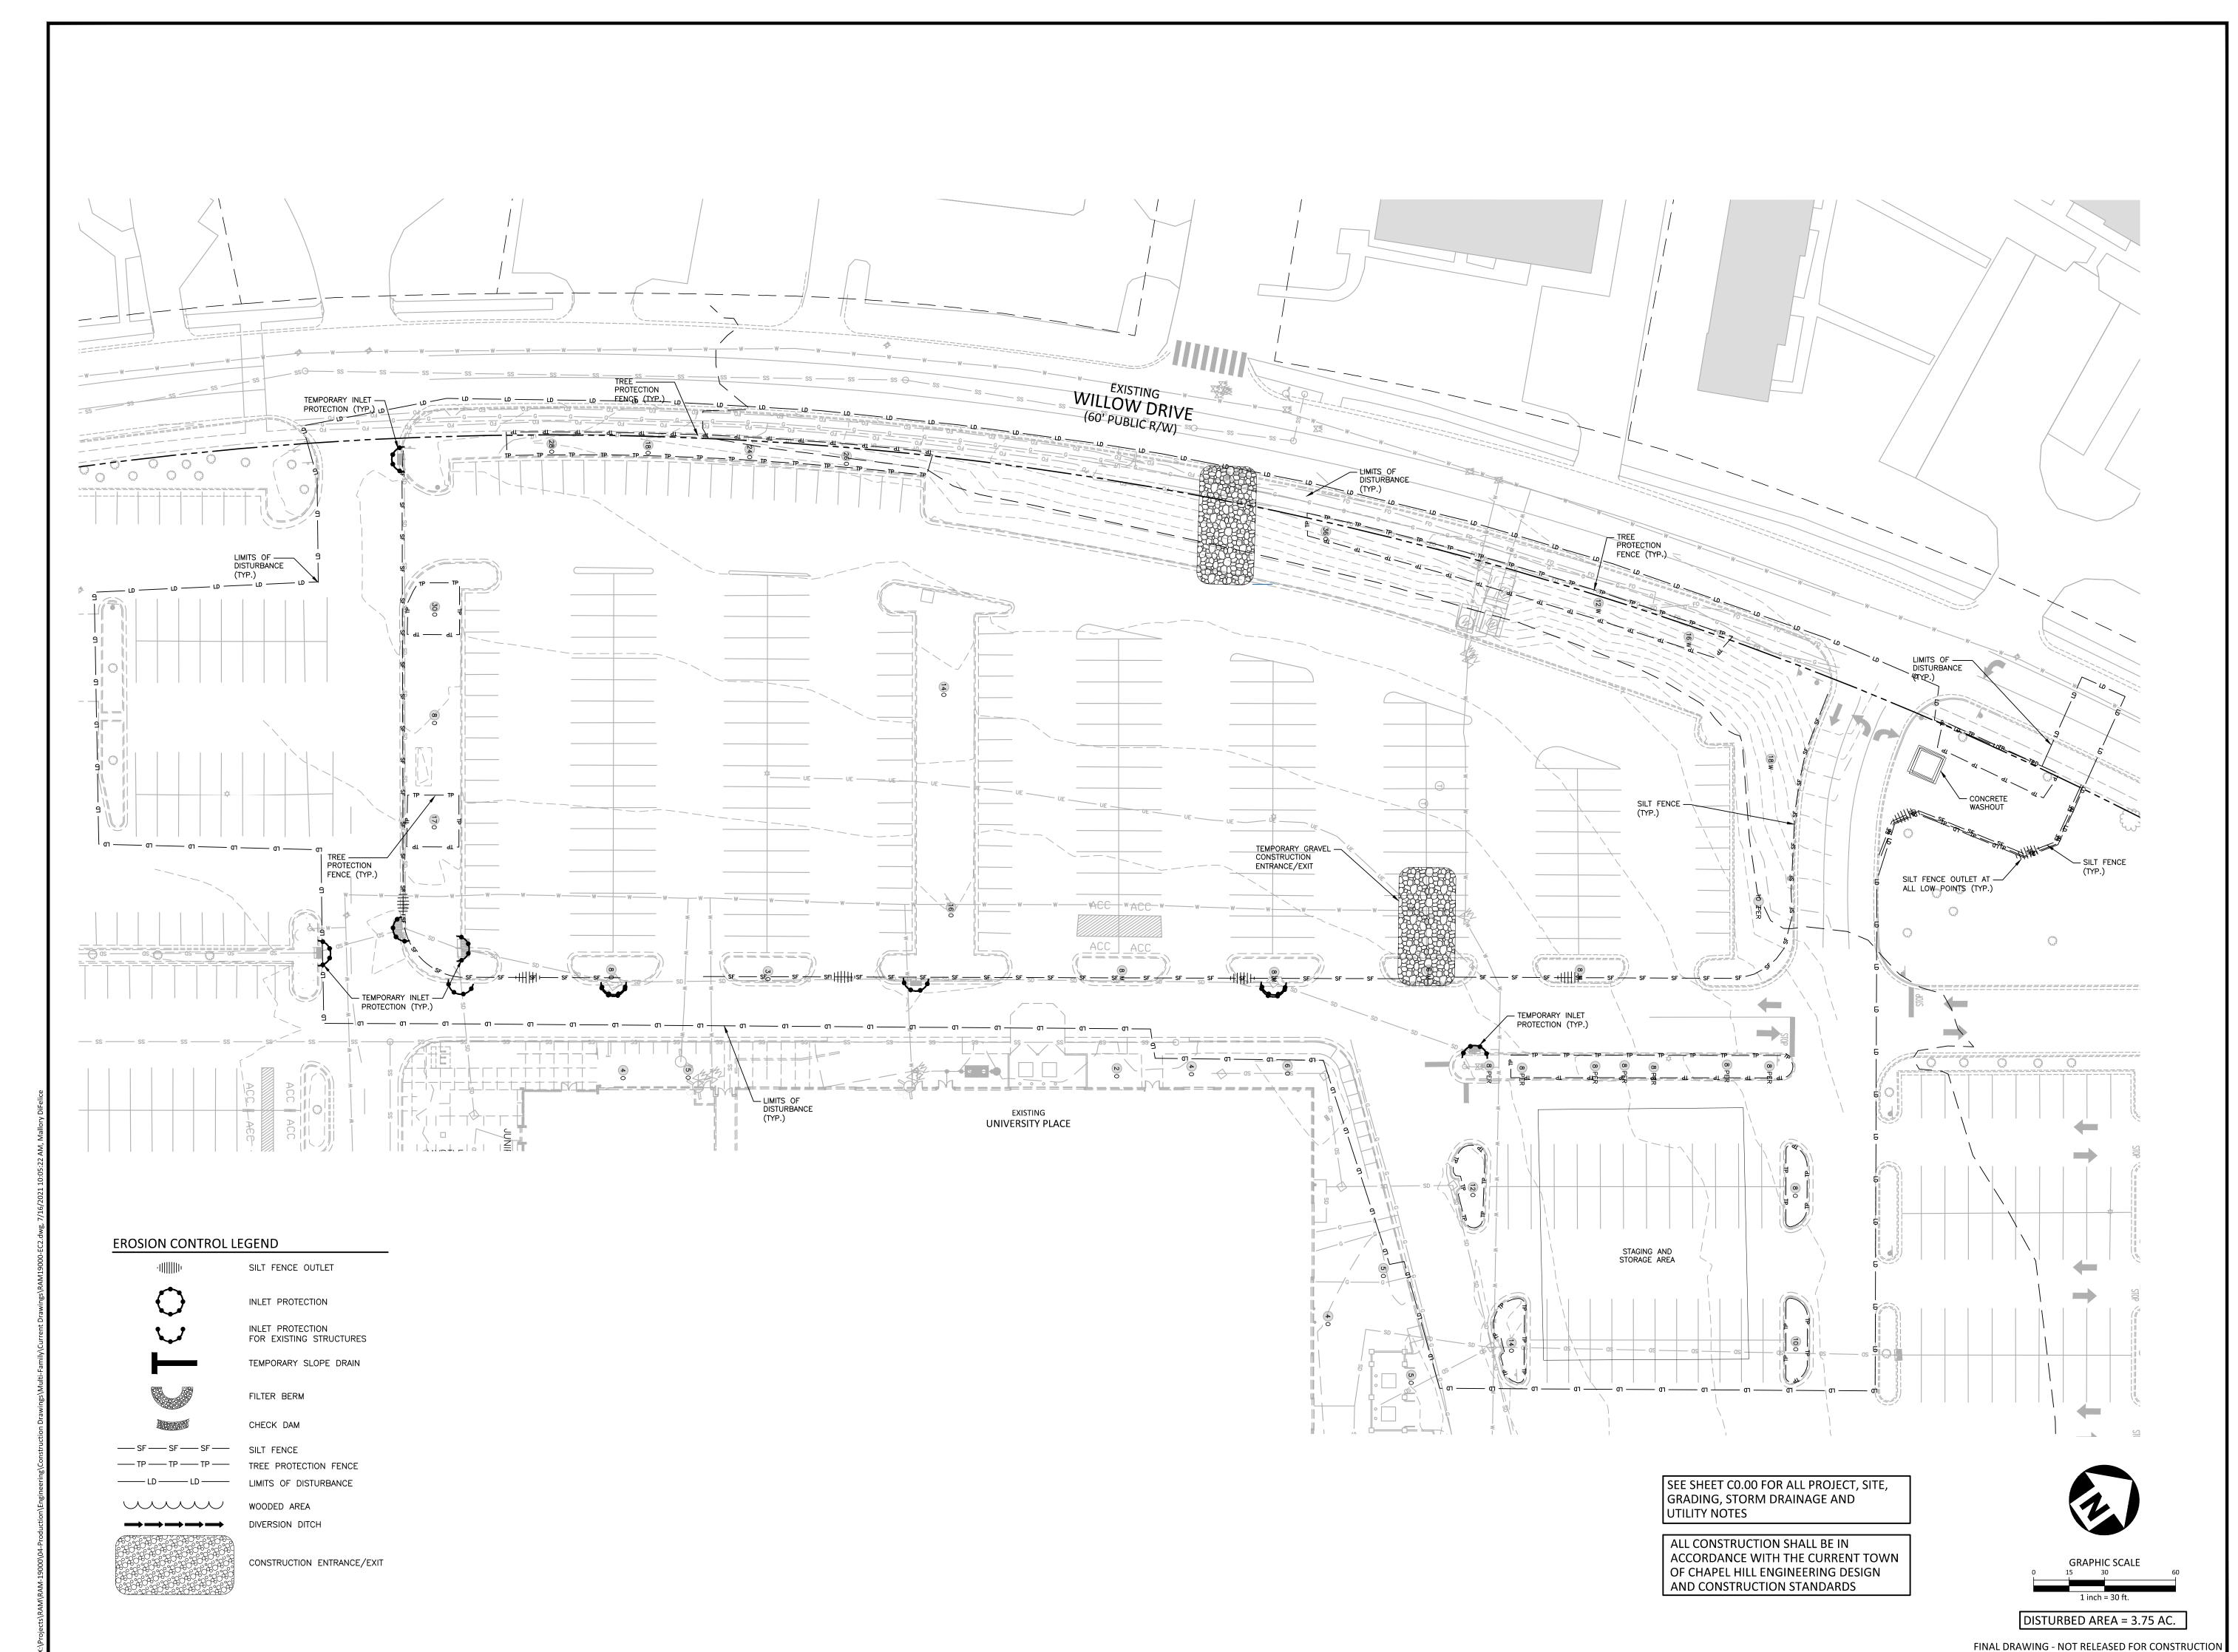
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FINAL DRAWING - NOT RELEASED FOR CONSTRUCTION

**EROSION CONTROL** 





## McAdams

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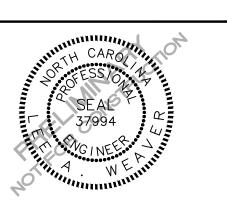
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RAM REALTY

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## NIVERSITY PLACE MULTI-FAMILY NG COMPLIANCE PERMIT



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### PLAN INFORMATION

PROJECT NO. 2021110354

FILENAME RAM19000-EC2

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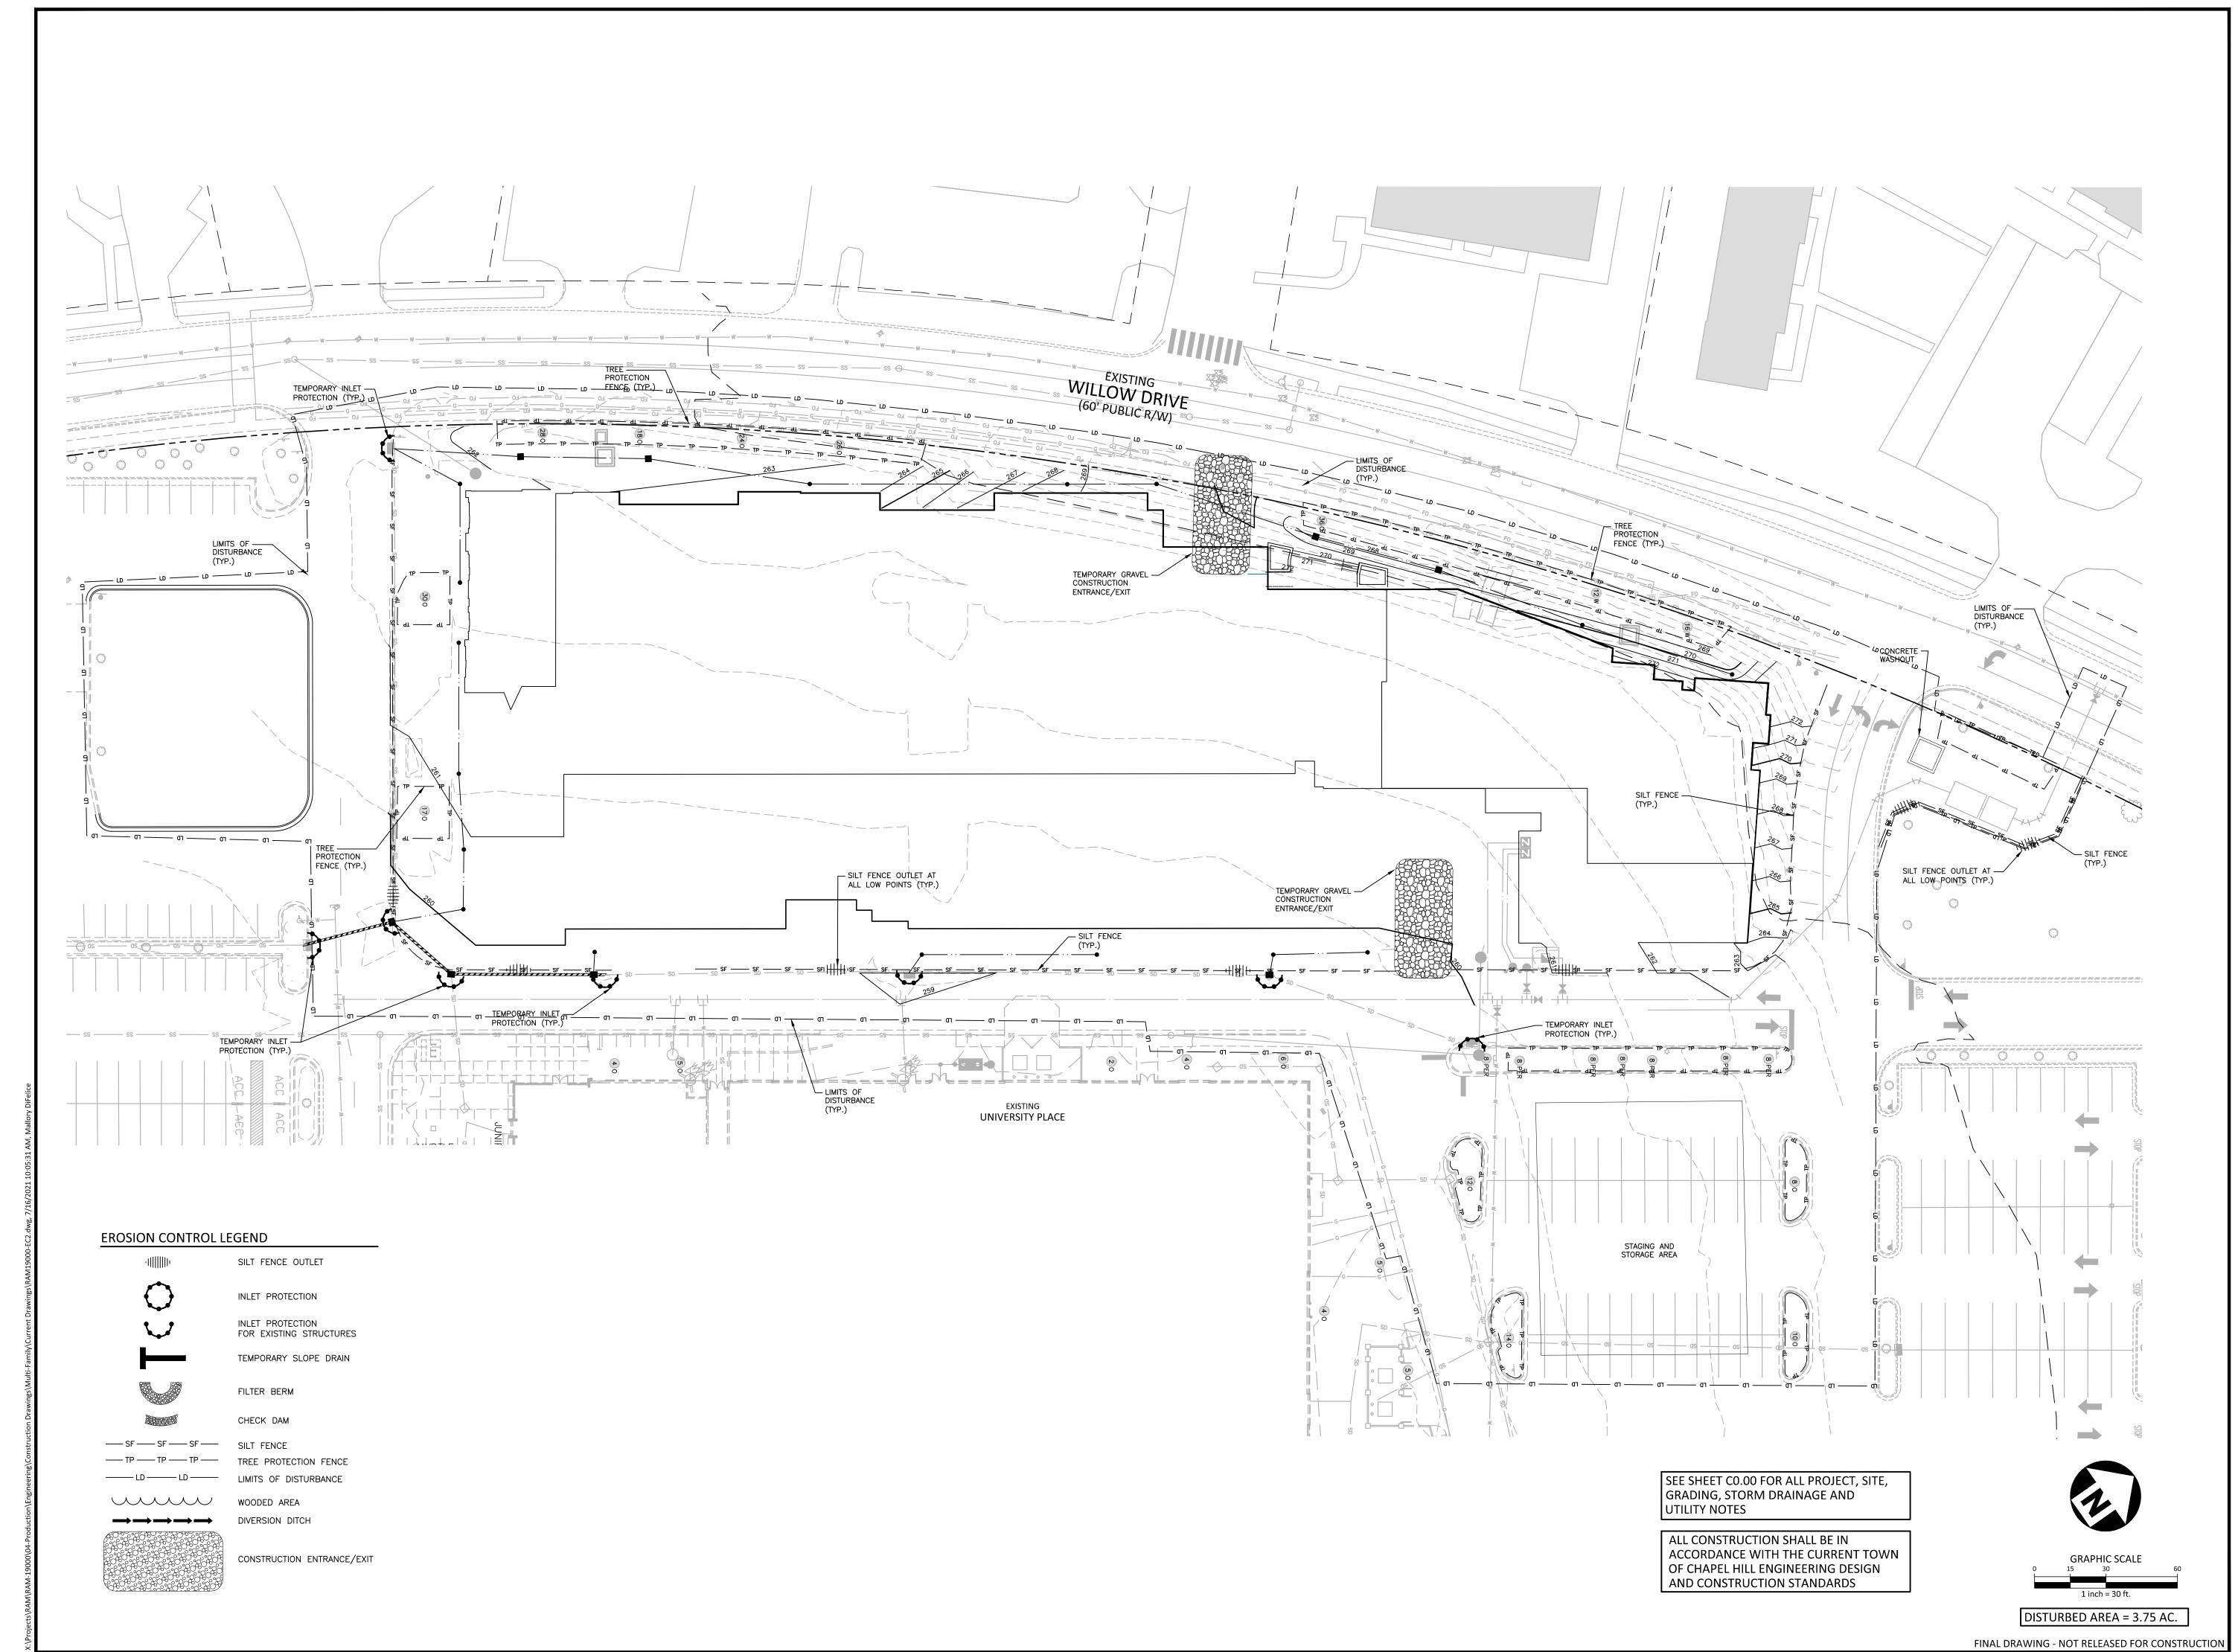
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DATE 07. 16. 2021

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EROSION CONTROL PLAN - STAGE 1

C6.01





## McAdams

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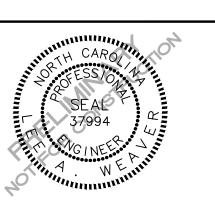
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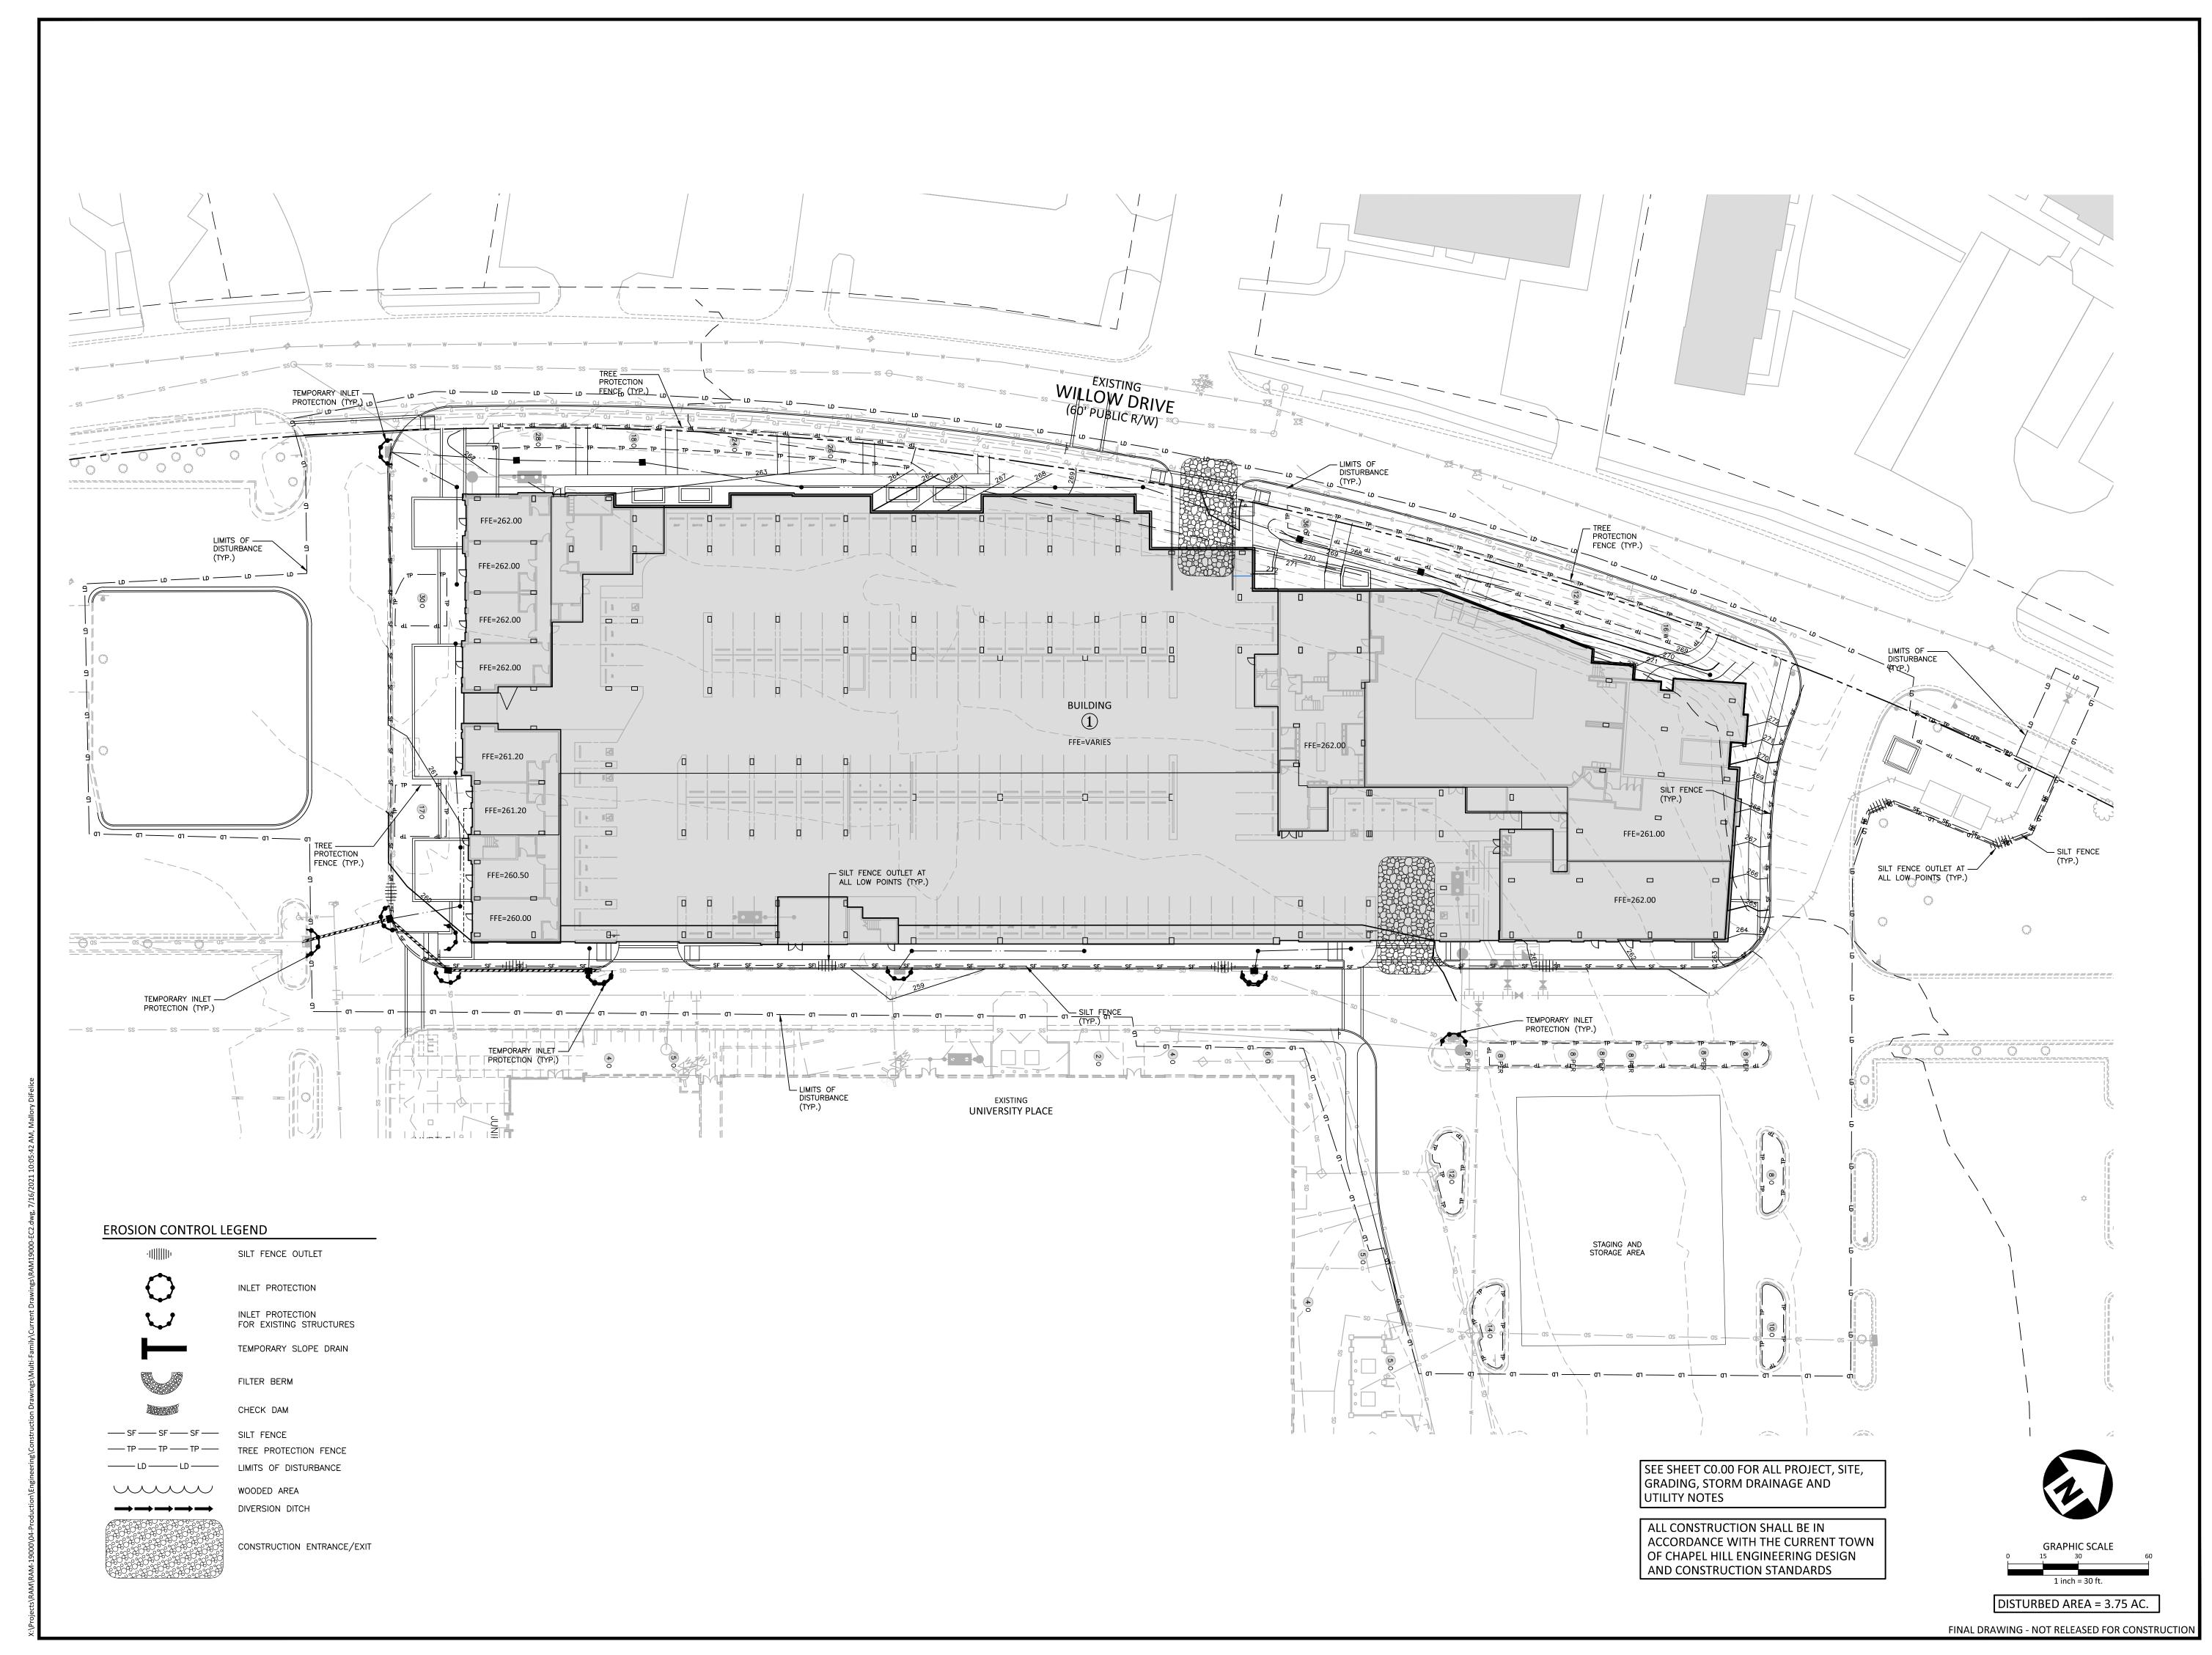
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DATE 07. 16. 2021

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EROSION CONTROL PLAN - STAGE 2

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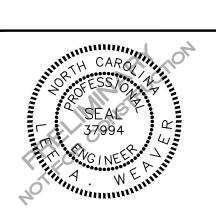
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## **REVISIONS**

NO. DATE


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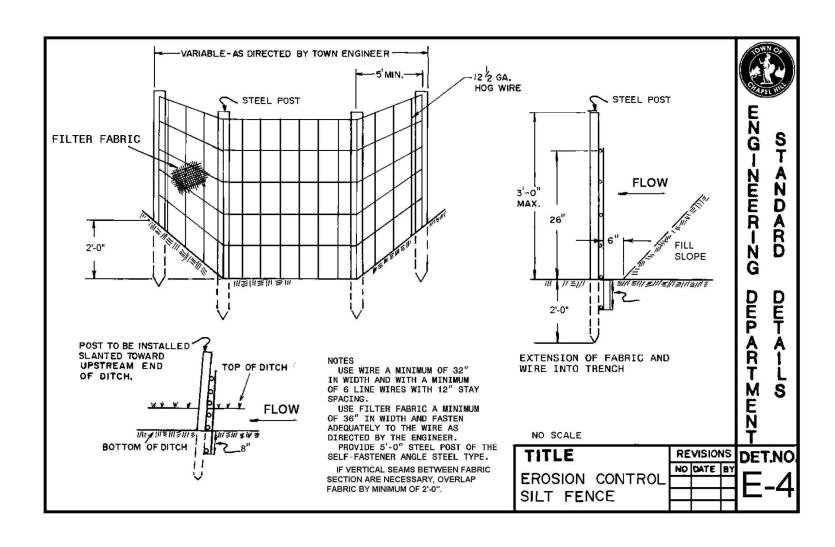
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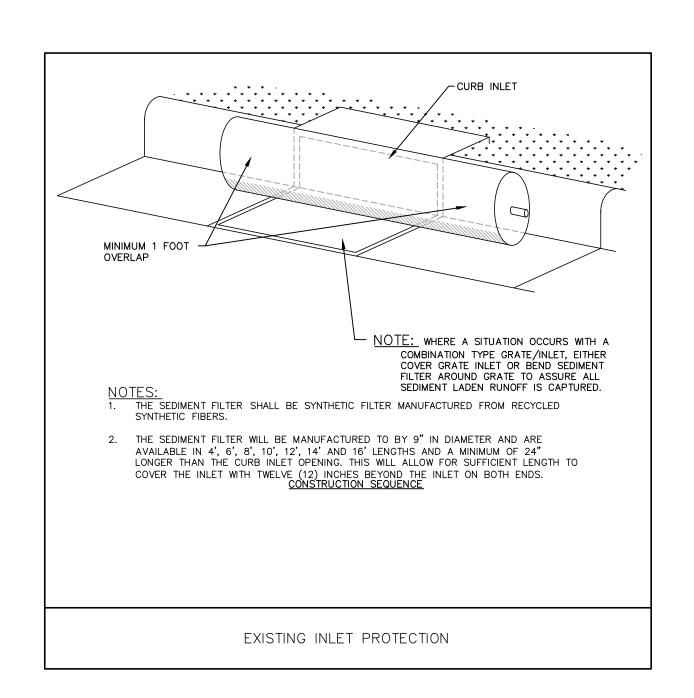
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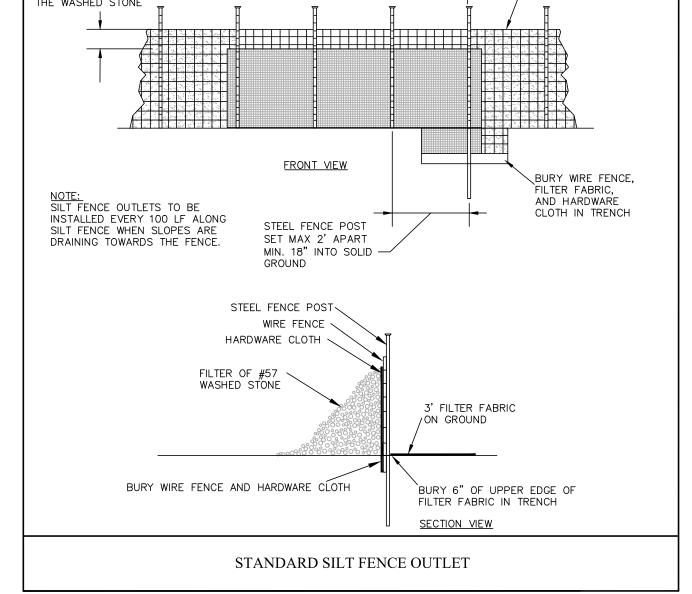
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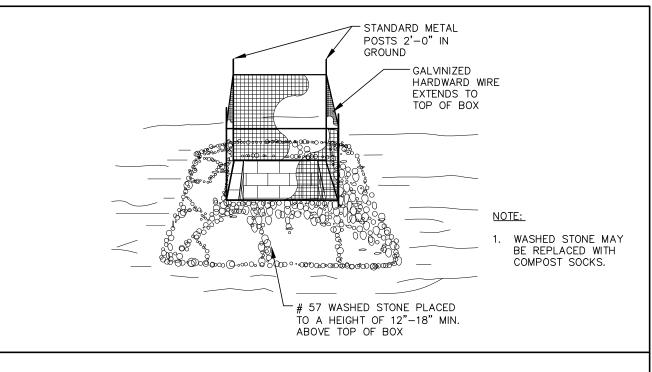
**EROSION CONTROL** PLAN - STAGE 3









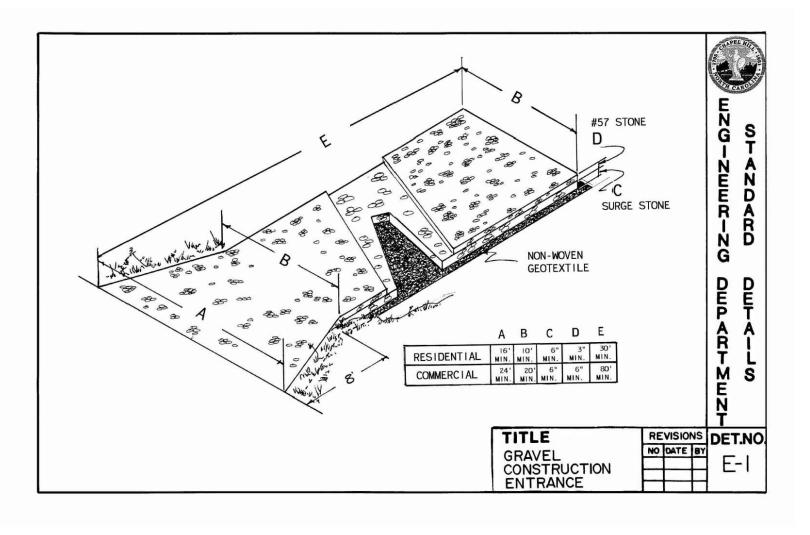

STANDARD POST & GRAVEL INLET PROTECTION

BLOCK AND GRAVEL INLET PROTECTION MAINTENANCE INSPECT THE BARRIER AT LEAST WEEKLY AND AFTER EACH SIGNIFICANT (1/2 INCH OR GREATER) RAINFALL AND MAKE REPAIRS AS NEEDED. REMOVE SEDIMENT AS NECESSARY TO PROVIDE ADEQUATE STORAGE VOLUME FOR SUBSEQUENT

WHEN THE CONTRIBUTING DRAINAGE AREA HAS BEEN ADEQUATELY STABILIZED, REMOVE ALL MATERIALS AND ANY UNSTABLE SOIL, AND EITHER SALVAGE OR DISPOSE OF IT PROPERLY. BRING THE DISTURBED AREA TO PROPER GRADE, THEN SMOOTH AND COMPACT IT.

APPROPRIATELY STABILIZE ALL BARE AREAS AROUND THE INLET.

TOP OF SILT FENCE MUST BE AT LEAST 1 ABOVE THE TOP OF SILT FENCE THE WASHED STONE

SILT FENCE OUTLET MAINTENANCE

REMOVE SEDIMENT WHEN HALF OF STONE OUTLET IS COVERED.

REPLACE STONE AS NEEDED TO ENSURE DEWATERING.


UNDERMINING THE FENCE DURING CLEANOUT.


INSPECT SEDIMENT FENCES AT LEAST ONCE A WEEK AND AFTER EACH RAINFALL. MAKE ANY REQUIRED REPAIRS IMMEDIATELY

SHOULD THE FABRIC OF A SEDIMENT FENCE COLLAPSE, TEAR, DECOMPOSE OR BECOME INEFFECTIVE, REPLACE IT PROMPTLY.

REMOVE SEDIMENT DEPOSITS AS NECESSARY TO PROVIDE ADEQUATE STORAGE VOLUME FOR THE NEXT RAIN AND TO REDUCE PRESSURE ON THE FENCE. TAKE CARE TO AVOID

REMOVE ALL FENCING MATERIALS AND UNSTABLE SEDIMENT DEPOSITS AND BRING THE AREA TO GRADE AND STABILIZE IT AFTER THE CONTRIBUTING DRAINAGE AREA HAS BEEN PROPERLY STABILIZED.

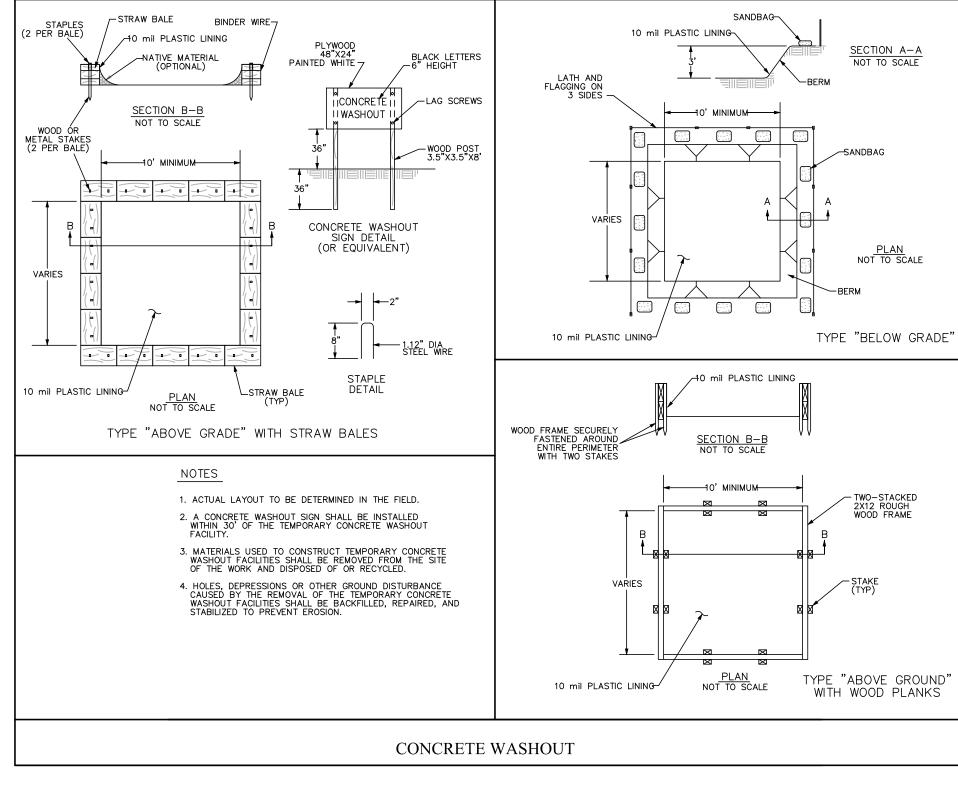

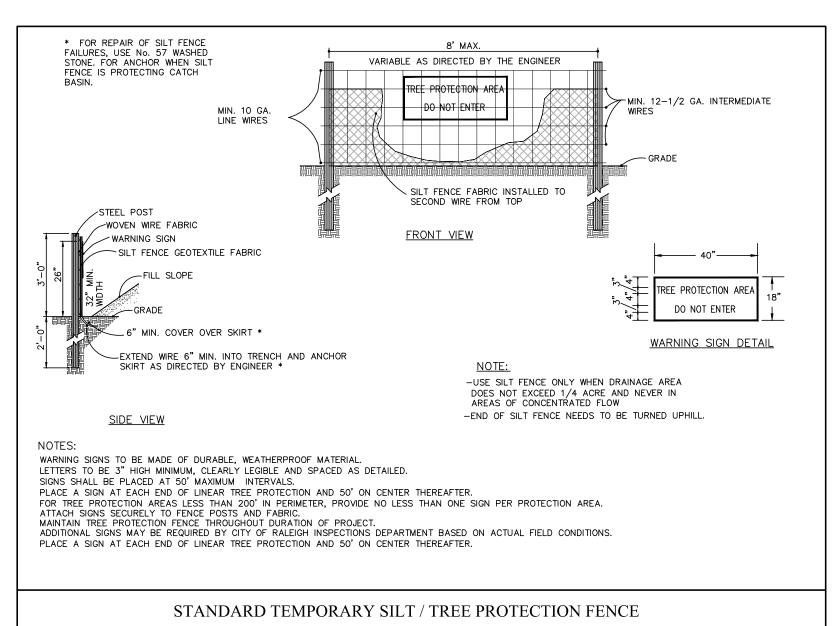

### SILT FENCE MAINTENANCE


INSPECT SEDIMENT FENCES AT LEAST ONCE A WEEK AND AFTER EACH RAINFALL. MAKE ANY REQUIRED REPAIRS IMMEDIATELY

SHOULD THE FABRIC OF A SEDIMENT FENCE COLLAPSE, TEAR, DECOMPOSE OR BECOME INEFFECTIVE, REPLACE IT PROMPTLY.

REMOVE SEDIMENT DEPOSITS AS NECESSARY TO PROVIDE ADEQUATE STORAGE VOLUME FOR THE NEXT RAIN AND TO REDUCE PRESSURE ON THE FENCE. TAKE CARE TO AVOID UNDERMINING THE FENCE DURING CLEANOUT.

REMOVE ALL FENCING MATERIALS AND UNSTABLE SEDIMENT DEPOSITS AND BRING THE AREA TO GRADE AND STABILIZE IT AFTER THE CONTRIBUTING DRAINAGE AREA HAS BEEN PROPERLY

The John R. McAdams Company, Inc. 2905 Meridian Parkway Durham, NC 27713 phone 919. 361. 5000 fax 919. 361. 2269 license number: C-0293 www.mcadamsco.com CLIENT RAM REALTY 127 W. WORTHINGTON AVE, SUITE 290 CHARLOTTE, NORTH CAROLINA 28203

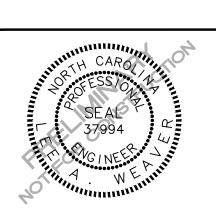

### **REVISIONS**

NO. DATE

### PLAN INFORMATION


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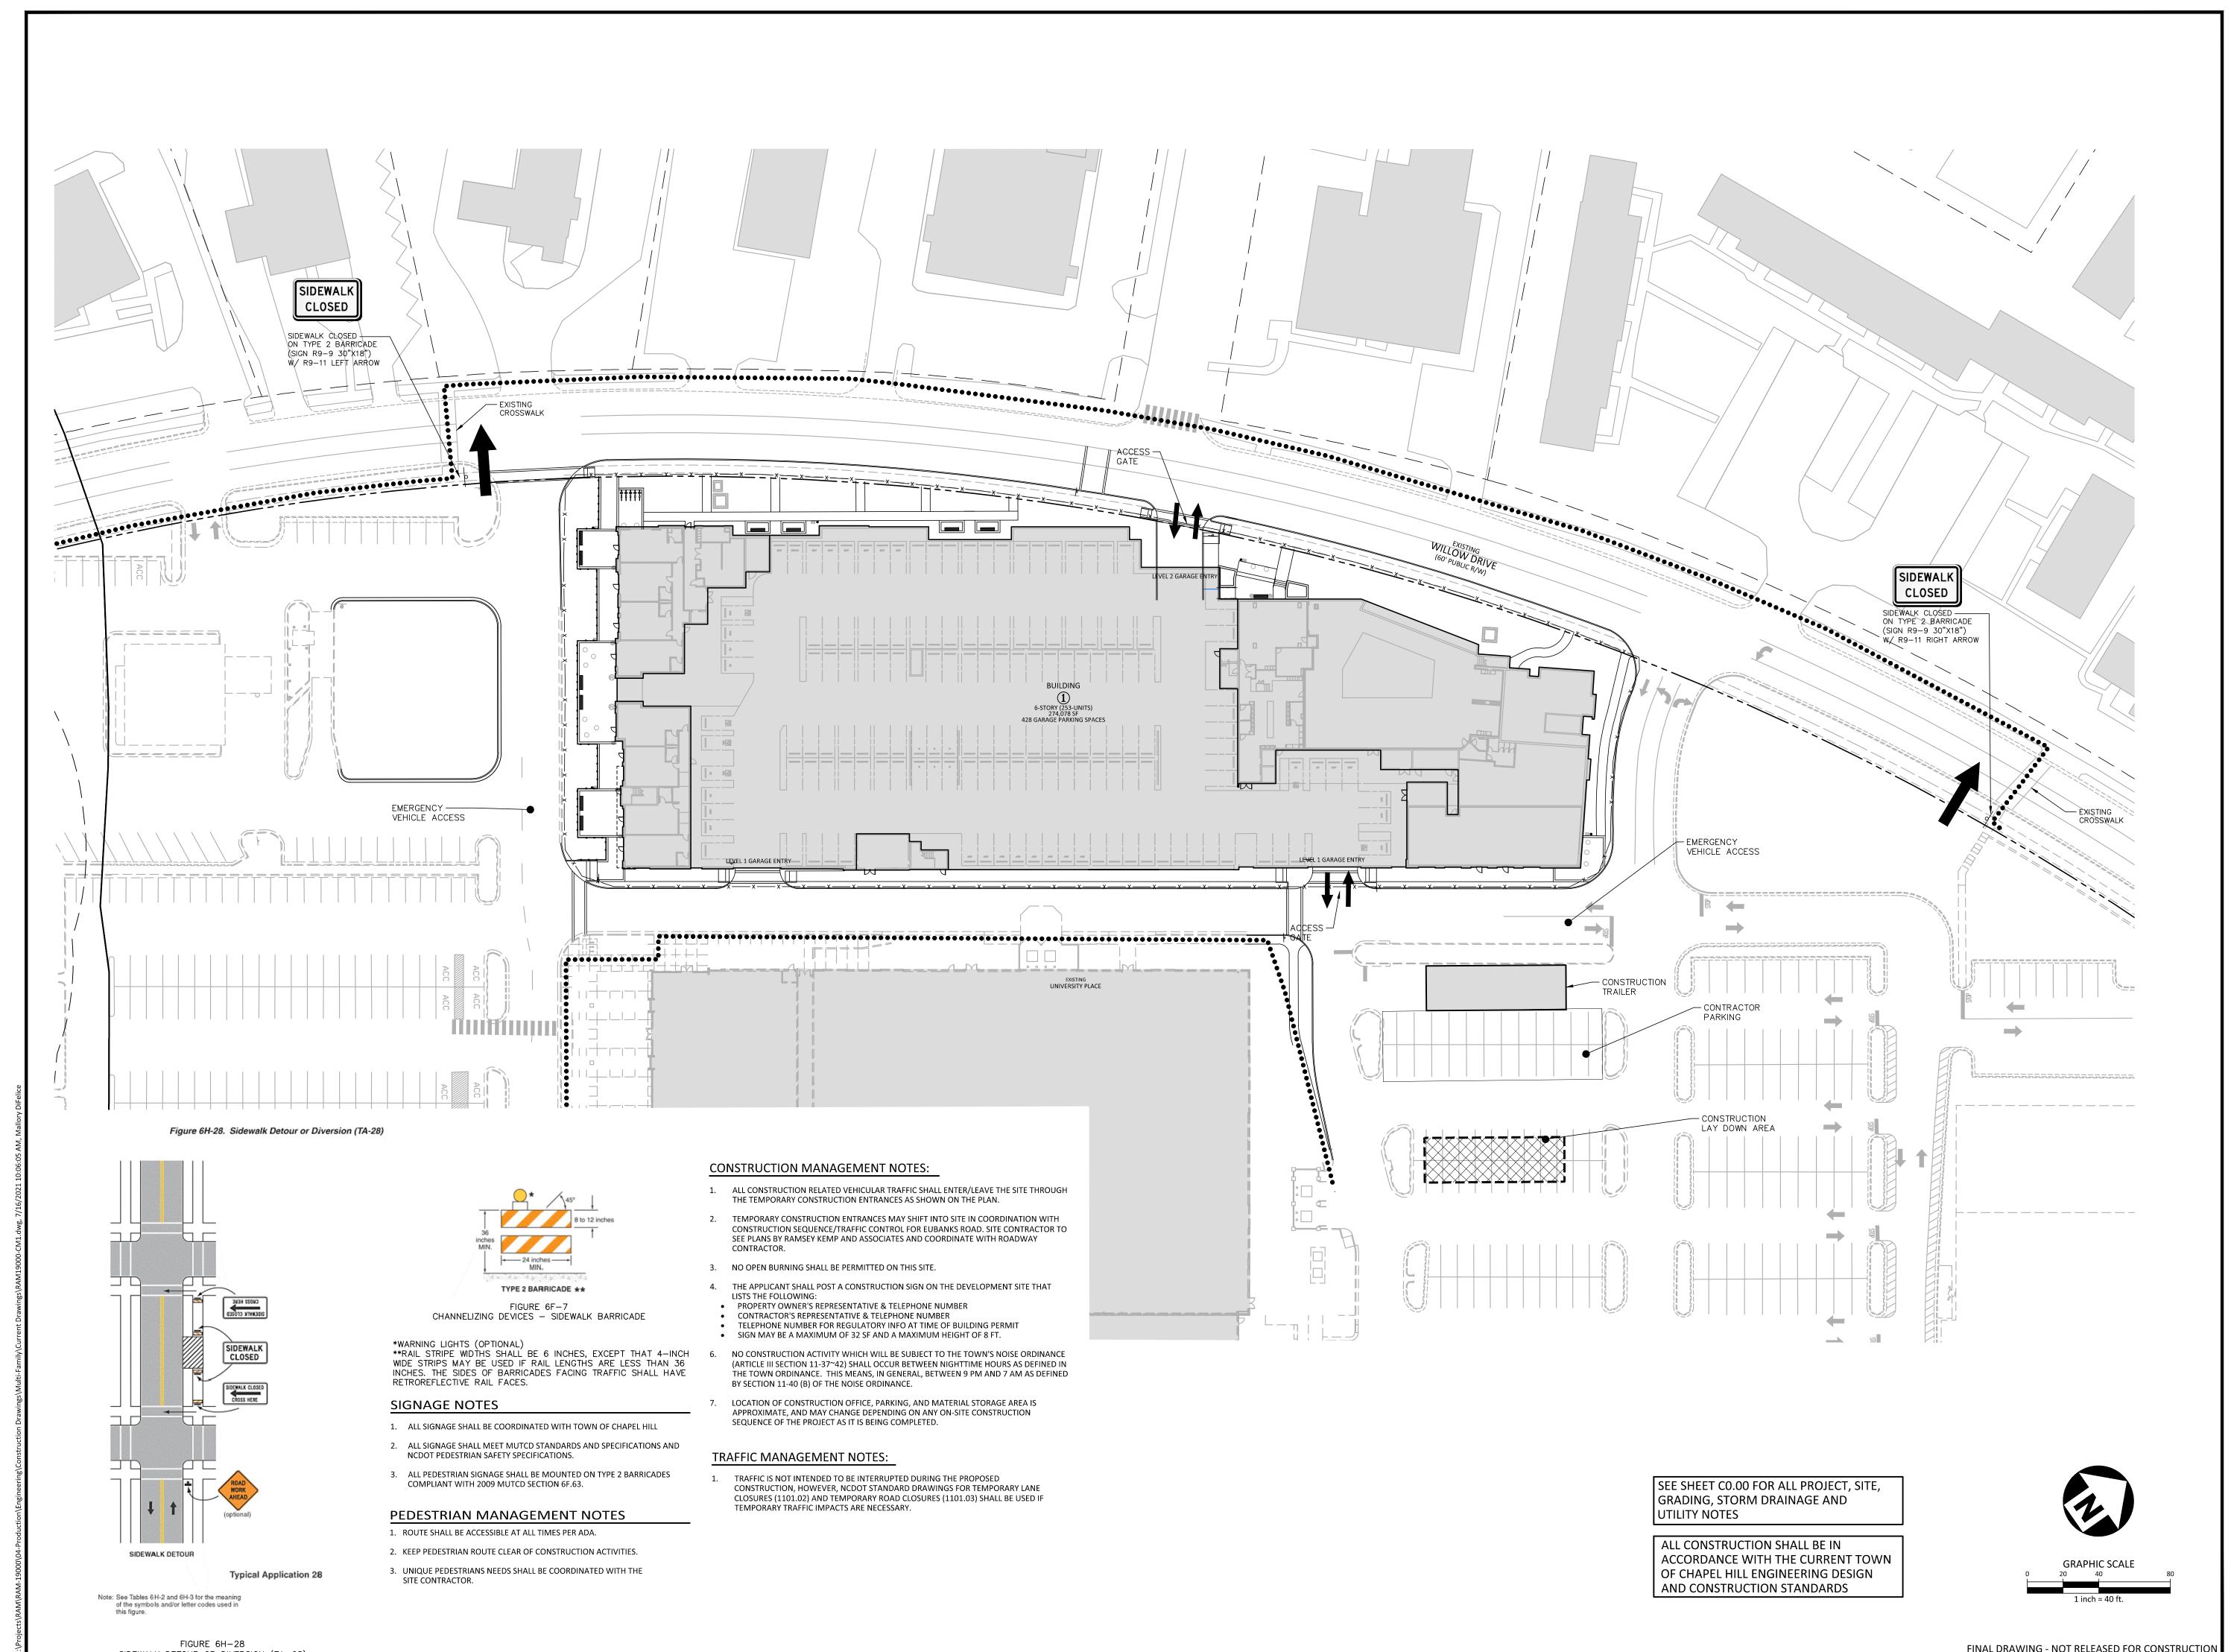
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DATE

**EROSION CONTROL** 

07. 16. 2021



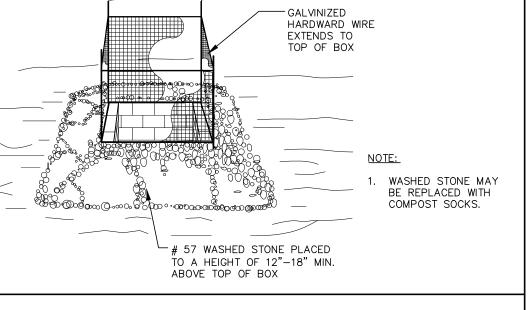

**MCADAMS** 

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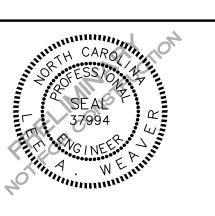
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## UNIVERSITY PLACE MULTI-FAMILY NING COMPLIANCE PERMIT



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PLAN INFORMATION

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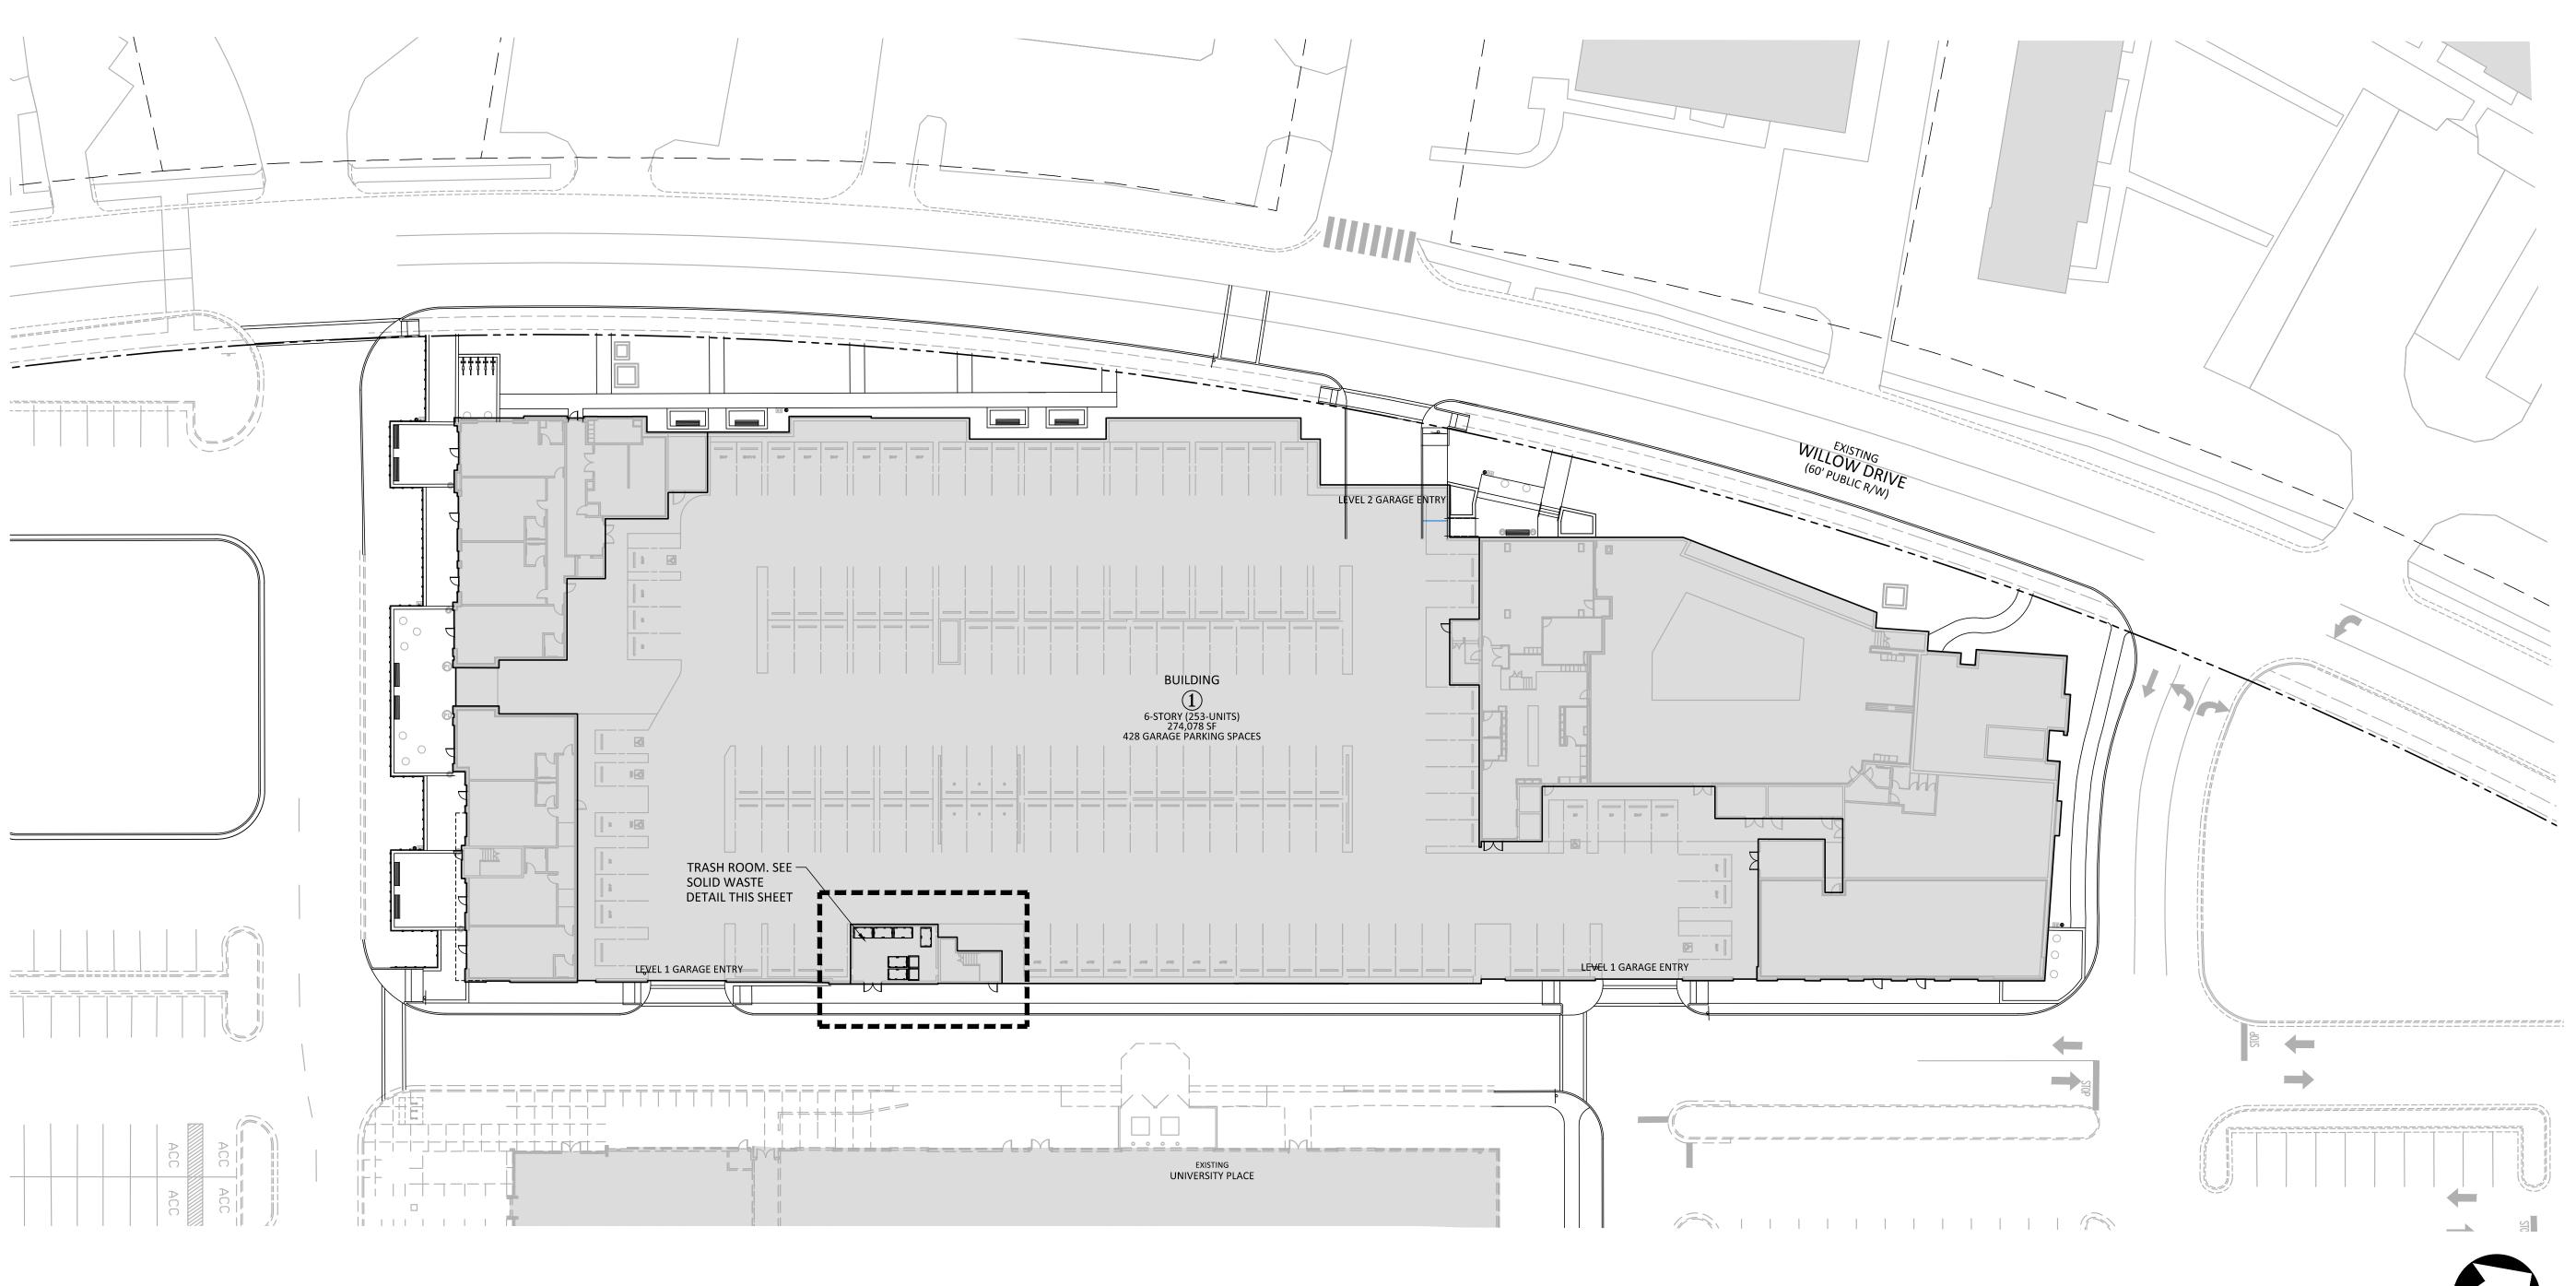
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CONSTRUCTION, PEDESTRIAN & TRAFFIC MANAGEMENT PLAN

C7.00





### SOLID WASTE NOTES:

- 1. ALL EXISTING STRUCTURES 500 SQUARE FEET AND LARGER IN SIZE SHALL BE ASSESSED PRIOR TO DEMOLITION TO ENSURE COMPLIANCE WITH THE COUNTY'S REGULATED RECYCLABLE MATERIALS ORDINANCE (RRMO) AND TO ASSESS THE POTENTIAL FOR DE-CONSTRUCTION AND/OR THE RE-USE OF SALVAGEABLE MATERIALS.
- 2. BY ORANGE COUNTY ORDINANCE, CLEAN WOOD WASTE, SCRAP METAL, AND CORRUGATED CARDBOARD PRESENT IN CONSTRUCTION OR DEMOLITION WASTE MUST BE RECYCLED.
- 3. BY ORANGE COUNTY ORDINANCE, ALL HAULERS OF MIXED CONSTRUCTION AND DEMOLITION WASTE THAT INCLUDES ANY REGULATED RECYCLABLE MATERIALS SHALL BE LICENSED BY
- 4. PRIOR TO ANY DEMOLITION OR CONSTRUCTION ACTIVITY ON THE SITE THE APPLICANT SHALL HOLD A PRE-DEMOLITION/PRE-CONSTRUCTION CONFERENCE WITH THE SOLID WASTE STAFF (919-968-2788). THIS MAY BE THE SAME PRE-CONSTRUCTION MEETING HELD WITH OTHER DEVELOPMENT/ENFORCEMENT OFFICIALS.
- 5. THE PRESENCE OF ANY ASBESTOS CONTAINING MATERIALS ('ACM') AND/OR OTHER HAZARDOUS MATERIALS IN CONSTRUCTION AND DEMOLITION WASTE SHALL BE HANDLED IN ACCORDANCE

  18. ELECTION TO FOREGO MIXED PUBLIC RECYCLING WITH ANY AND ALL LOCAL, STATE, AND FEDERAL REGULATIONS AND GUIDELINES.
- 6. IF ANY VEHICLES ARE PARKED IN THE REFUSE OR RECYCLABLES COLLECTION VEHICLE ACCESS AREA, THE CONTAINERS WILL NOT RECEIVE SERVICE UNTIL THE NEXT SCHEDULED COLLECTION
- 7. MIXED RECYCLING WILL BE IN ROLL OUT CARTS TO BE COLLECTED BY PRIVATE WASTE COLLECTION CONTRACTOR. OWNER ACKNOWLEDGES THAT RIGHTS ARE BEING WAIVED FOR PUBLIC COLLECTION OF MIXED RECYCLABLES BY ORANGE COUNTY AND THAT PAYMENT OF ANNUAL FEE WITH REAL ESTATE TAXES WILL STILL BE REQUIRED.
- 8. TRASH AND MIXED RECYCLABLES WILL BE IN SEPARATE CONTAINERS AND COLLECTED BY A PRIVATE WASTE COLLECTION CONTRACTOR.
- 9. ALL CONSTRUCTION WASTE MATERIALS CONTAINING REGULATED RECYCLABLE MATERIALS (SEE NOTE 2 ABOVE) SHALL BE RECYCLED PURSUANT TO THE ORANGE COUNTY REGULATED RECYCLABLE MATERIALS ORDINANCE (RRMO). CONTRACTORS SHALL RETAIN PICKUP SLIPS TO RECORD/VALIDATE RECYCLING AS MAY BE REQUIRED FOR ENVIRONMENTAL CREDITS.
- 10. THE TRASH AND RECYCLE COLLECTION AREA INCLUDES A 2-YD MINI-COMPACTOR WITH 2-YD BINS FOR BOTH TRASH AND RECYCLING.
- 11. ALL LEVELS OF RESIDENTIAL SPACE WILL INCLUDE A TRASH CHUTE/COLLECTION AND RECYCLING STAGING AREA. THE CHUTE WILL DIRECT TRASH TO THE COMPACTORS ON THE LEVEL 0 PARKING.

- 12. THE OWNER, OR THEIR DESIGNEE, SHALL BE RESPONSIBLE FOR MAINTAINING A FIRE WATCH DURING CONSTRUCTION AND DEMOLITION WHERE MATERIALS SUBJECT TO SPONTANEOUS COMBUSTION OR OTHER HAZARDOUS CONSTRUCTION OR DEMOLITION IS OCCURRING.
- 13. ALL CONSTRUCTION AND DEMOLITION SHALL BE CONDUCTED IN COMPLIANCE WITH THE CURRENT EDITION OF CHAPTER 14 OF THE NC FPC.
- 14. APPLICANT ELECTS TO PROVIDE PRIVATE MIXED RECYCLING SERVICE TO THIS PROPERTY IN LIEU OF BUILDING A MIXED RECYCLING CENTER CONSTRUCTED TO OCSW SPECIFICATIONS.
- 15. THE SITE WILL NOT RECEIVE PUBLIC MIXED RECYCLING COLLECTION NOW OR IN THE FUTURE UNLESS SUCH A MIXED RECYCLING CENTER IS CONSTRUCTED OR CONTINGENCY FOR SUCH A CENTER IS INCLUDED ON DEVELOPMENT PLANS.
- 16. APPLICANT MUST REQUIRE AT LEAST THE SAME LEVEL OF CURRENT AND FUTURE MIXED RECYCLING SERVICE TO ITS RESIDENTS AS THAT PROVIDED BY OCSW.
- 17. COUNTY FEES FOR MIXED RECYCLING COLLECTION AND WASTE MANAGEMENT ASSOCIATED
- WITH THIS PROPERTY WILL NOT BE WAIVED.
- APPLICANT ELECTS TO PROVIDE PRIVATE MIXED RECYCLING SERVICE TO THIS PROPERTY IN LIEU OF BUILDING A MIXED RECYCLING CENTER CONSTRUCTED TO OCSW SPECIFICATIONS.
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- APPLICANT MUST REQUIRE AT LEAST THE SAME LEVEL OF CURRENT AND FUTURE MIXED RECYCLING SERVICE TO ITS RESIDENTS AS THAT PROVIDED BY OCSW.
- COUNTY FEES FOR MIXED RECYCLING COLLECTION AND WASTE MANAGEMENT ASSOCIATED WITH THIS PROJECT WILL NOT BE WAIVED.

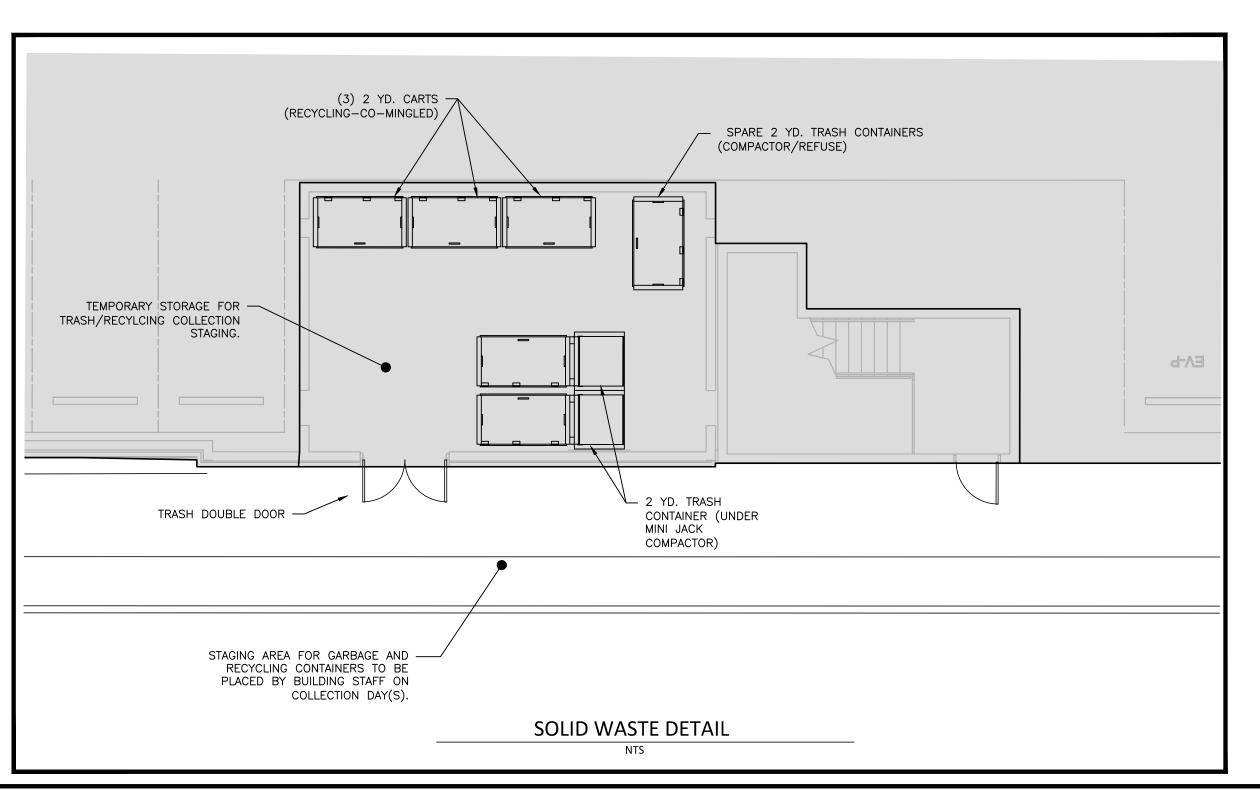

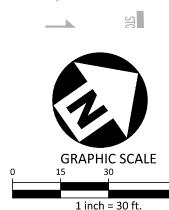

**REVISIONS** NO. DATE

ALL CONSTRUCTION SHALL BE IN ACCORDANCE WITH THE CURRENT TOWN OF CHAPEL HILL ENGINEERING DESIGN AND CONSTRUCTION STANDARDS

FINAL DRAWING - NOT RELEASED FOR CONSTRUCTION

SEE SHEET CO.00 FOR ALL PROJECT, SITE,

GRADING, STORM DRAINAGE AND

UTILITY NOTES

PLAN INFORMATION

PROJECT NO. 2021110354 FILENAME RAM19000-FA1 CHECKED BY DRAWN BY

DATE 07. 16. 2021 SHEET

SCALE

**SOLID WASTE PLAN** 

1"=40'

The John R. McAdams Company, Inc. 2905 Meridian Parkway Durham, NC 27713

phone 919. 361. 5000

fax 919. 361. 2269 license number: C-0293


www.mcadamsco.com

**CLIENT** 


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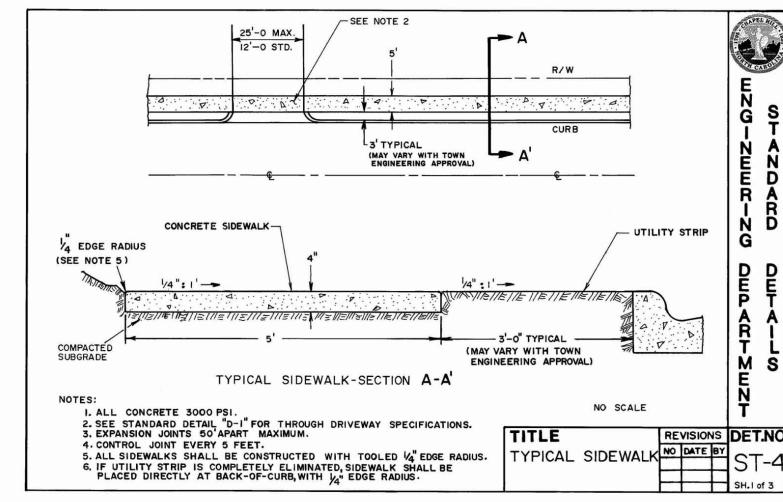
127 W. WORTHINGTON AVE, SUITE 290 CHARLOTTE, NORTH CAROLINA 28203




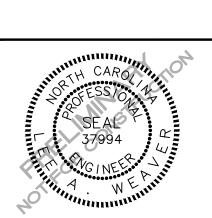



DECRIPTION



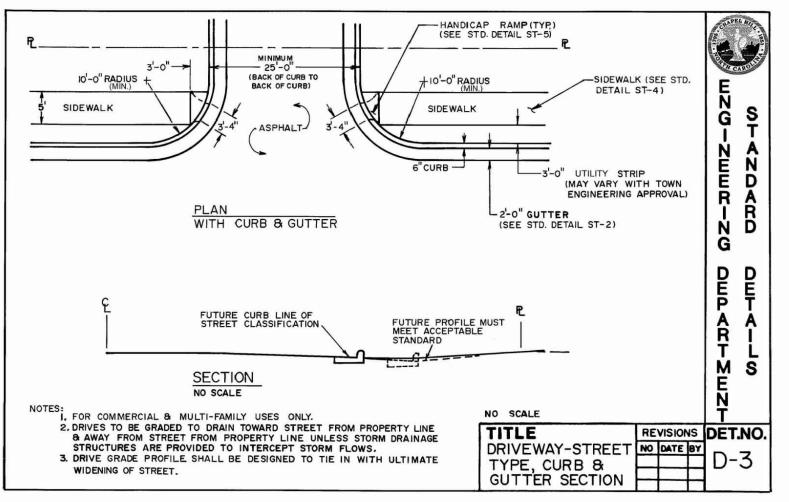

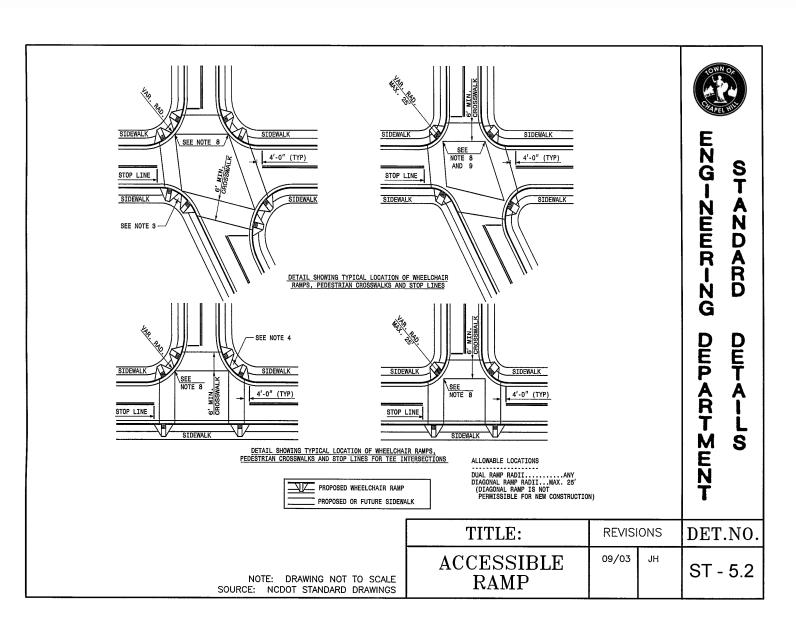

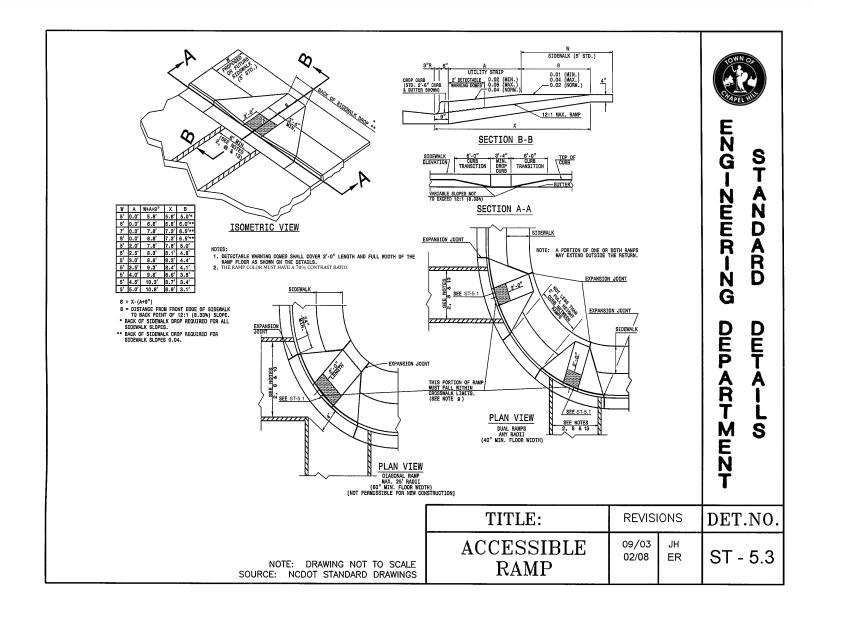

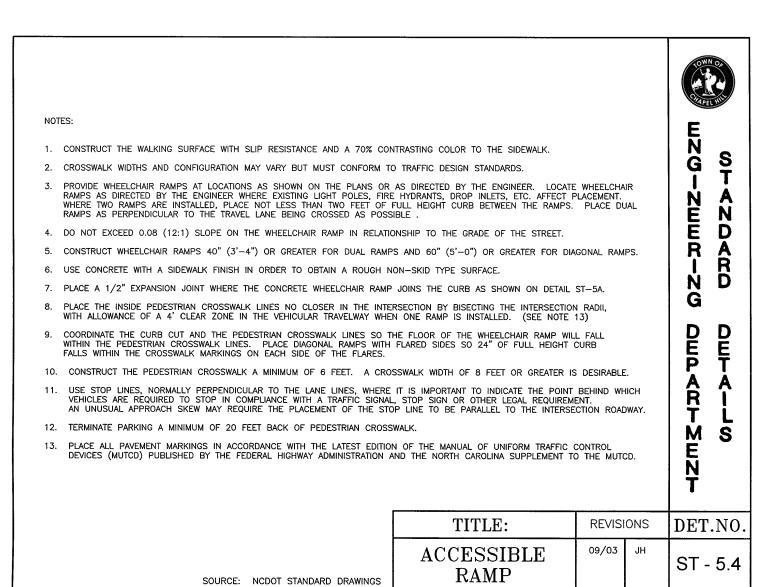



MCADAMS
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phone 919. 361. 5000 fax 919. 361. 2269

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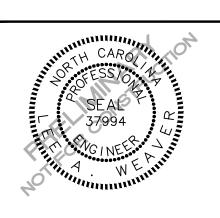
license number: C-0293

CLIENT

RAM REALTY 127 W. WORTHINGTON AVE, SUITE 290 CHARLOTTE, NORTH CAROLINA 28203



## ING COMPLIANCE PERMIT



## REVISIONS

NO. DATE DECRIPTION

### PLAN INFORMATION

PROJECT NO. 2021110354

FILENAME RAM19000-D1

CHECKED BY LAW

DRAWN BY MRO


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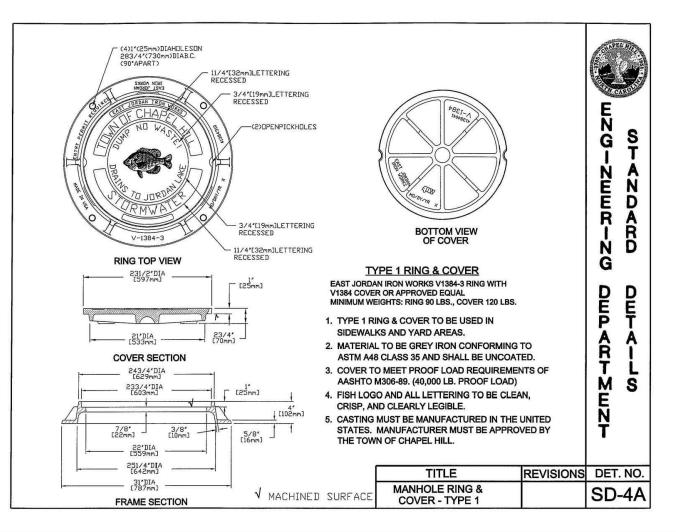
DATE 07. 16. 2021


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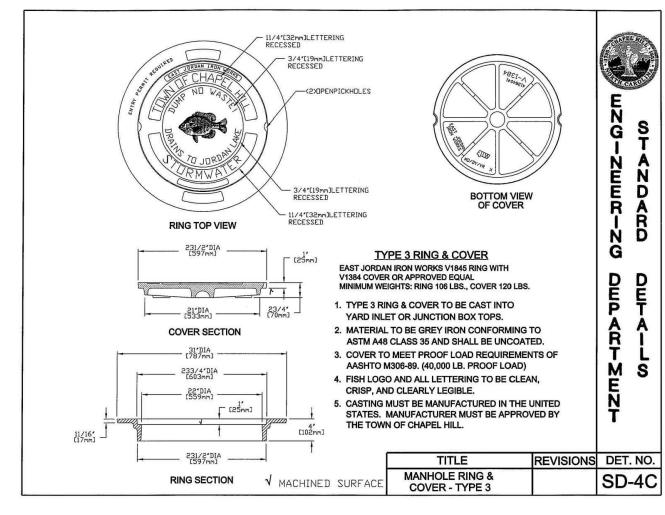
SITE DETAILS


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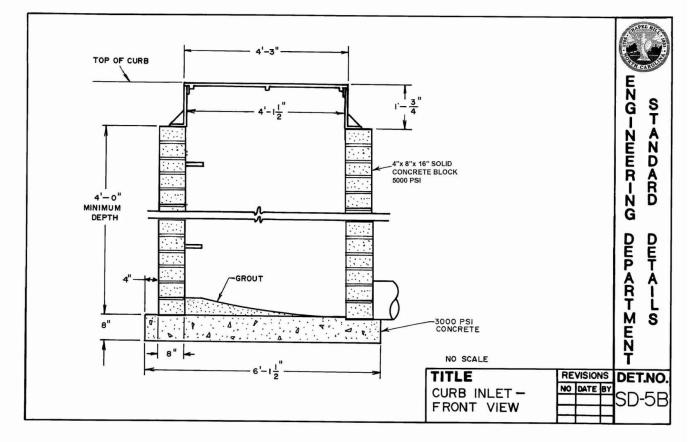








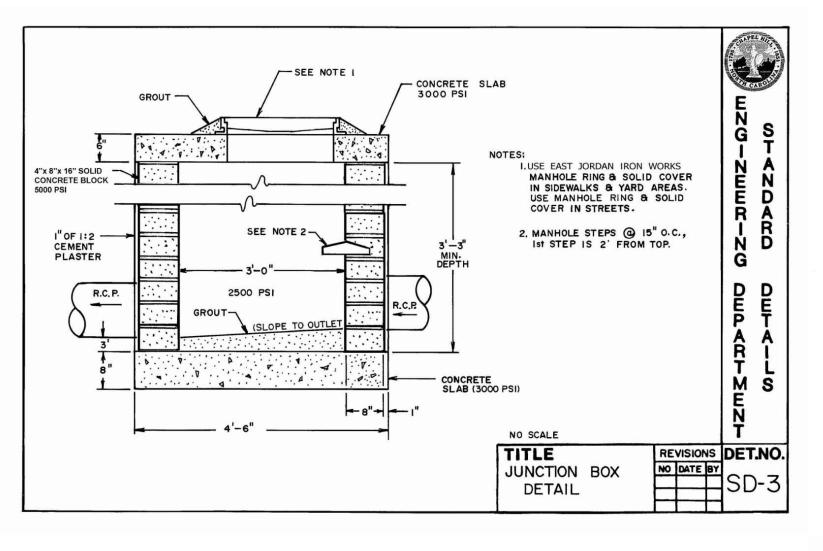


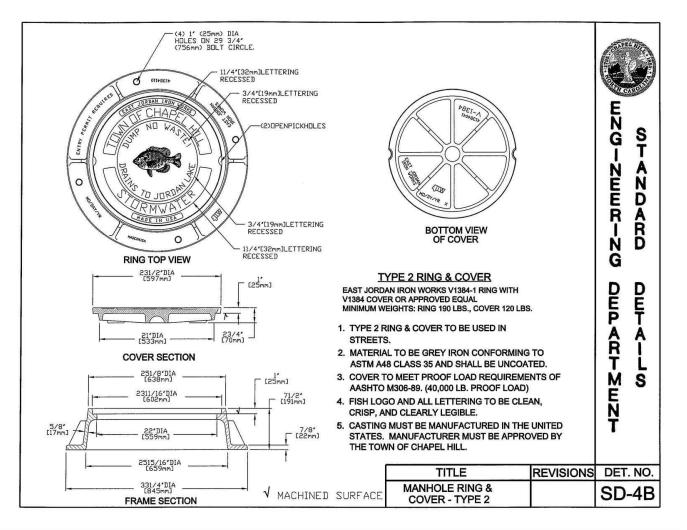

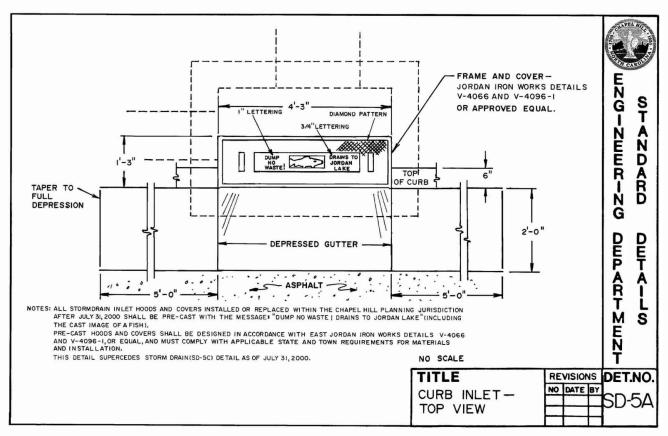

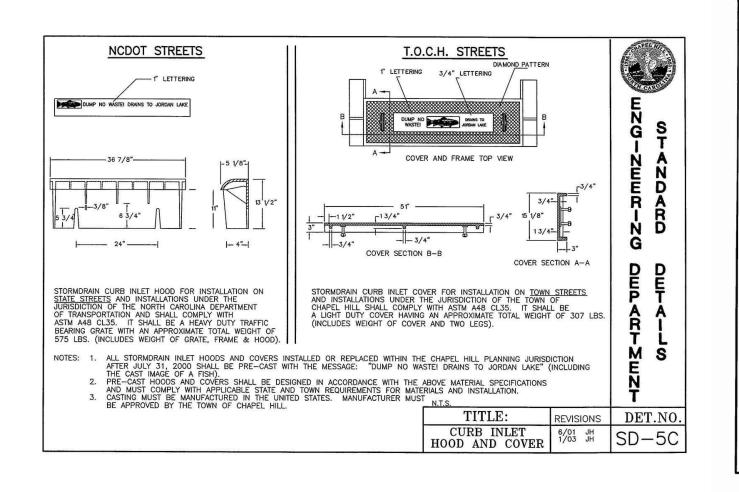

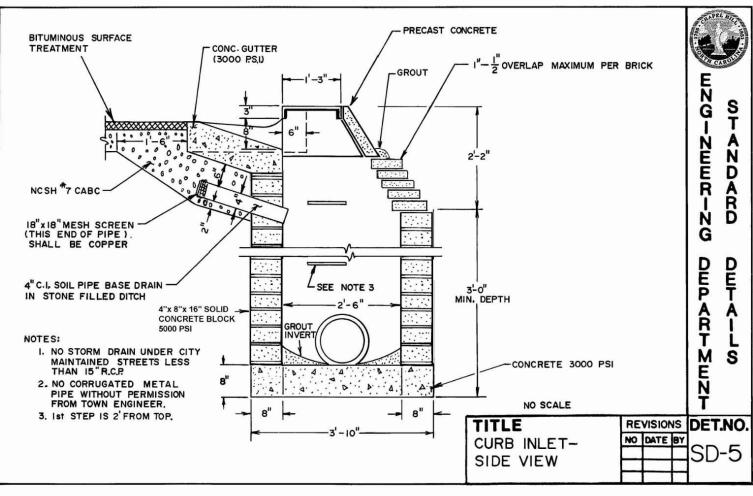

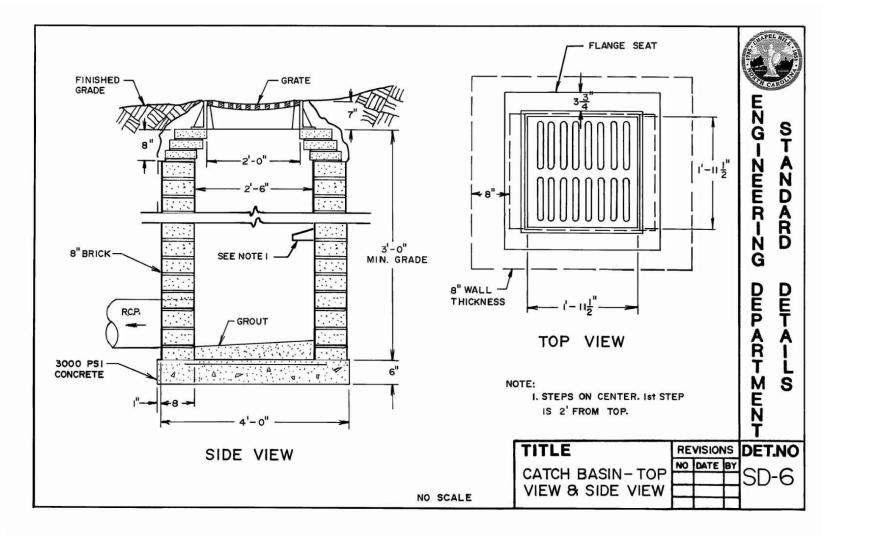



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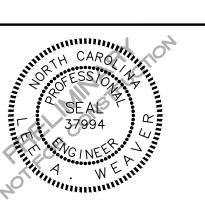
### CLIENT

RAM REALTY

127 W. WORTHINGTON AVE, SUITE 290 CHARLOTTE, NORTH CAROLINA 28203



## ERSITY PLACE ILTI-FAMILY COMPLIANCE PERMIT



### **REVISIONS**

NO. DATE DECR

### PLAN INFORMATION

PROJECT NO. 2021110354

FILENAME RAM19000-D1

CHECKED BY LAW

DRAWN BY MRO


SCALE N/A

DATE 07. 16. 2021

### SHEET

STORM DRAINAGE DETAILS

C8.01

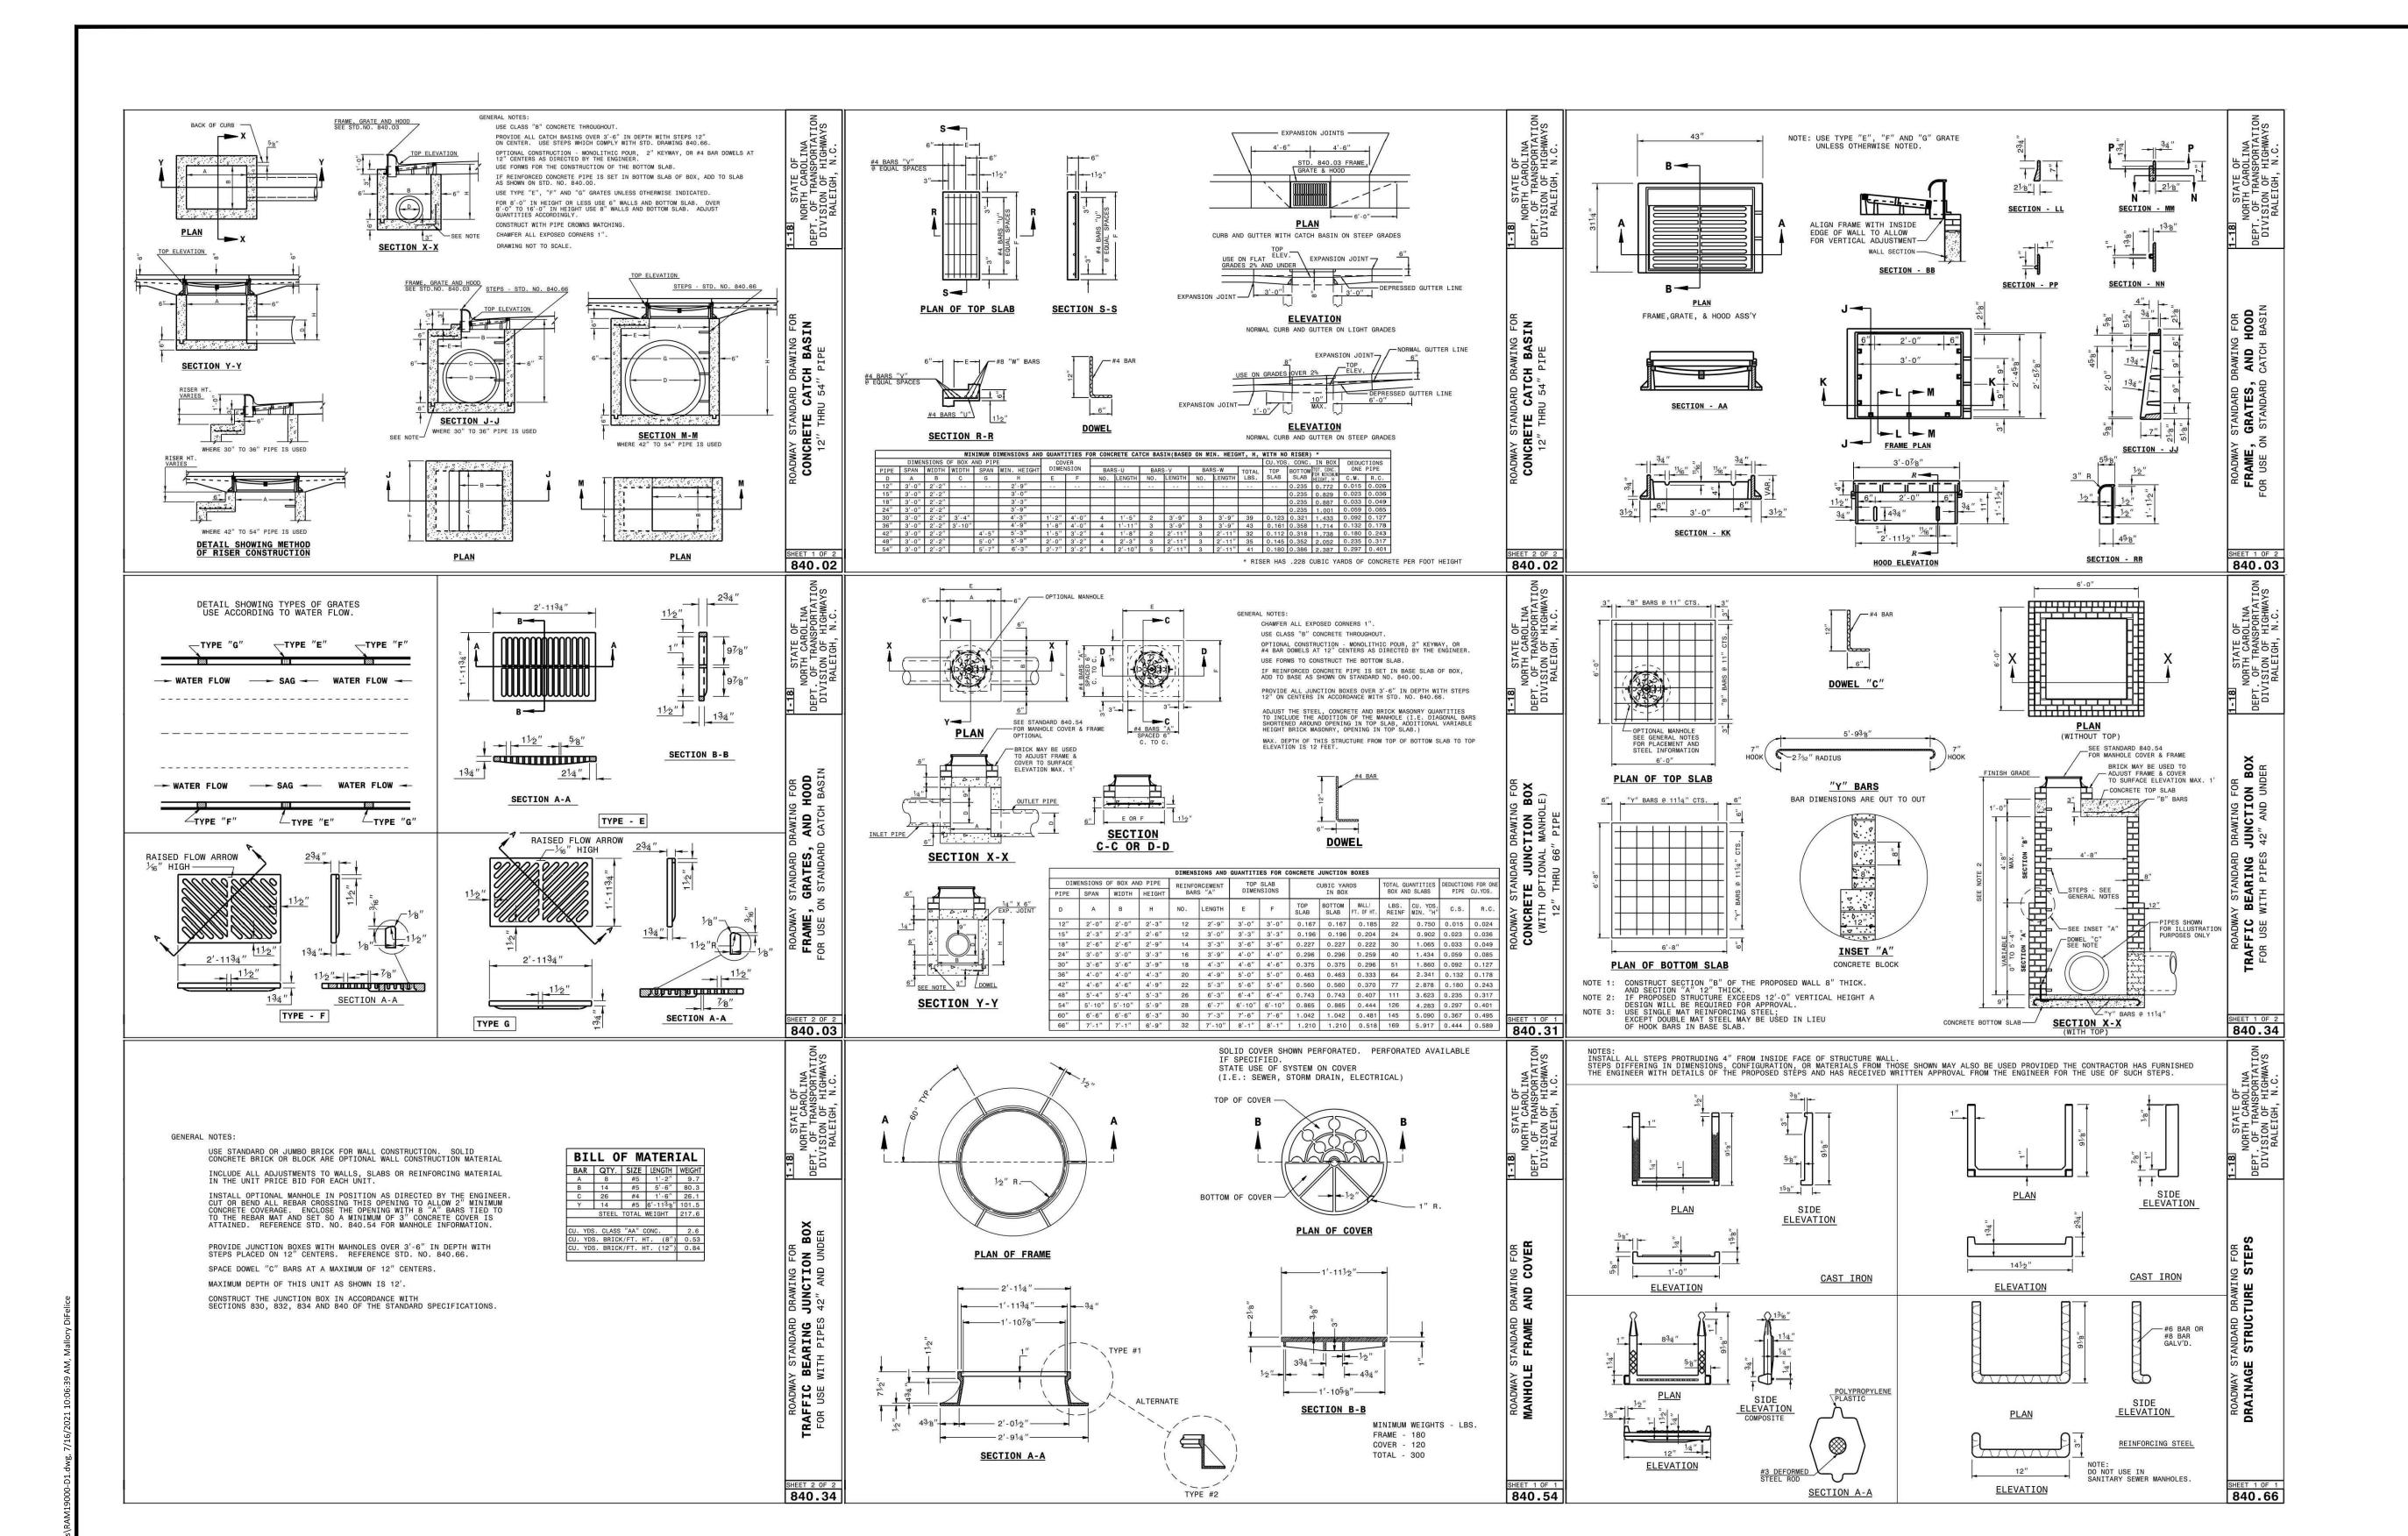



## The John R. McAdams Company, Inc. 2905 Meridian Parkway

phone 919. 361. 5000 fax 919. 361. 2269 license number: C-0293

Durham, NC 27713

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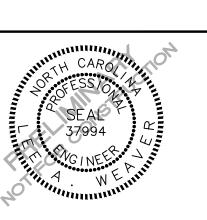
### CLIENT

RAM REALTY

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# UNIVERSITY PLACE MULTI-FAMILY ONING COMPLIANCE PERMIT



### **REVISIONS**

NO. DATE DECRIPTION

### PLAN INFORMATION

PROJECT NO. 2021110354

FILENAME RAM19000-D1

CHECKED BY LAW

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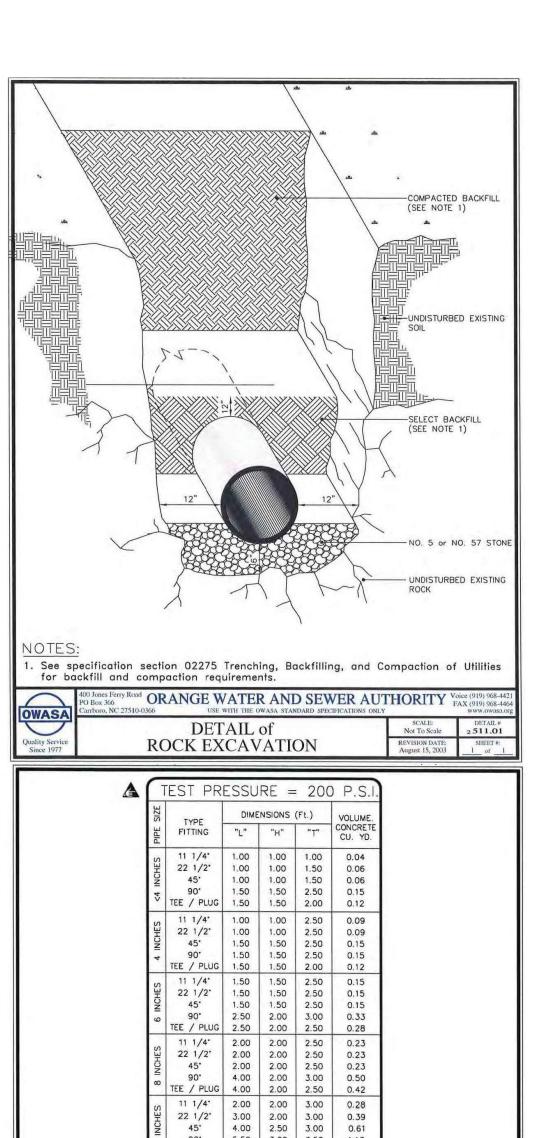
SCALE N/A

DATE 07. 16. 2021

### SHEET

STORM DRAINAGE DETAILS

C8.02



11 1/4" 2.00 2.00 3.00 0.28

TEE / PLUG 7.50 4.00 3.00 1.72

1. If blocking excavation is in lightly compacted fill areas, or in areas where boulders or stumps have been removed, blocking size must be re-sized for the specific location/circumstance by a NC licensed Professional Engineer.

. Neither the weight of the concrete blocking nor friction between concrete blocking and soil was added into blocking sizes computation. Therefore, blocking size is

ORANGE WATER AND SEWER AUTHORITY Voice (919) 9


. Blocking sizes shown in these tables assume the following: a. Blocking is constructed in residual soils as shown in detail


b. Soil bearing pressure = 2000 psf
c. Velocity of flow = 15 fps
This detail not applicable to reducing bends.


conservative.


4.00 2.00 3.00 0.50


5.50 3.00 3.50 1.13 7.50 4.00 3.50 2.01

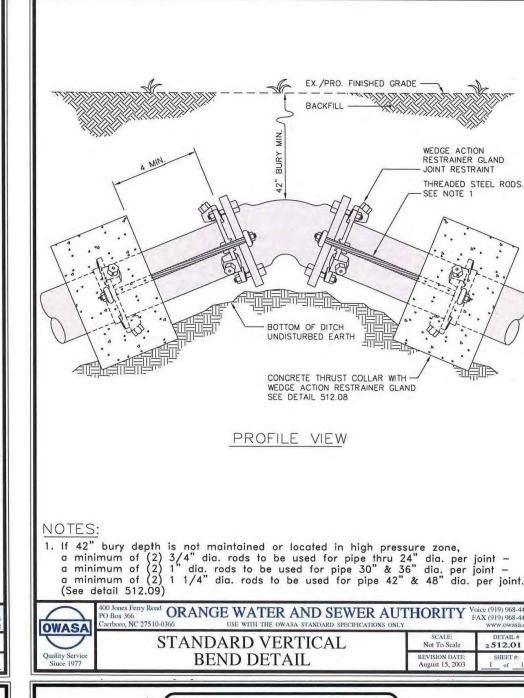


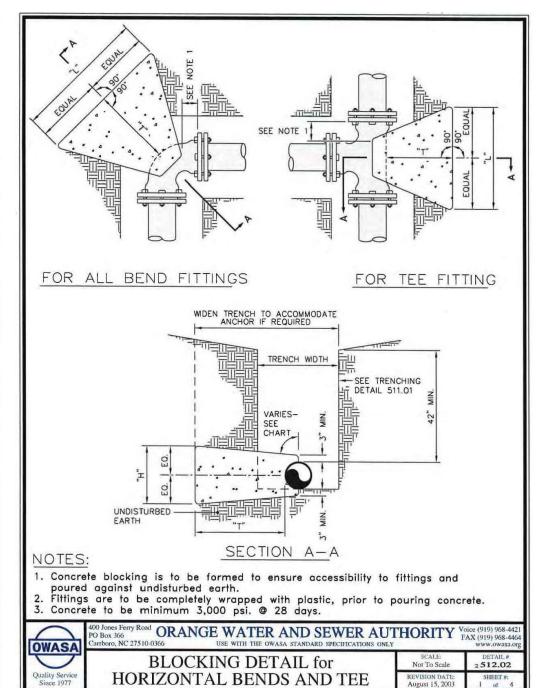


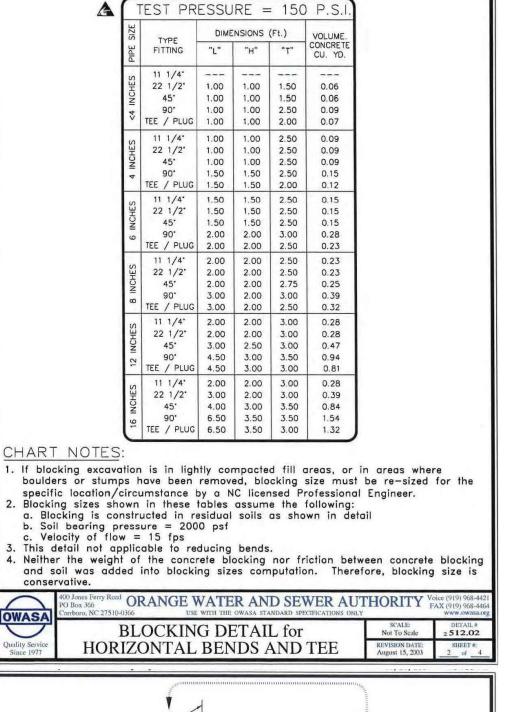


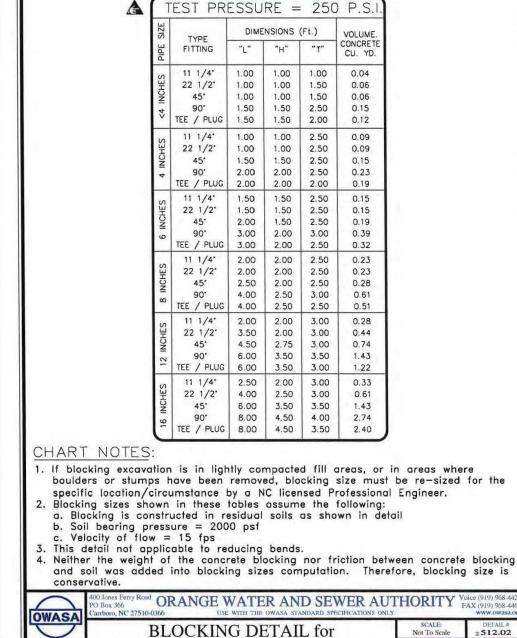

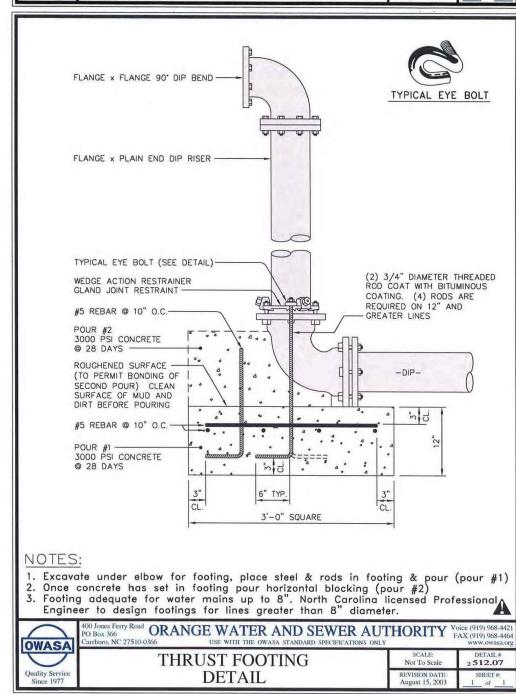


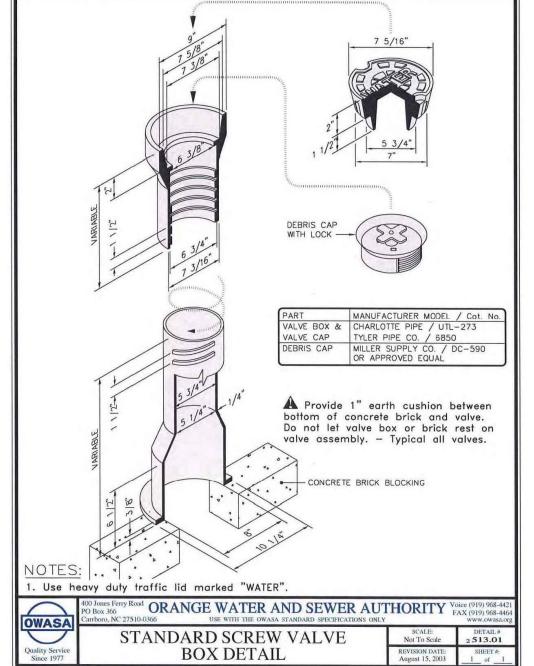

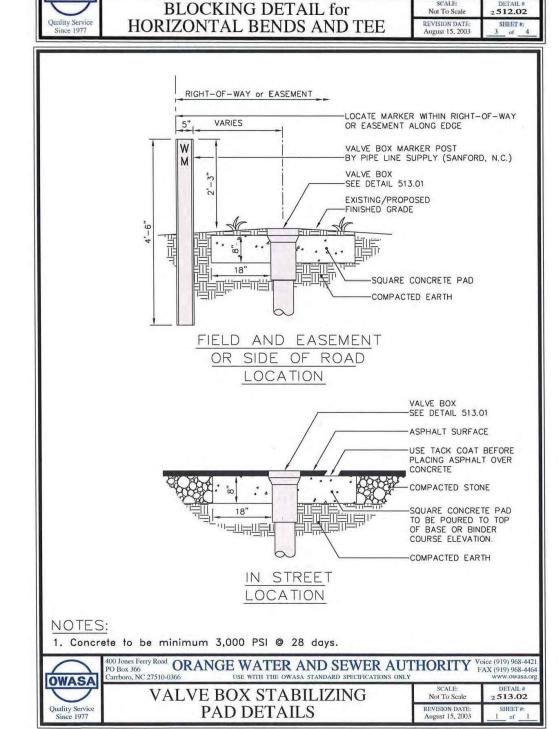


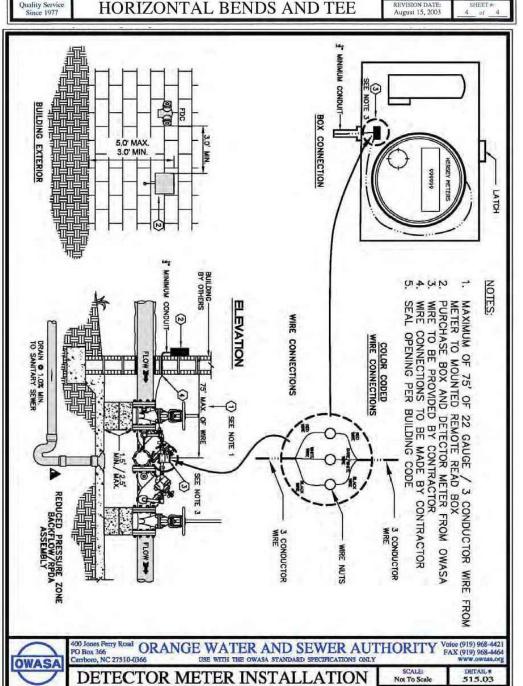

(FIRE SYSTEM)

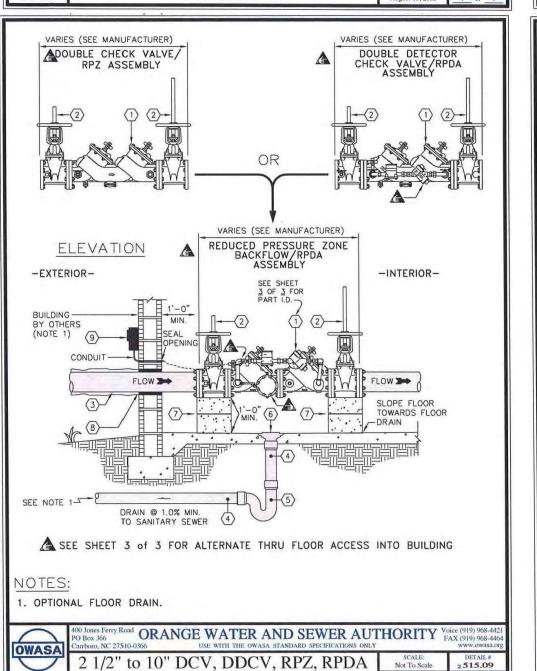

ASSEMBLY (INDOOR)

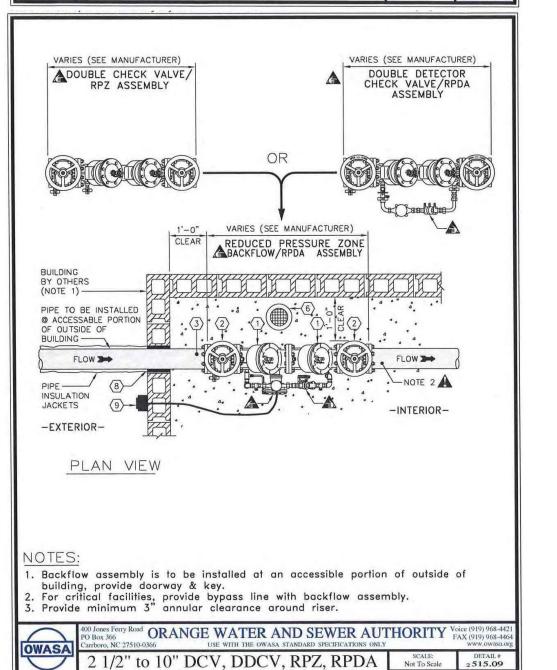

ASSEMBLY (INDOOR)



## MCADAMS

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phone 919. 361. 5000


www.mcadamsco.com

fax 919. 361. 2269 license number: C-0293

## CLIENT

RAM REALTY 127 W. WORTHINGTON AVE, SUITE 290 CHARLOTTE, NORTH CAROLINA 28203



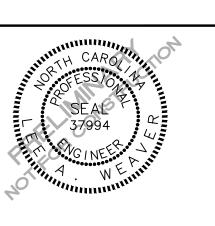

### **REVISIONS**

NO. DATE

### PLAN INFORMATION

PROJECT NO. 2021110354 FILENAME RAM19000-D1 CHECKED BY DRAWN BY SCALE DATE 07. 16. 2021 SHEET

### **OWASA DETAILS**