


DEVELOPMENT AGREEMENT COMPLIANCE PERMIT (DACP) DRAWINGS

FOR

LINK APARTMENTS CALYX GLEN LENNOX - BLOCK 9A - PHASE 2


CHAPEL HILL, NORTH CAROLINA

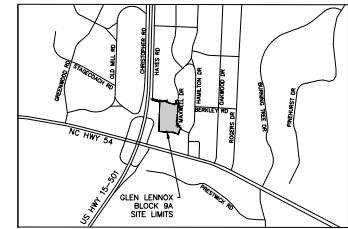

VICINITY MAP
SCALE: 1"=200'

SITE DATA TABLE

PROJECT NAME:	LINK APARTMENTS CALYX (GLEN LENNOX BLOCK 9A)	
PROPERTY PIN NUMBER:	079206124	
PROPERTY LOCATION:	TOWN OF CHAPEL HILL	
CURRENT LAND OWNER:	GLEN LENNOX APARTMENTS, LLC 4601 PARK ROAD, SUITE 400 CHARLOTTE, NC 28209	
PROPERTY ZONING:	R-3 WITH NEIGHBORHOOD CONSERVATION DISTRICT (NO. 80) OVERLAY	
SETBACKS:	LANARK = 15' (FROM BACK OF CURB) MAXWELL = 18' (FROM BACK OF CURB) MINNETER = 30' (FROM PROPERTY LINE)	
EXISTING USE:	RESIDENTIAL	
PROPOSED USE:	RESIDENTIAL	
PROPOSED LOT SIZE (±):	106,772 S.F. (2.43 AC.)	
TOTAL GROSS S.F. (PHASE 2):	APARTMENT BUILDING = 252,240 S.F. PARKING DECK = 176,262 S.F.	
BUILDING ADDRESS:	55 MAXWELL ROAD	
TOTAL PROPOSED APARTMENT UNITS:	304	
EXISTING IMPERVIOUS SURFACE AREA (DEMOLITION):	7,013 S.F. (PHASE 2)	
PROPOSED IMPERVIOUS SURFACE AREA (NET):	79,900 S.F. (PHASE 2) 88,900 S.F. (TOTAL PHASE 1 & 2) *INCLUDES IMPERVIOUS ALLOWANCE	
PROPOSED IMPERVIOUS SURFACE AREA (OFFSET):	3,948 S.F. (PHASE 2)	
TOTAL IMPERVIOUS SURFACE AREA (INCREASE):	87,235 S.F. (PHASE 2) 18,280 S.F. (TOTAL PHASE 1 & 2)	
VEHICULAR PARKING SUMMARY:	REQUIRED: 1,257 DU = 142 V 300 DU = 378 SPACES	PROVIDED: 518 SPACES (PARKING SECT) = 15 SPACES
ACCESSIBLE PARKING SUMMARY:	REQUIRED: 15 SPACES	PROVIDED: 15 SPACES (INCLUDES 2 VAN)
BIOCYCLE PARKING SUMMARY:	REQUIRED: 1/4 DU = 36 SPACES CLASS 1 = 108 CLASS 2 = 144	PROVIDED: CYCLE CENTER CLASS 1 = 122 PARKING SECT CLASS 1 = 108 OUTSIDE PARKING CLASS 2 = 14

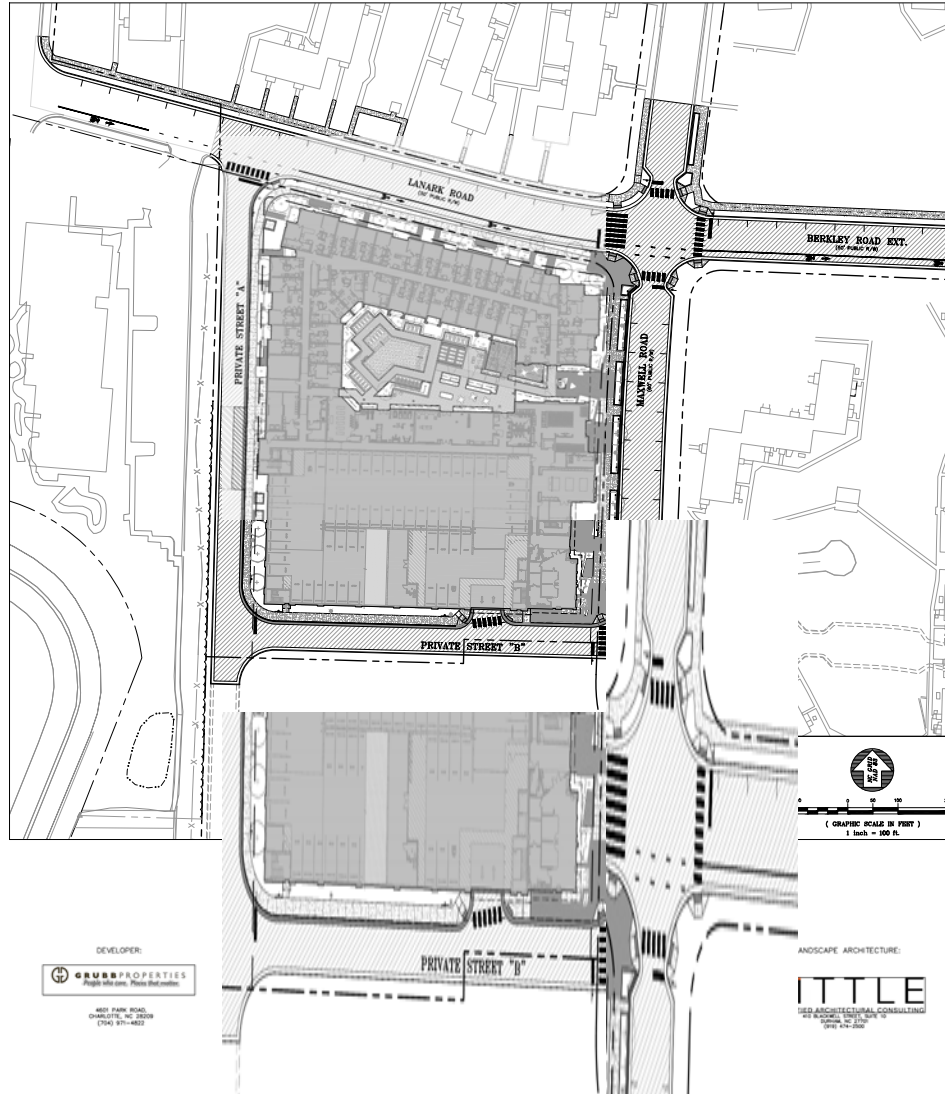

DEVELOPER:
GRUBBPROPERTIES
1400 PARK ROAD
CHARLOTTE, NC 28203
(704) 971-4622

LANDSCAPE ARCHITECTURE:
ITTLE
1500 ARCHITECTURAL CONSULTING
1000 W. GOLF COURSE RD.
SUITE 100
CHAPEL HILL, NC 27514
(919) 997-1100

DRAWING LIST

SHEET	DRAWING TITLE	LATEST ISSUE DATE
G0001	COVER SHEET - PHASE 2	18 JAN 22
C0001	AREA MAP	18 JAN 22
C0101	EXISTING CONDITIONS PLAN - PHASE 2	18 JAN 22
C0102	GLEN LENNOX TREE SURVEY OVERVIEW	18 JAN 22
C0103	ENLARGED GLEN LENNOX TREE SURVEY - NORTH	18 JAN 22
C0104	ENLARGED GLEN LENNOX TREE SURVEY - SOUTH	18 JAN 22
C0105	OVERALL GLEN LENNOX TREE LIST	18 JAN 22
C0201	DEMOLITION PLAN - PHASE 2	18 JAN 22
C1001	SITE PLAN - PHASE 2	18 JAN 22
C1002	STAKING PLAN	18 JAN 22
C1003	WASTE MANAGEMENT PLAN	18 JAN 22
C1004	OPEN SPACE PLAN	18 JAN 22
C1005	BLOCK 9A IMPERVIOUS COMPLIANCE PLAN	18 JAN 22
C1006	PUBLIC STREET NETWORK EXHIBIT	18 JAN 22
C1007	OVERALL GLEN LENNOX TREE CANOPY COVERAGE	18 JAN 22
C1008	FIRE ACCESS PLAN	18 JAN 22
C1101	UTILITY PLAN - PHASE 2	18 JAN 22
C1201	GRADING & DRAINAGE PLAN - PHASE 2	18 JAN 22
C1202	GRADING ENLARGEMENTS - PHASE 2	18 JAN 22
C1301	EROSION CONTROL & CONSTRUCTION MANAGEMENT PLAN - PHASE 2	18 JAN 22
C1302	NOG01 REQUIREMENTS - PHASE 2	18 JAN 22
C8001	SITE DETAILS - PHASE 2	18 JAN 22
C8101	UTILITY DETAILS - PHASE 2	18 JAN 22
C8102	UTILITY DETAILS - PHASE 2	18 JAN 22
C8201	STORM DRAINAGE DETAILS - PHASE 2	18 JAN 22
C8301	EROSION CONTROL DETAILS - PHASE 2	18 JAN 22
L-1.00	REQUIRED PARKS PLAN	18 JAN 22
L-1.01	LAYOUT PLAN	18 JAN 22
L-1.02	MATERIALS PLAN	18 JAN 22
L-1.03	AMENITY COURTYARD LAYOUT AND MATERIALS PLAN	18 JAN 22
L-1.04	DOG PARK LAYOUT AND MATERIALS PLAN	18 JAN 22
L-2.00	LANDSCAPE PLAN OVERALL	18 JAN 22
L-2.01	LANDSCAPE PLAN STREETSCAPE	18 JAN 22
L-2.02	LANDSCAPE PLAN COURTYARD	18 JAN 22
L-2.03	IRRIGATION PLAN	18 JAN 22
L-3.00	SITE DETAILS	18 JAN 22
L-3.01	SITE DETAILS	18 JAN 22
L-3.02	SITE DETAILS - OMIT	18 JAN 22
L-3.03	SITE DETAILS	18 JAN 22
L-3.04	SITE DETAILS	18 JAN 22
L-4.00	LANDSCAPE DETAILS	18 JAN 22
L-5.00	LIGHTING PLAN	18 JAN 22
L-5.01	LIGHTING DETAILS	18 JAN 22
C-A1.01	FLOOR PLAN - LEVEL 1	20 JUL 21
C-A1.02	FLOOR PLAN - LEVEL 2	09 APR 21
C-A1.03	FLOOR PLAN - LEVEL 3	09 APR 21
C-A1.04	FLOOR PLAN - LEVEL 4	09 APR 21
C-A1.05	FLOOR PLAN - LEVEL 5	09 APR 21
C-A1.06	FLOOR PLAN - LEVEL 6	09 APR 21
C-A1.07	FLOOR PLAN - LEVEL 7	09 APR 21
C-A1.08	OVERALL ROOF PLAN	09 APR 21
C-A4.01	BUILDING ELEVATIONS	09 APR 21
C-A4.02	BUILDING ELEVATIONS	09 APR 21
C-A5.01	BUILDING SECTIONS	09 APR 21
C-A10.01	DACP DIAGRAMS	09 APR 21
ES.0	COURTYARD LIGHTING PHOTOMETRICS	20 MAR 21
-	DUKE ENERGY LIGHTING PLAN	16 FEB 21

DACP Modification
56 pages
2/10/2022
Anya Grahn, Planning
Department

BALLENTINE ASSOCIATES, P.A.
228 PROVENCE ROAD, CHAPEL HILL, N.C. 27514
(919) 997-1100

CHAPEL HILL
PLANNING DEPARTMENT


**LINK APARTMENTS CALYX
GLEN LENNOX - BLOCK 9A**
CHAPEL HILL, NC

DACP DRAWINGS

JOB #: 107033.91
DATE: 12 FEB 21
SCALE: AS NOTED
DRAWN BY: D.M.S.
REVIEWED BY: C.L.J.

SHEET
G0001

NOTES
 1. TREES SHOWN ARE BASED ON A TREE SURVEY UPDATE PREPARED BY BALLENTINE ASSOCIATES, DATED SEPTEMBER 20, 2018.

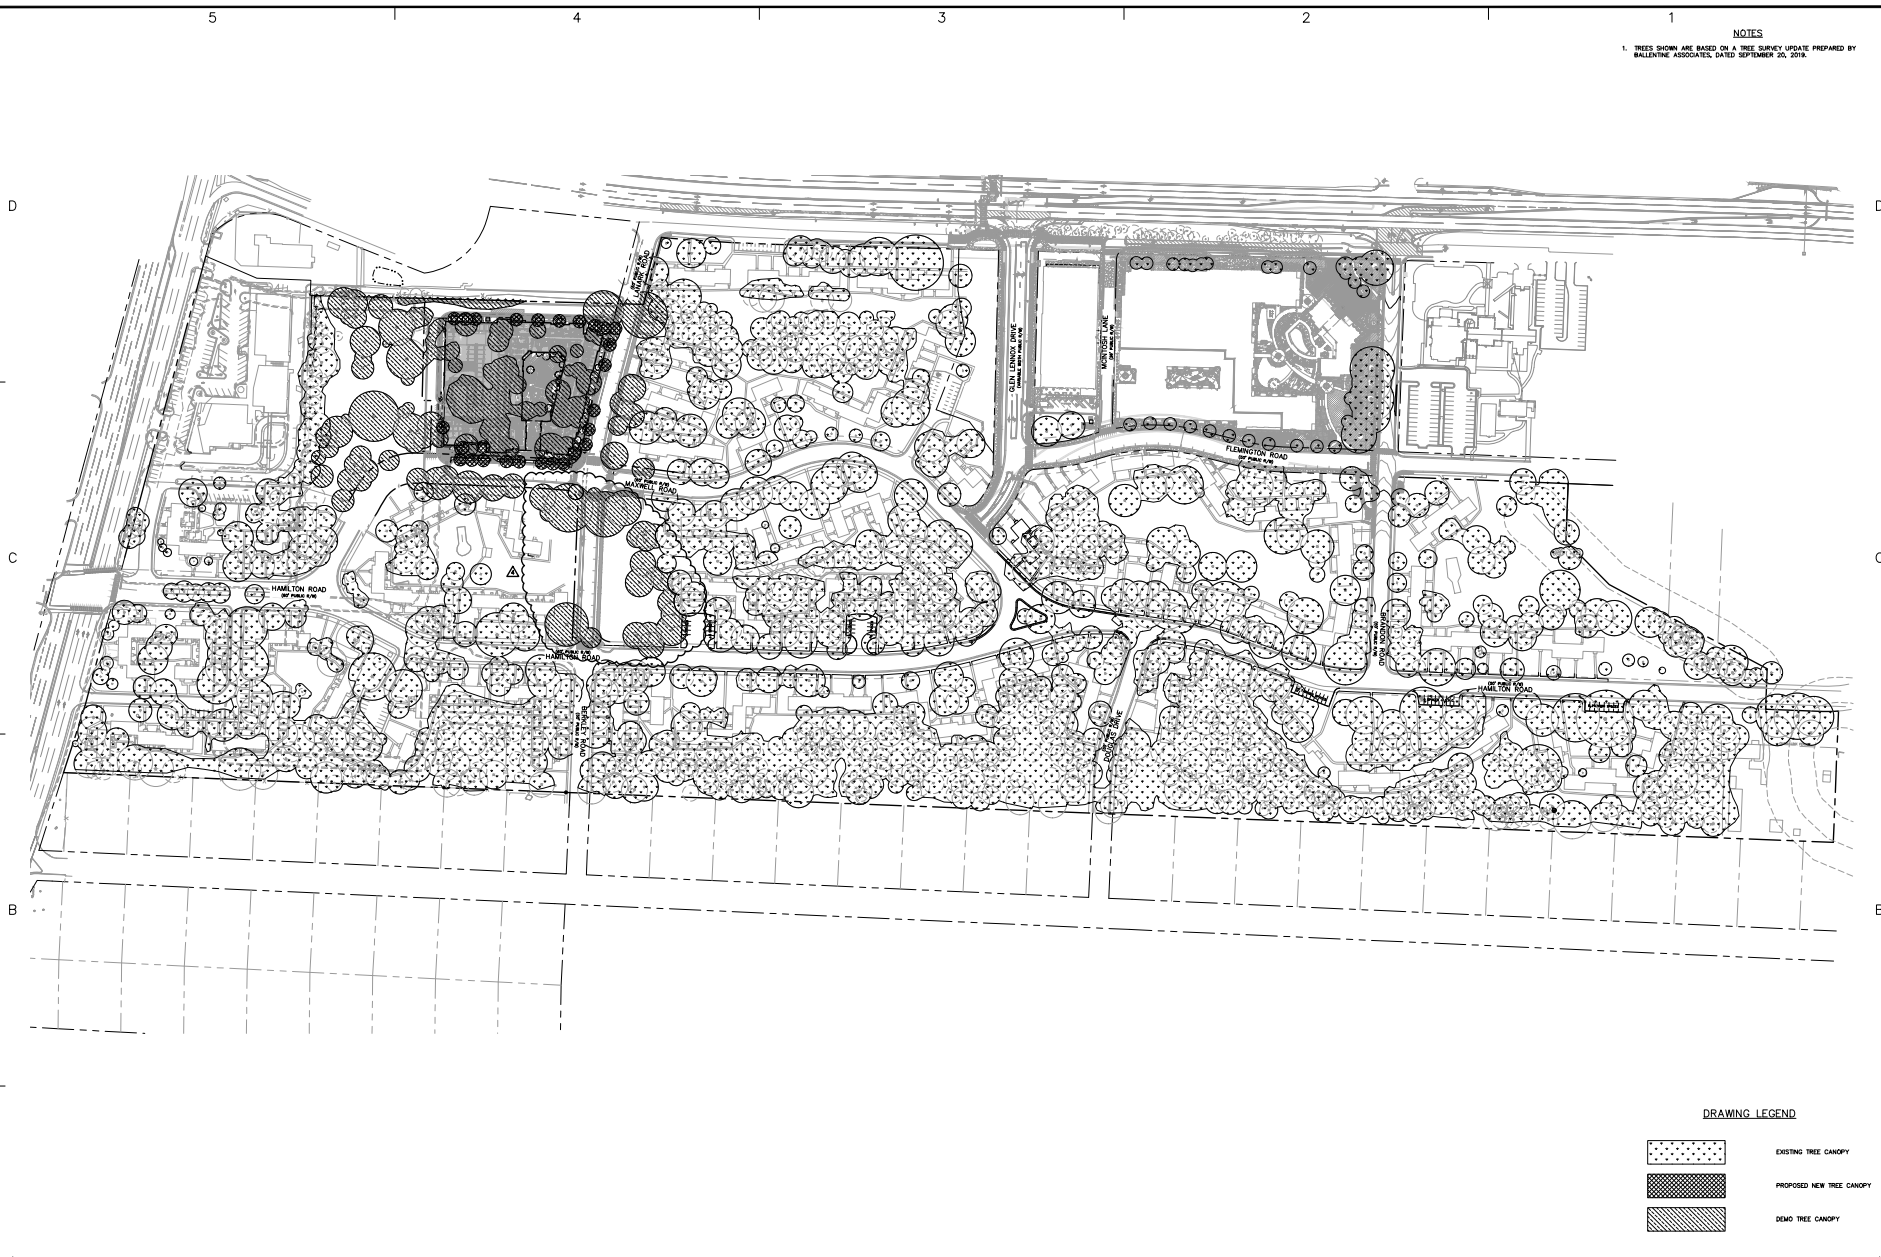

DRAWING LEGEND

- EXISTING TREE CANOPY
- PROPOSED NEW TREE CANOPY
- DEMO TREE CANOPY

TREE CANOPY COVERAGE TABLE

TOTAL PROPERTY AREA:	3,091,928 S.F.	70.98 AC.
NET PROPERTY AREA (LESS P.D.W., UTILITY EASEMENT, ACTIVE RESERVATIONS):	2,858,701 S.F.	65.65 AC. (92.44%)
TREE CANOPY REQUIRED:	807,810 S.F.	18.69 AC. (30%)
EXISTING TREE CANOPY:	1,576,073 S.F.	36.18 AC. (50.97%)
DEMO TREE CANOPY:	173,463 S.F.	3.98 AC. (5.61%)
PROPOSED NEW TREE CANOPY:	13,274 S.F.	0.30 AC. (0.42%)
TOTAL TREE CANOPY PROVIDED:	1,415,694 S.F.	32.50 AC. (45.78%)

OVERALL GLEN LENNOX TREE CANOPY COVERAGE
 (GRAPHIC SCALE IN FEET)
 1 inch = 300 FT.
REVIEW DRAWING NOT FOR CONSTRUCTION

BALLENTINE ASSOCIATES, P.A.
 228 PROVIDENCE ROAD, CHAPEL HILL, N.C. 27514
 704.282.0000


LINK APARTMENTS CALYX GLEN LENNOX - BLOCK 9A
 CHAPEL HILL, NC
 DAGP EXHIBITS

DATE	REVISIONS
18 APR 21	TREE CANOPY COVERAGE
03 SEP 21	TREE CANOPY COVERAGE
18 JUN 22	TREE CANOPY COVERAGE


OWNER INFORMATION:
 GLEN LENNOX
 177 ELMWOOD SOUTH DRIVE
 SUITE 140
 CHAPEL HILL, NC 27514
 OWNER REPRESENTATIVE:
 (919) 286-2274
 (919) 286-2274
 (919) 286-2274

SHEET
 JOB #: 107033.91
 DATE: 12 FEB 21
 SCALE: AS NOTED
 DRAWN BY: G.W.S.
 REVIEWED BY: G.L.S.

SHEET C1007

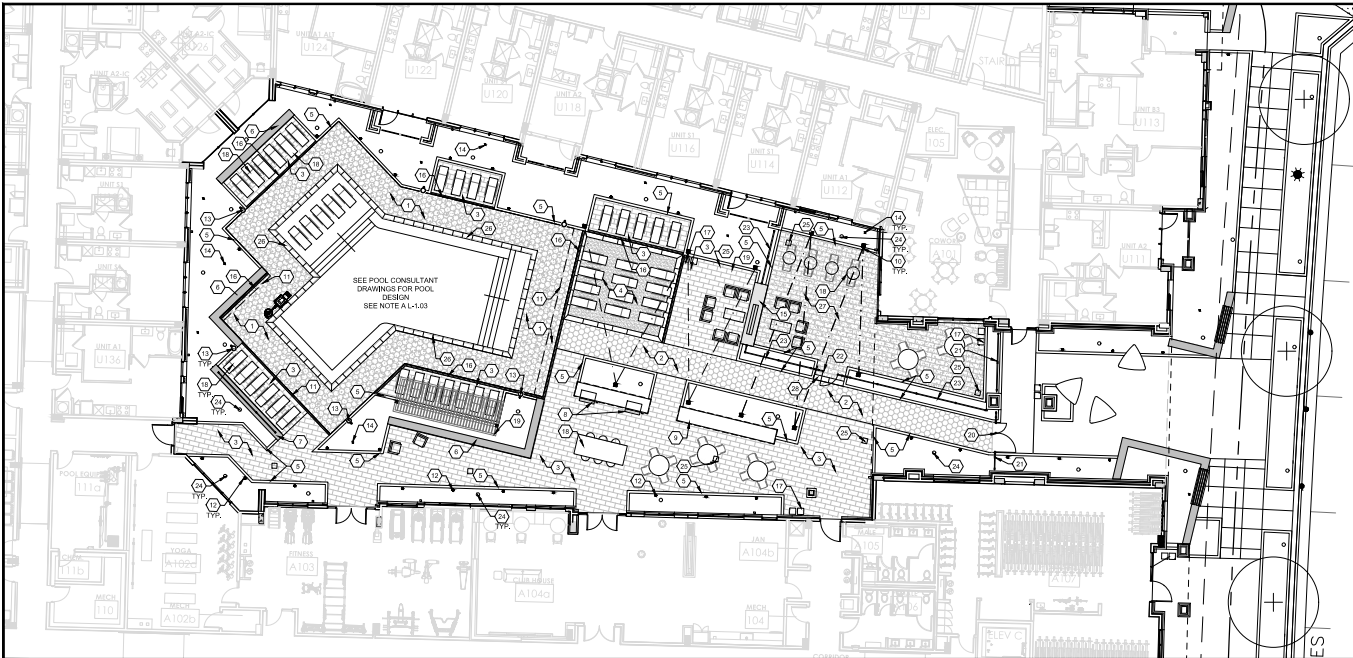

2 POOL AMENITY MATERIALS PLAN
SCALE: 1" = 10'

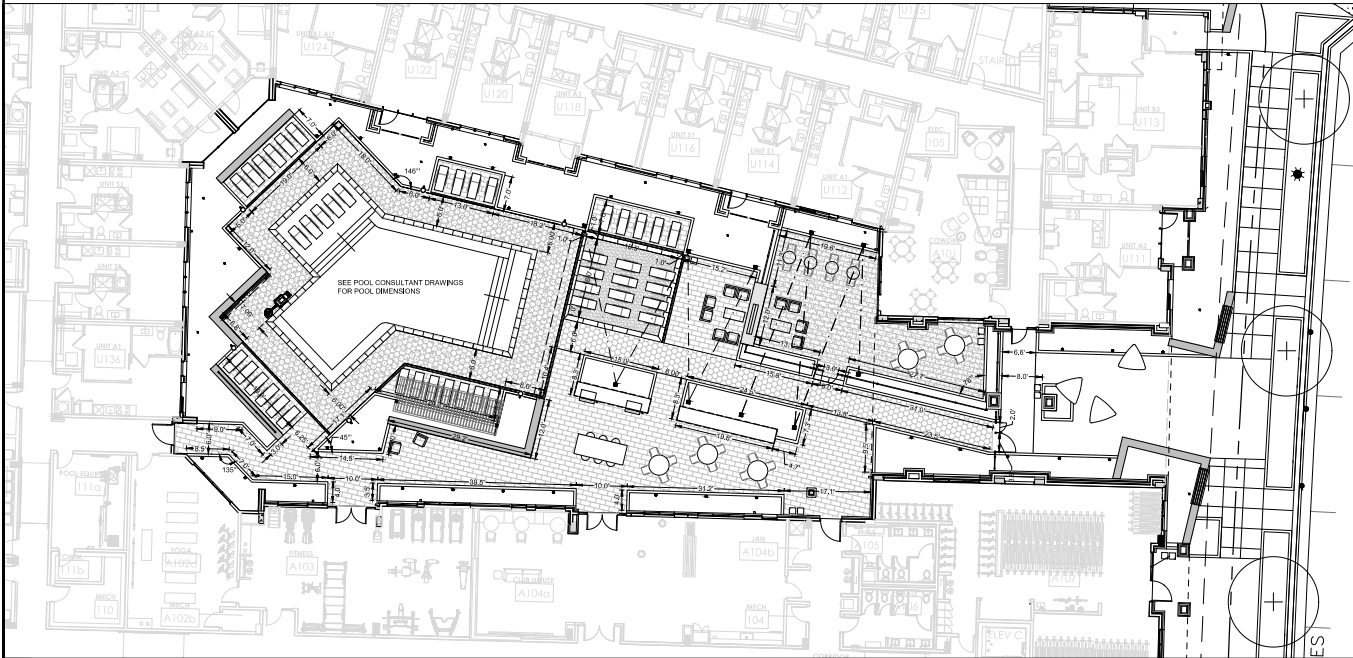

1 POOL AMENITY LAYOUT PLAN
SCALE: 1" = 10'

SCHEMATIC AMENITY MATERIALS LEGEND

- 1. UNIT PAVER TYPE A OVER CONCRETE SUBBASE - SEE MATERIALS SCHEDULE BELOW. SEE DETAIL 10.0-01
- 2. UNIT PAVER TYPE A OVER AGGREGATE SUBBASE - SEE MATERIALS SCHEDULE BELOW. SEE DETAIL 10.0-02
- 3. UNIT PAVER TYPE B OVER AGGREGATE SUBBASE - SEE MATERIALS SCHEDULE BELOW. SEE DETAIL 10.0-03
- 4. SYNTHETIC TURF - SEE MATERIALS SCHEDULE BELOW - SEE DETAIL 3.A 4L-3/03
- 5. CAST IN PLACE CONCRETE CURBING - SEE DETAIL 4L-3/00
- 6. MASONRY SEAT WALL WITH CAST STONE CAP - SEE DETAIL 6 & 7L-3/03
- 7. MASONRY SEAT WALL WITH METAL SCREEN - SEE DETAIL 6L-3/03
- 8. (2) 3" NATURAL GAS GRILLES - SEE NOTES ON DETAIL 11 & 13L-3/03 AND DETAIL 11L-3/04
- 9. PREP COUNTER - SEE DETAILS 14L-3/03 AND DETAIL 2L3/04. SEE NOTES ON DETAIL 11L-3/03
- 10. OVERHEAD MARKET LIGHTING - SEE LIGHTING PLAN FOR SPECIFICATION. SEE DETAIL 10L-3/03 FOR MARKET LIGHTING POLE FOUNDATION DETAIL.
- 11. IF POOL DECK CLEARANCE
- 12. LANDSCAPE BOLLARD LIGHTING, TYP. - SEE LIGHTING PLAN FOR SPECIFICATION AND QUANTITY - SEE DETAIL 4L-3/01
- 13. COURTYARD POLE LIGHTS, TYP. - SEE LIGHTING PLAN FOR SPECIFICATION AND QUANTITY - SEE DETAIL 2L3/01
- 14. TREE LIGHTS, TYP. - SEE LIGHTING PLAN FOR SPECIFICATION AND QUANTITY - SEE DETAIL 5L-3/01
- 15. OUTDOOR GAS FIREPLACE FEATURE WALL - SEE DETAILS 3L-3/04. SEE NOTE B BELOW
- 16. 5" STAINLESS STEEL SLIP RESISTANT HELL PROOF TRENCH DRAIN - SEE DETAIL 4 & 6L-3/03, 5L-3/04 AND NOTE B BELOW
- 17. LITTER AND RECYCLING RECEPTACLES (TOTAL OF 3 SETS) - SEE DETAIL 10L-3/00
- 18. SITE FURNISHINGS - BY OTHERS
- 19. OVERHEAD PERGOLA BY STRUCTURES OR APPROVED EQUAL - SEE NOTE D BELOW
- 20. POOL GATE 1 - SEE DETAIL 10.0-01 - SEE NOTE C BELOW
- 21. POOL FENCE TYPE 1 - SEE DETAIL 2L-3/01
- 22. POOL GATE 2 - SEE DETAIL 3L-3/01 - SEE NOTE C BELOW
- 23. POOL FENCE TYPE 2 - SEE DETAIL 4L-3/01
- 24. ATRIUM GRATE (TOTAL OF 20) - SEE CIVIL PLANS FOR RM ELEVATIONS. SEE NOTE G BELOW
- 25. AREA DRAIN (TOTAL OF 5) - SEE CIVIL PLANS FOR RM ELEVATIONS AND NOTE F AND G BELOW
- 26. TERRAZZO POOL COPING, ALL CORNERS TO BE MITER JOINTS, COPING TO SLOPE AWAY FROM POOL EDGE - SEE DETAIL 5L-3/03
- 27. UNIT PAVER TYPE C - PERMEABLE PAVERS - SEE MATERIALS SCHEDULE BELOW. SEE DETAIL 2L-3/00
- 28. CAST IN PLACE CONCRETE BAND TO SEPARATE PERMEABLE PAVERS FROM UNIT PAVERS COVER AGGREGATE BASE.

AMENITY MATERIALS NOTES

- A. POOL, AS INDICATED IS SCHEMATIC. FINAL POOL DRAWINGS TO BE PROVIDED BY POOL CONSULTANT. POOL TO INCLUDE SUNSHIELDS AS INDICATED, HANDRAILS AND LADDERS TO BE STAINLESS STEEL FROM SR85 SOUTH AFRICAN SERIES. POOL TILE TO BE DECORATIVE PORCELAIN MOSAIC TILES. HEAVY TILE, BY CLASSIC POOL TILE ATLANTA, GA OR APPROVED EQUAL. ALL TILE TO BE APPROVED BY LANDSCAPE ARCHITECT. COLOR OF TILE TO MATCH BUILDING ACCENT COLOR AND BE APPROVED BY LANDSCAPE ARCHITECT. COPING TO BE TERRAZZO. COLOR TO BE DETERMINED. PLASTER TO BE WHITE QUARTZ. ADA POOL LIFT TO HAVE WHITE FRAME AND WHITE SEAT. TYPICAL OF FREEDOM BY SPECIFICATIONS AQUATIC OR APPROVED EQUAL. (2) PROOF PROOF HOSE BIBS TO BE PROVIDED FOR POOL DECK. HOSE BIBS TO BE LOCATED TO ALLOW ACCESS TO ALL PAVING WITHIN POOL AREA USING A 100' HOSE. SEE MEP PLANS FOR HOSE BIB LOCATIONS.
- B. FIRE FEATURE WALL TO BE FROM THE DAVING SEE THRU FIRE PLACE COLLECTION. FIRE FIT INSERT TO INCLUDE ELECTRONIC IGNITION, F1-TOP AND 3 HOUR TIMER. CONTRACTOR TO COORDINATE LOCATION OF TIMER AND 3-TOP WITH LANDSCAPE ARCHITECT DURING CONSTRUCTION. FIRE FIT INSERT TO BE INSTALLED PER MANUFACTURER SPECIFICATIONS AND COORDINATED WITH MEP. ELECTRIC AND GAS CONNECTIONS REQUIRED FOR EACH FIRE FIT INSERT. CONTRACTOR TO COORDINATE WITH MEP. LOCATION OF AIR INTAKES AND EXHAUST MANIFOLD TO BE COORDINATED WITH FIREPLACE MANUFACTURER.
- C. POOL GATES TO BE COMMERCIAL GRADE TEMPERED GLASS BY STYLEGUARD OR APPROVED EQUAL. POOL GATE TO BE A MIN. OF 48" ABOVE GRADE AS MEASURED ON EXTERIOR SIDE OF THE BARRIER. THE DISTANCE BETWEEN TOP AND BOTTOM HORIZONTAL MEMBERS IS 48" OR GREATER. POOL GATE TO MEET ALL IBC POOL CODES. SEE LAYOUT PLAN FOR GATE WIDTHS. REFER TO GATE MANUFACTURER SPECIFICATION FOR STANDARDS OUT TO OUTS. WIND RELEASE LATCH MECHANISM LESS THAN 48" ABOVE BOTTOM GATE RAIL. PROVIDE LEVER HANDLE LATCH WITH KEY. KEY IS READER ACCESS CONTROL. ON EXTERIOR SIDE. RELEASE LATCH MECHANISM POOL SIDE SHALL BE SET AT LEAST 7" BELOW TOP OF GATE. GATE AND FENCE SHALL HAVE A MINIMUM 12" OPENING WITHIN 18" OF LATCH RELEASE. PROVIDE TEMPERED GLASS WITH MAXIMUM OF 2" OPENINGS TO 18" MIN. EACH SIDE OF LATCH RELEASE.
- D. PERGOLA STRUCTURE TO BE FROM STRUCTURE PRODUCT LINE AND MEET THE DIMENSIONS SHOWN ON THE PLAN. EACH PERGOLA TO INCLUDE OVERHEAD LIGHTING AND FANS. FOOTING LOCATION AND DESIGN TO BE COORDINATED WITH STRUCTURAL ENGINEER. FINAL DESIGN TO BE COORDINATED WITH ARCHITECT AND STRUCTURAL ENGINEER. PERGOLA TO BE DELEGATED DESIGN. CONTRACTOR TO SUBMIT FULL SHOP DRAWINGS FOR REVIEW AND APPROVAL TO LANDSCAPE ARCHITECT.
- E. TRENCH DRAIN TO BE A 5" STAINLESS STEEL SLIP RESISTANT TRENCH DRAIN. TRENCH DRAINS TO BE INTO STORM SYSTEM. ALL CONNECTIONS TO BE COORDINATED WITH CIVIL ENGINEER.
- F. AREA DRAINS TO BE 1/2" P-10" AREA DRAIN OR APPROVED EQUAL. ALL AREA DRAINS TO BE INTO STORM SYSTEM. ALL CONNECTIONS AND INVERTS TO BE COORDINATED WITH CIVIL ENGINEER. AREA DRAINS TO MATCH PAVING COLOR IN VACUUM. WILL BE INSTALLED.
- G. ALL LANDSCAPE AREAS / PLANTERS TO HAVE SUBSURFACE DRAINAGE. ALL SUBSURFACE DRAINAGE TO THE INFO STORM SYSTEM. SEE CIVIL PLANS FOR INVERTS AND TIE IN LOCATIONS.

MATERIALS SCHEDULE

MATERIAL	TYPE	COLOR	MANUFACTURER	NOTES
UNIT PAVER TYPE A	HEXAGON PAVERS	FRONT STANDARD COLOR AND FRESH PALETTE	UNILOCK	INSTALL PER MANUFACTURER'S SPECIFICATIONS
UNIT PAVER TYPE B	ARTLINE PAVERS	FRONT STANDARD COLOR AND FRESH PALETTE	UNILOCK	INSTALL PER MANUFACTURER'S SPECIFICATIONS
UNIT PAVER TYPE C	ECO-LINE PERMEABLE PAVERS	FRONT STANDARD COLOR AND FRESH PALETTE	UNILOCK	INSTALL PER MANUFACTURER'S SPECIFICATIONS
SYNTHETIC LAWN	4SERIES	SYNLAGUSTINE X47	SYNLAWN	INSTALL PER MANUFACTURER'S SPECIFICATIONS

CAUTION!!!
THE LOCATIONS AND ELEVATIONS OF EXISTING UNDERGROUND UTILITIES AS SHOWN ON THIS DRAWING ARE ONLY APPROXIMATE. NO GUARANTEE IS GIVEN EXPRESS OR IMPLIED AS TO THE COMPLETENESS OF ACCURACY THEREOF. THE CONTRACTOR SHALL BE EXCLUSIVELY RESPONSIBLE FOR DETERMINING THE EXACT UTILITY LOCATIONS AND ELEVATIONS PRIOR TO THE START OF CONSTRUCTION.

AMENITY COURTYARD LAYOUT AND MATERIALS PLAN

(GRAPHIC SCALE IN FEET)
1 inch = 10 ft.

BALLENTINE ASSOCIATES P.A.
228 PROVINCIAL ROAD,
CHapel Hill, NC 27514
919.286.2000

DATE: 12 FEB 21
SCALE: AS NOTED
DRAWN BY: R.M.
CHECKED BY: R.M.

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CHECKED BY: R.M.



100% CONSTRUCTION DOCUMENTS - ISSUE FOR CONSTRUCTION

LINK CALYX - GLEN LENNOX MF 9A

LOCATION / CHAPEL HILL, NC
PROJECT # / 20GRU060
DATE / 03.26.2021
DRAWN / Author

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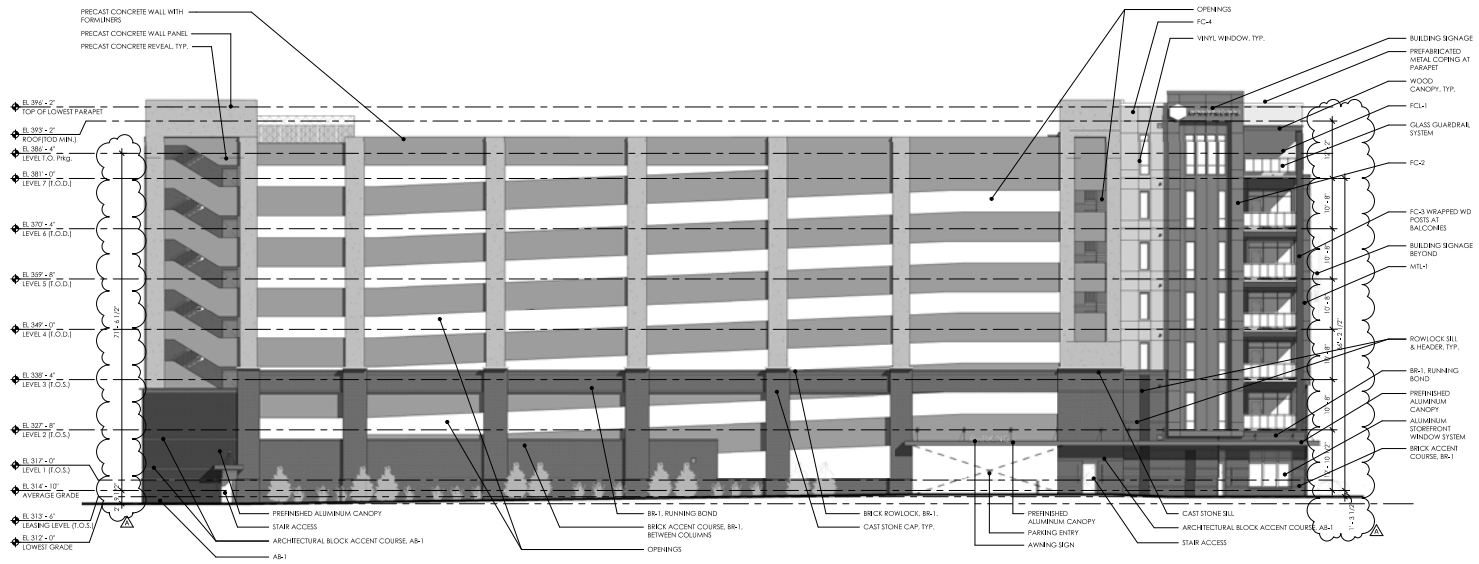
Revisions		
No.	Description	Date
A	DEEP CYCLE 1 COMMENTS	04.09.2021

BUILDING ELEVATIONS

C-A4.02

MATERIAL LEGEND:

- BB-1 UTILITY BRICK VENEER, RUNNING BOND, 3/8"X6"X12" (COLOR 1)
- AB-1 ARCHITECTURAL BLOCK, RUNNING BOND, ROCKCAST OR EQV. BLOCK
- FC-1 FIBER CEMENT LAP SIDING PANEL
- FC-1 FIBER CEMENT PANEL W/MTL REVEAL, COLOR 1
- FC-2 FIBER CEMENT PANEL W/MTL REVEAL, COLOR 2
- FC-3 FIBER CEMENT PANEL W/MTL REVEAL, COLOR 3
- FC-4 FIBER CEMENT PANEL W/MTL REVEAL, COLOR 4
- MTL-1 METAL PANEL CLADDING SYSTEM, COLOR 1



ELEVATION - PRIVATE STREET B
SCALE: 3/32" = 1'-0"