

MCADAMS The John R. McAdams Company, Inc.

2905 Meridian Parkway Durham, NC 27713


phone 919. 361. 5000 fax 919. 361. 2269 license number: C-0293, C-187

www.mcadamsco.com

CLIENT

REFUEL OPERATING COMPANY, LLC 547 LONG POINT RS, SUITE 103 MT. PLEASANT, SC 29464 Ryan Robinson, PMP PHONE: 843. 388. 4966



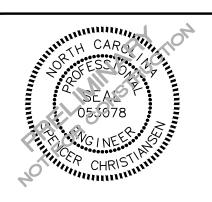

REVISIONS

NO. DATE

PLAN INFORMATION

PROJECT NO. RFM-21002 RFM21002-D1 FILENAME CHECKED BY DRAWN BY SCALE DATE

SHEET

SEE SHEET CO.00 FOR ALL PROJECT, SITE,

ALL CONSTRUCTION SHALL BE IN

AND CONSTRUCTION STANDARDS

PRELIMINARY DRAWING - NOT RELEASED FOR CONSTRUCTION


NOTES

GRADING, STORM DRAINAGE AND UTILITY

ACCORDANCE WITH THE CURRENT TOWN OF CHAPEL HILL, NCDOT, OWASA, AND ORANGE COUNTY ENGINEERING DESIGN

SITE DETAILS

09. 23. 2022

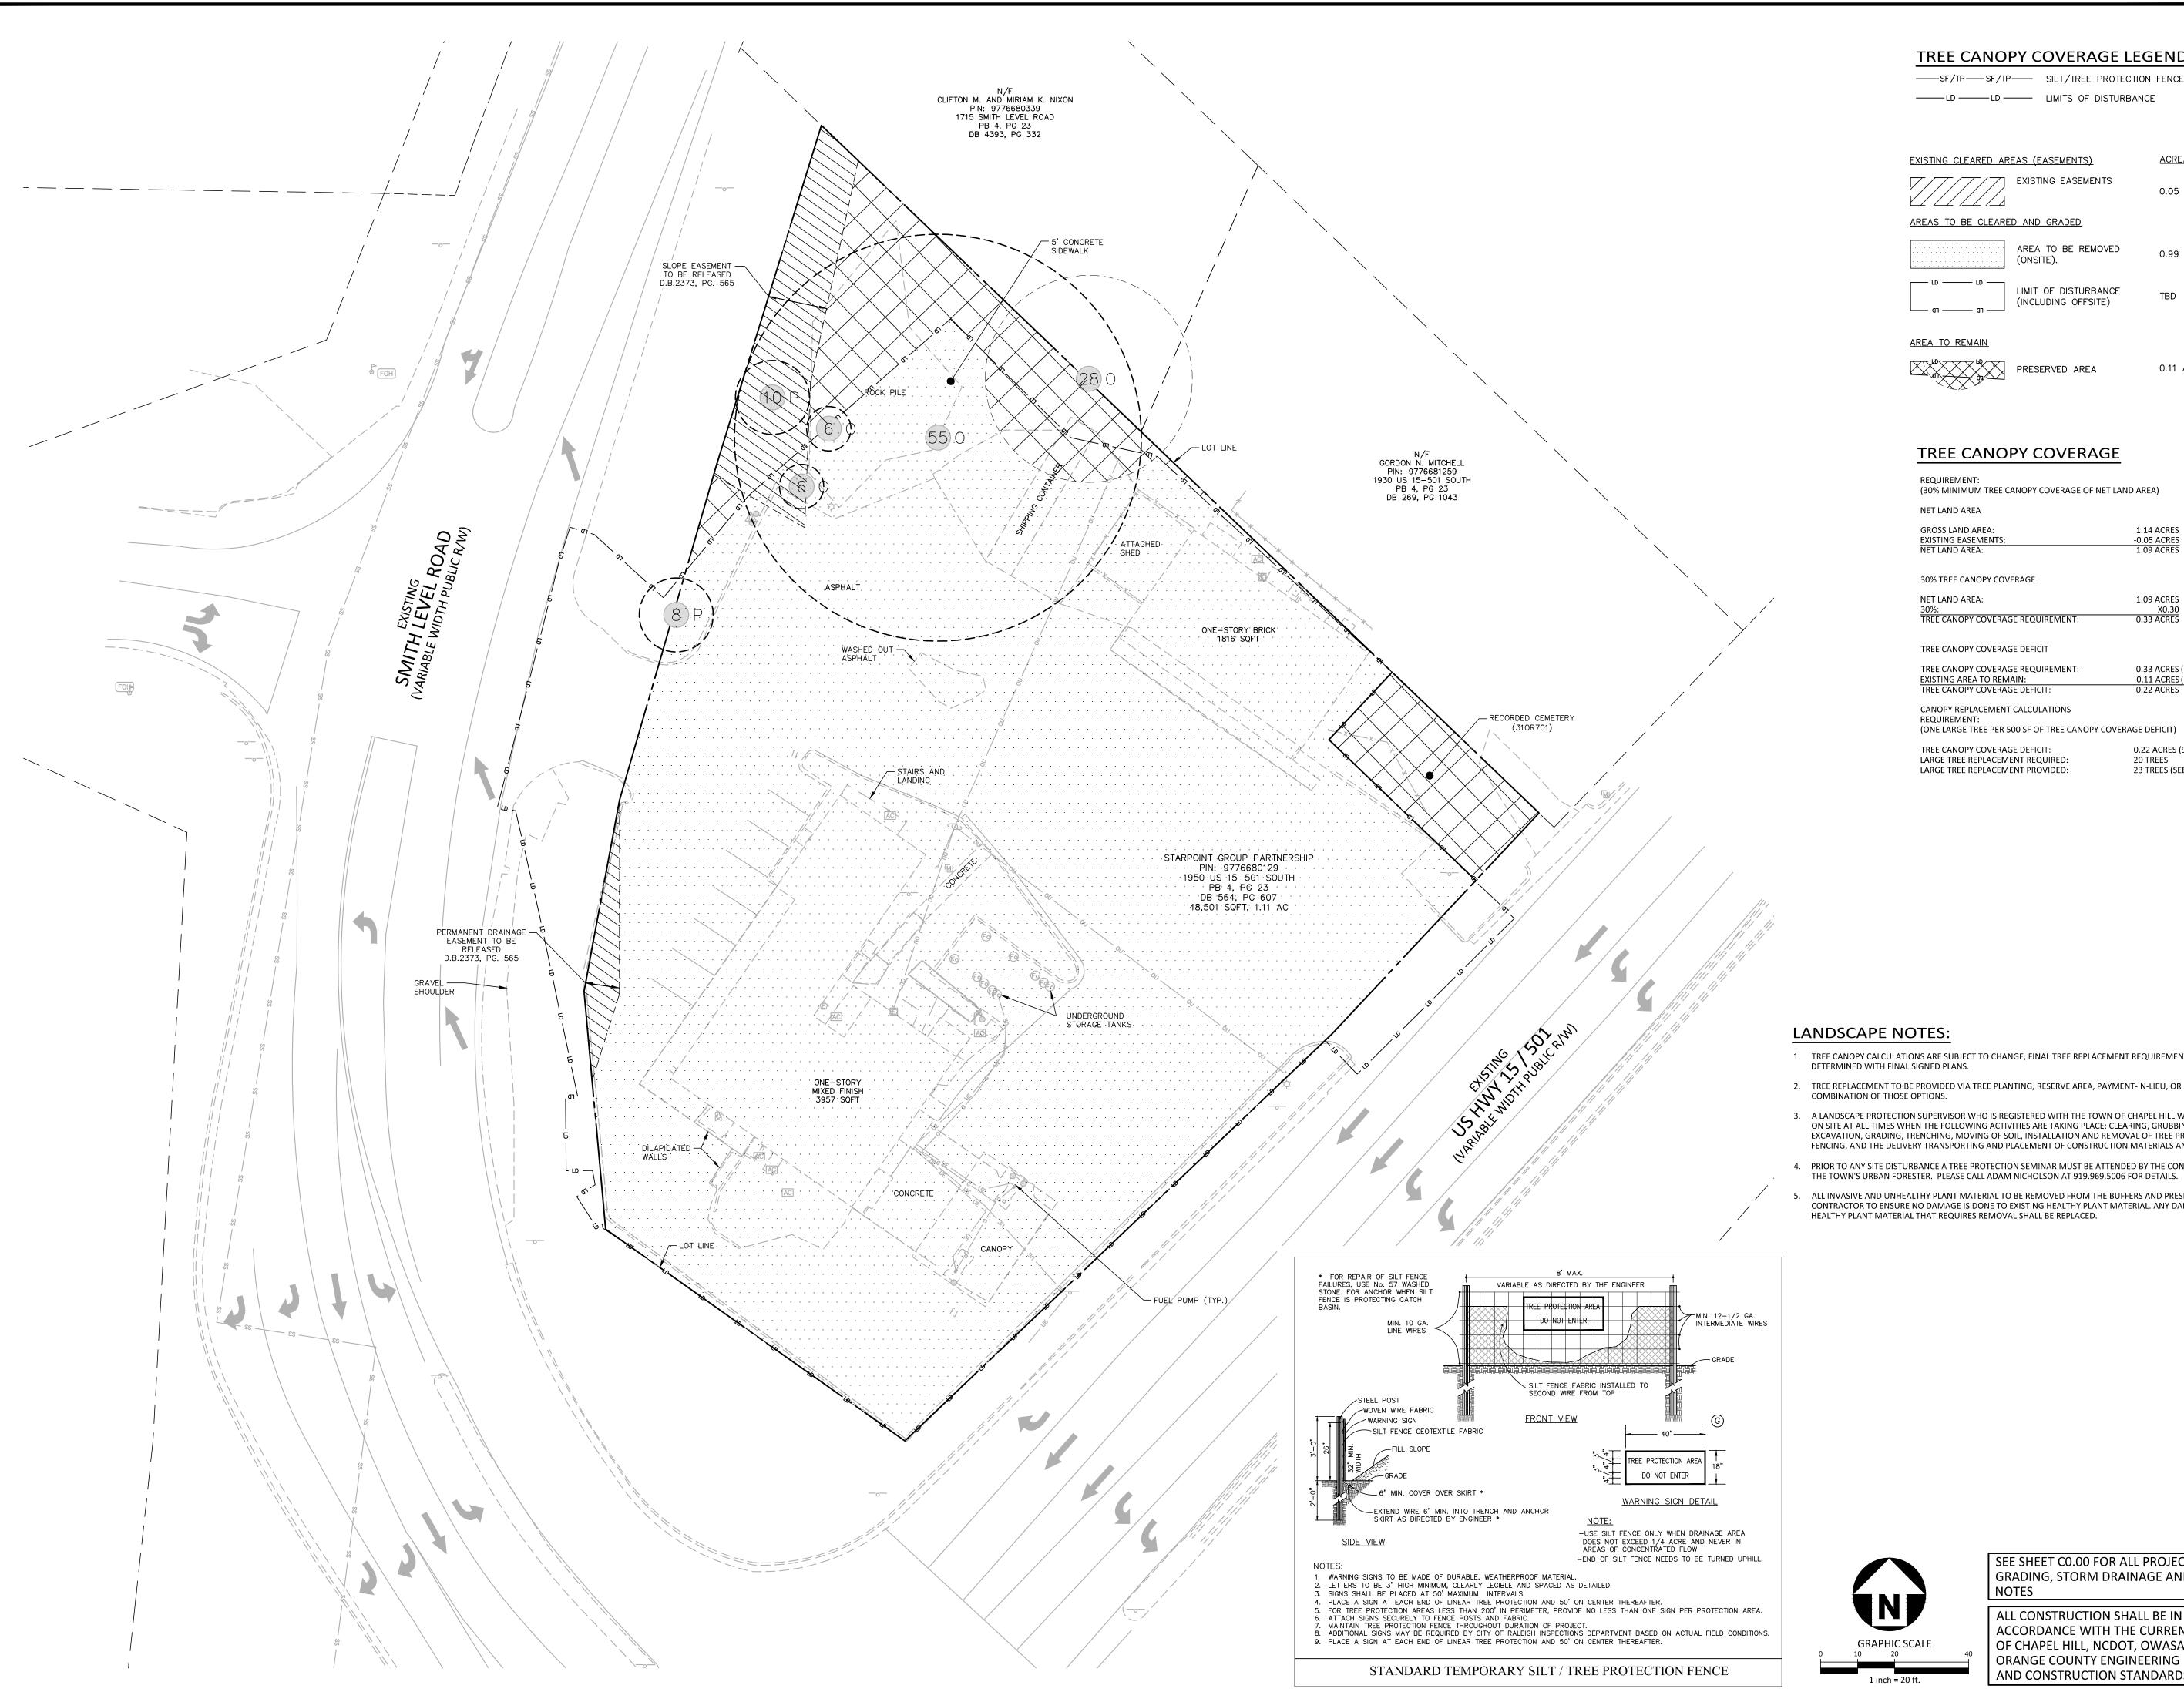

TREE CANOPY COVERAGE LEGEND

——SF/TP——SF/TP—— SILT/TREE PROTECTION FENCE ——LD ——LD — LIMITS OF DISTURBANCE

<u>ACREAGE</u> EXISTING CLEARED AREAS (EASEMENTS) Z EXISTING EASEMENTS 0.05 AC AREAS TO BE CLEARED AND GRADED AREA TO BE REMOVED 0.99 AC

(ONSITE). LIMIT OF DISTURBANCE TBD

(INCLUDING OFFSITE)

AREA TO REMAIN

PRESERVED AREA 0.11 AC

TREE CANOPY COVERAGE

REQUIREMENT: (30% MINIMUM TREE CANOPY COVERAGE OF NET LAND AREA)

NET LAND AREA

GROSS LAND AREA: 1.14 ACRES -0.05 ACRES 1.09 ACRES EXISTING EASEMENTS: NET LAND AREA:

30% TREE CANOPY COVERAGE

NET LAND AREA: 1.09 ACRES X0.30 0.33 ACRES TREE CANOPY COVERAGE REQUIREMENT:

TREE CANOPY COVERAGE DEFICIT TREE CANOPY COVERAGE REQUIREMENTS


0.33 ACRES (30.27 %) EXISTING AREA TO REMAIN: TREE CANOPY COVERAGE DEFICIT: -0.11 ACRES (6.14 %) 0.22 ACRES

CANOPY REPLACEMENT CALCULATIONS REQUIREMENT: (ONE LARGE TREE PER 500 SF OF TREE CANOPY COVERAGE DEFICIT)

TREE CANOPY COVERAGE DEFICIT: 0.22 ACRES (9,583 SF) LARGE TREE REPLACEMENT REQUIRED: 20 TREES 23 TREES (SEE SHEET L5.00) LARGE TREE REPLACEMENT PROVIDED:

LANDSCAPE NOTES:

- 1. TREE CANOPY CALCULATIONS ARE SUBJECT TO CHANGE, FINAL TREE REPLACEMENT REQUIREMENT TO BE
- 2. TREE REPLACEMENT TO BE PROVIDED VIA TREE PLANTING, RESERVE AREA, PAYMENT-IN-LIEU, OR A COMBINATION OF THOSE OPTIONS.
- 3. A LANDSCAPE PROTECTION SUPERVISOR WHO IS REGISTERED WITH THE TOWN OF CHAPEL HILL WILL BE PRESENT ON SITE AT ALL TIMES WHEN THE FOLLOWING ACTIVITIES ARE TAKING PLACE: CLEARING, GRUBBING, EXCAVATION, GRADING, TRENCHING, MOVING OF SOIL, INSTALLATION AND REMOVAL OF TREE PROTECTION FENCING, AND THE DELIVERY TRANSPORTING AND PLACEMENT OF CONSTRUCTION MATERIALS AND EQUIPMENT.
- 4. PRIOR TO ANY SITE DISTURBANCE A TREE PROTECTION SEMINAR MUST BE ATTENDED BY THE CONTRACTOR W/
- ALL INVASIVE AND UNHEALTHY PLANT MATERIAL TO BE REMOVED FROM THE BUFFERS AND PRESERVED AREA. CONTRACTOR TO ENSURE NO DAMAGE IS DONE TO EXISTING HEALTHY PLANT MATERIAL. ANY DAMAGED HEALTHY PLANT MATERIAL THAT REQUIRES REMOVAL SHALL BE REPLACED.

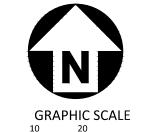

SEE SHEET CO.00 FOR ALL PROJECT, SITE, GRADING, STORM DRAINAGE AND UTILITY

ALL CONSTRUCTION SHALL BE IN ACCORDANCE WITH THE CURRENT TOWN OF CHAPEL HILL, NCDOT, OWASA, AND ORANGE COUNTY ENGINEERING DESIGN AND CONSTRUCTION STANDARDS

PRELIMINARY DRAWING - NOT RELEASED FOR CONSTRUCTION



MCADAMS

The John R. McAdams Company, Inc. 2905 Meridian Parkway Durham, NC 27713


phone 919. 361. 5000 fax 919. 361. 2269 license number: C-0293, C-187

www.mcadamsco.com CLIENT

REFUEL OPERATING COMPANY, LLC 547 LONG POINT RS, SUITE 103 MT. PLEASANT, SC 29464 Ryan Robinson, PMP

PHONE: 843. 388. 4966



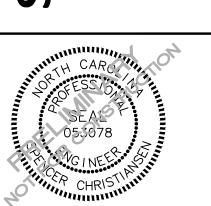

REVISIONS


NO. DATE

PLAN INFORMATION

PROJECT NO. RFM-21002 FILENAME RFM21002-TC1 CHECKED BY DRAWN BY 1" = 20' SCALE 09. 23. 2022

SHEET

LANDSCAPE PROTECTION & TREE COVERAGE PLAN

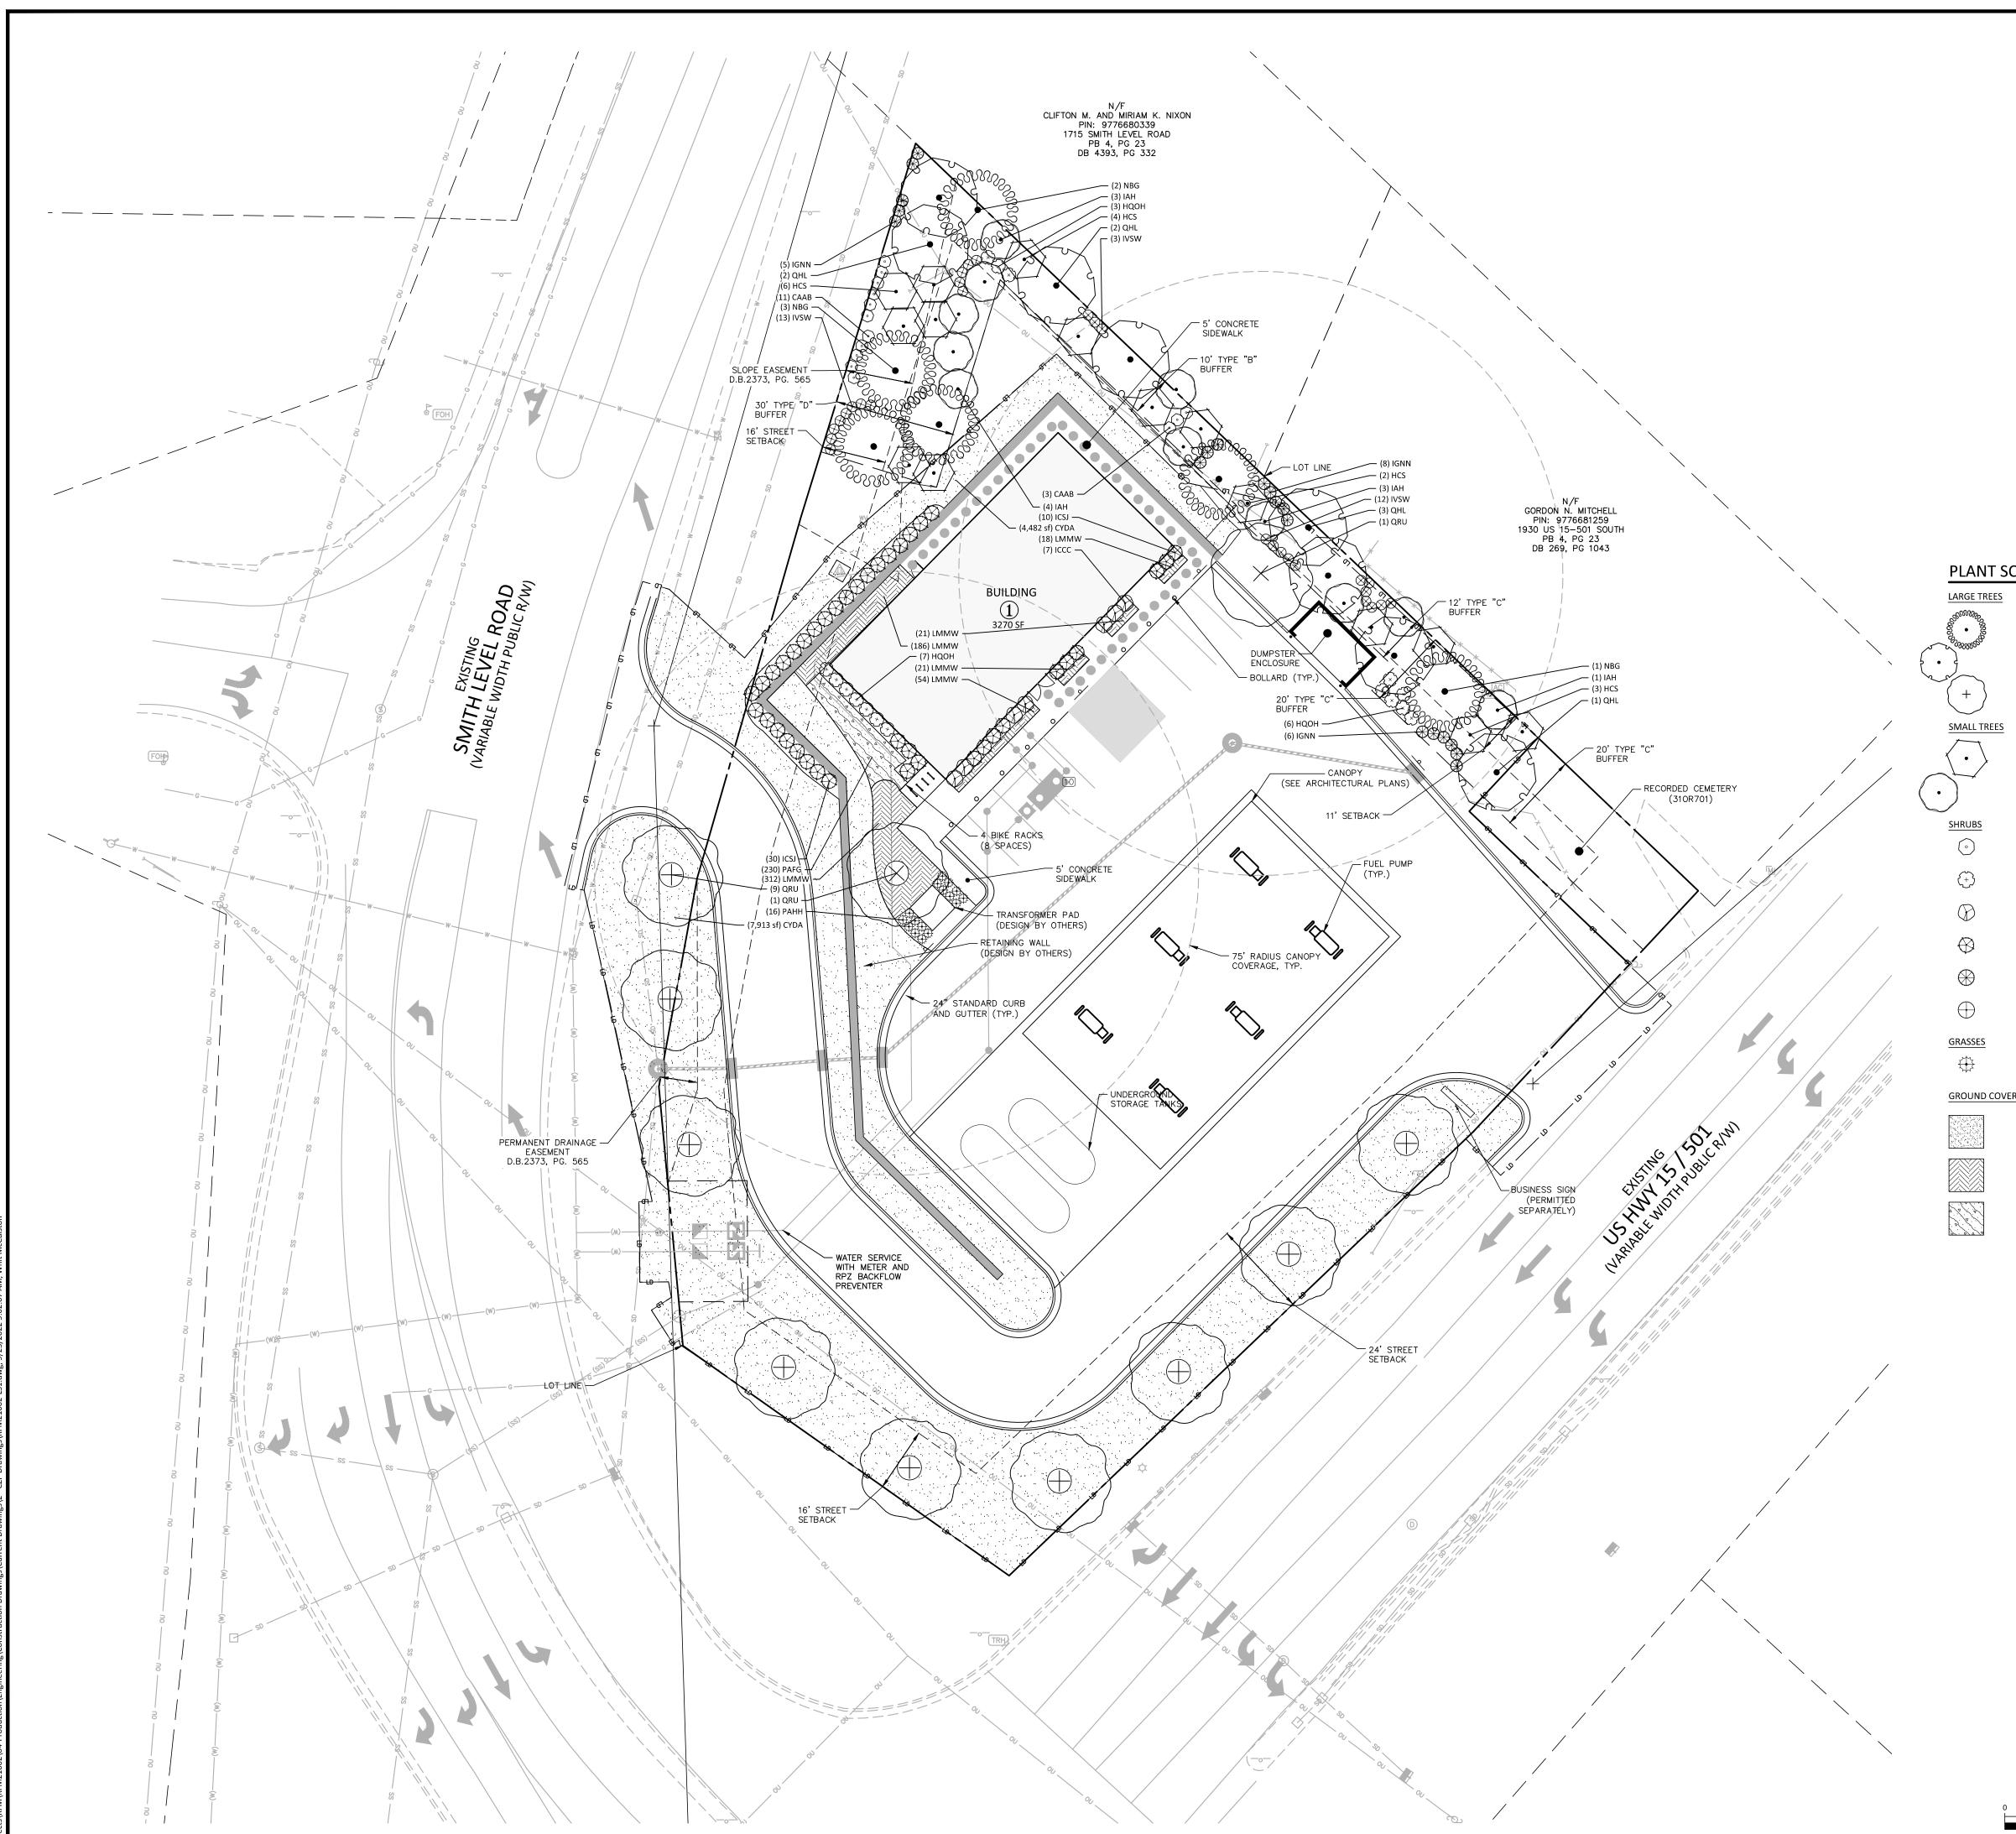

SITE LEGEND

SIGNAGE

YARD LIGHTS

LIGHT POLE

POWER POLE

TRAFFIC DIRECTIONAL ARROW

ACC

ACCESSIBLE PARKING STALL

VAN

VAN ACCESSIBLE PARKING STALL

VAN

PARKING SPACE COUNT

ACCESSIBLE RAMPS

TYPE (A) TYPE (B) TYPE (C)

ACCESSIBLE ROUTE

PHASE LINE

PROPERTY L
RIGHT-OF-V
LOT LINE
EASEMENT L
CENTERLINE

PLANT SCHEDULE OVERALL LANDSCAPE PLAN

CODE QTY BOTANICAL NAME COMMON NAME Black Gum Nyssa sylvatica Quercus hemisphaerica Laurel Oak Quercus rubra COMMON NAME **BOTANICAL NAME** Halesia carolina American Holly llex opaca COMMON NAME BOTANICAL NAME CODE American Beautyberry Callicarpa americana Oakleaf Hydrangea Hydrangea quercifolia ICCC 7 Carissa Holly Ilex cornuta `Carissa` Ilex crenata `Steeds` BOTANICAL NAME Hameln Dwarf Fountain Grass Pennisetum alopecuroides `Hameln **BOTANICAL NAME** CYDA 12,395 sf Bermuda Sod Cynodon dactylon Liriope muscari `Monroe White` Monroe White Liriope

Cassian Fountain Grass



SEE SHEET CO.00 FOR ALL PROJECT, SITE, GRADING, STORM DRAINAGE AND UTILITY NOTES

ALL CONSTRUCTION SHALL BE IN
ACCORDANCE WITH THE CURRENT TOWN
OF CHAPEL HILL, NCDOT, OWASA, AND
ORANGE COUNTY ENGINEERING DESIGN
AND CONSTRUCTION STANDARDS

Pennisetum alopecuroides 'Cassian'

PRELIMINARY DRAWING - NOT RELEASED FOR CONSTRUCTION



McAdams

The John R. McAdams Company, Inc. 2905 Meridian Parkway Durham, NC 27713

fax 919. 361. 2269 license number: C-0293, C-187

www.mcadamsco.com

phone 919. 361. 5000


CLIENT

REFUEL OPERATING COMPANY, LLC 547 LONG POINT RS, SUITE 103 MT. PLEASANT, SC 29464 Ryan Robinson, PMP PHONE: 843. 388. 4966



KET

TARPOINT - REFUEL MAI CONDITIONAL ZONING PERMITS 1950 US HWY 15-501 N

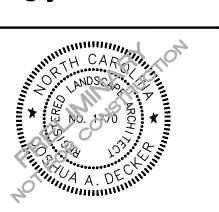

REVISIONS

NO. DATE

PLAN INFORMATION

PROJECT NO. RFM-21002

FILENAME RFM21002-LS1

CHECKED BY JAD

DRAWN BY CMXY

SCALE 1" = 20'

DATE 09. 23. 2022

SHEET

LANDSCAPE PLAN

L5.00

GENERAL LANDSCAPE NOTES: 1. ALL MATERIALS AND METHODS OF CONSTRUCTION SHALL BE IN ACCORDANCE WITH THE

- TOWN OF CHAPEL HILL AND THE STATE OF NORTH CAROLINA STANDARDS AND SPECIFICATIONS. 2. CONTRACTOR IS RESPONSIBLE FOR THE SITE INSPECTION BEFORE LANDSCAPE
- CONSTRUCTION AND INSTALLATION IN ORDER TO BECOME FAMILIAR WITH THE EXISTING
- BEFORE BEGINNING DEMOLITION OR INSTALLATION. 4. CONTRACTOR SHALL NOTIFY LANDSCAPE ARCHITECT OF ANY DISCREPANCIES BETWEEN THE NOTES, SPECIFICATIONS, DRAWINGS OR SITE CONDITIONS FOR RESOLUTION PRIOR TO

3. LANDSCAPE CONTRACTOR IS RESPONSIBLE FOR LOCATING ALL UNDERGROUND UTILITIES

5. ANY DAMAGE TO UTILITIES SHALL BE REPAIRED AT THE CONTRACTOR'S EXPENSE.

- 6. THIS PLAN IS FOR PLANTING PURPOSES ONLY. FOR INFORMATION REGARDING BUILDINGS, GRADING, WALLS, ETC., REFER TO ARCHITECTURE, SITE AND GRADING PLANS.
- 7. VERIFICATION OF TOTAL PLANT QUANTITIES AS SHOWN IN THE PLANT SCHEDULE SHALL BE THE RESPONSIBILITY OF THE LANDSCAPE CONTRACTOR. ANY DISCREPANCIES SHALL BE BROUGHT TO THE ATTENTION OF THE LANDSCAPE ARCHITECT.
- 8. CONTRACTOR TO ENSURE PROPER STABILIZATION AND SEEDING OF THE SITE IN ACCORDANCE WITH APPLICABLE REGULATIONS.
- 9. LANDSCAPE MATERIAL SHALL BE WELL FORMED, VIGOROUS, GROWING SPECIMENS WITH GROWTH TYPICAL OF VARIETIES SPECIFIED AND SHALL BE FREE FROM DAMAGE, INSECTS AND DISEASES. MATERIAL SHALL EQUAL OR SURPASS #1 QUALITY AS DEFINED IN THE CURRENT ISSUE OF "AMERICAN STANDARD FOR NURSERY STOCK" AS PUBLISHED BY THE AMERICAN NURSERY & LANDSCAPE ASSOCIATION.
- 10. ALL PLANT MATERIAL IS TO BE CAREFULLY HANDLED BY THE ROOT BALL, NOT THE TRUNK, BRANCHES AND/OR FOLIAGE OF THE PLANT. MISHANDLED PLANT MATERIAL MAY BE REJECTED BY THE LANDSCAPE ARCHITECT.
- 11. ALL PLANT MATERIAL IS TO BE WELL ROOTED, NOT ROOT BOUND, SUCH THAT THE ROOT BALL REMAINS INTACT THROUGHOUT THE PLANTING PROCESS. DEFICIENT PLANT MATERIAL MAY BE REJECTED BY THE LANDSCAPE ARCHITECT OR OWNER.
- 12. ALL PLANTS TO BE A MINIMUM OF WHAT IS SPECIFIED IN THE PLANT SCHEDULE. ANY CHANGES OR SUBSTITUTIONS SHALL BE APPROVED BY THE LANDSCAPE ARCHITECT AND GOVERNING JURISDICTION PRIOR TO ANY HOLE BEING DUG.
- 13. CONTRACTOR TO COORDINATE WITH OWNER'S REPRESENTATIVE AND LANDSCAPE ARCHITECT TO ESTABLISH THE EXTENTS OF MULCH/SEED/SOD IF NOT SPECIFICALLY SHOWN
- 14. CONTRACTOR SHALL PROVIDE POSITIVE DRAINAGE IN ALL PLANTING AREAS.
- 15. PROPOSED TREES TO BE PLANTED A MINIMUM 10 FEET FROM ANY LIGHT POLE AS MEASURED FROM TRUNK OF THE TREE TO THE POLE.
- 16. PROPOSED TREES TO BE PLANTED A MINIMUM 5 FEET FROM ANY FIRE HYDRANT AS MEASURED FROM TRUNK OF THE TREE TO THE HYDRANT.
- 17. CONTRACTOR SHALL COMPLETE SOIL TEST IN ALL PLANTING AREAS TO DETERMINE SOIL AMENDMENT REQUIREMENTS UNLESS WAIVED BY OWNER'S REPRESENTATIVE. CONTRACTOR SHALL ADJUST PH AND FERTILITY BASED UPON THE SOIL TEST RESULTS.
- 18. TOPSOIL SHALL BE FREE OF MATERIAL LARGER THAN 1.0 INCH IN DIAMETER OR LENGTH AND SHALL NOT CONTAIN SLAG, CINDERS, STONES, LUMPS OF SOIL, STICKS, ROOTS, TRASH, OR OTHER EXTRANEOUS MATERIAL.
- 19. LOOSEN SUBGRADE / SURFACE SOIL TO A MINIMUM DEPTH OF 6 INCHES. APPLY SOIL AMENDMENTS AND FERTILIZERS AS REQUIRED BY THE SOIL TEST RESULTS TO ACHIEVE A HEALTHY GROWING MEDIA AND MIX THOROUGHLY INTO TOP 4 INCHES OF SOIL. SPREAD PLANTING SOIL MIX TO A DEPTH OF 6 INCHES BUT NOT LESS THAN REQUIRED TO MEET FINISH GRADES AFTER NATURAL SETTLEMENT. DO NOT SPREAD IF PLANTING SOIL OR SUBGRADE IS FROZEN, MUDDY, OR EXCESSIVELY WET.
- 20. IF IMPORTED TOPSOIL IS REQUIRED, THE SUBGRADE SHALL BE SCARIFIED OR TILLED TO A DEPTH OF AT LEAST 6 INCHES PRIOR TO INSTALLATION OF IMPORTED TOPSOIL. FOLLOWING INSTALLATION OF IMPORTED TOPSOIL, THE TOPSOIL SHALL BE TILLED TO INTEGRATE THE SOIL PROFILES
- 21. PLANT MATERIALS ARE TO BE GUARANTEED FOR A PERIOD OF 12 MONTHS. PLANT MATERIALS WHICH REMAIN UNHEALTHY WILL BE REPLACED BY THE LANDSCAPE CONTRACTOR BEFORE THE EXPIRATION OF THE GUARANTEE PERIOD OR IMMEDIATELY IF SO DIRECTED BY THE OWNER'S REPRESENTATIVE OR LANDSCAPE ARCHITECT.
- 22. ALL TREE PLANTINGS SHALL BE MULCHED TO A DEPTH OF 3 INCHES, AND WITH A MINIMUM 3 FOOT RADIUS FROM BASE OF TREE OR TO DRIPLINE. MULCH SHALL BE FREE OF TRASH AND MAINTAINED WEED FREE. MULCH SHALL NOT COVER THE ROOT FLARE. CONFIRM MULCH SPECIFICATIONS WITH OWNER'S REPRESENTATIVE OR LANDSCAPE ARCHITECT.
- 23. DO NOT PRUNE TREES AND SHRUBS BEFORE DELIVERY. PROTECT BARK, BRANCHES, AND ROOT SYSTEMS FROM SUN SCALD, DRYING, SWEATING, WHIPPING, AND OTHER HANDLING AND TYING DAMAGE. DO NOT BEND OR BIND-TIE TREES OR SHRUBS IN SUCH A MANNER AS TO DESTROY THEIR NATURAL SHAPE. PROVIDE PROTECTIVE COVERING OF EXTERIOR PLANTS DURING DELIVERY. DO NOT DROP EXTERIOR PLANTS DURING DELIVERY AND HANDLING.
- 24. DELIVER EXTERIOR PLANTS AFTER PREPARATIONS FOR PLANTING HAVE BEEN COMPLETED AND INSTALL IMMEDIATELY. IMMEDIATELY AFTER UNLOADING, STAND THE TREES UP TO REDUCE THE RISK OF SUN SCALD. PROPERLY STAGED TREES ARE STANDING, UNTIED AND SPACED. UNLESS IMMEDIATELY INSTALLED, SET EXTERIOR PLANTS AND TREES IN SHADE, PROTECT FROM WEATHER AND MECHANICAL DAMAGE, AND KEEP ROOTS MOIST.
- 25. SEE LANDSCAPE DETAILS FOR TREE STAKING REQUIREMENTS.
- 26. EXCAVATE EDGES OF ALL PLANTING BEDS TO 2 INCH DEPTH TO FORM A NEAT AND CRISP
- 27. CONTRACTOR SHALL REMOVE DEBRIS AND FINE GRADE ALL PLANTING AREAS PRIOR TO
- 28. REMOVE GUY WIRES AND STAKES AT END OF WARRANTY PERIOD OR ESTABLISHMENT.
- 29. FINISH GRADING: GRADE PLANTING AREAS TO A SMOOTH, UNIFORM SURFACE PLANE WITH LOOSE, UNIFORMLY FINE TEXTURE. GRADE TO WITHIN PLUS OR MINUS 1/2 INCH OF FINISH ELEVATION. ROLL AND RAKE, REMOVE RIDGES, AND FILL DEPRESSIONS TO MEET FINISH GRADES. LIMIT FINISHED GRADING TO AREAS THAT CAN BE PLANTED IN THE IMMEDIATE

WARRANTY & MAINTENANCE:

- 1. WARRANTY: INSTALLER SHALL REPAIR OR REPLACE ANY PLANTINGS THAT FAIL IN MATERIALS, WORKMANSHIP, OR GROWTH WITHIN ONE YEAR AFTER THE DATE OF SUBSTANTIAL COMPLETION. FAILURES INCLUDE, BUT ARE NOT LIMITED TO, THE FOLLOWING: DEATH AND UNSATISFACTORY GROWTH, EXCEPT FOR DEFECTS RESULTING FROM LACK OF ADEQUATE MAINTENANCE, NEGLECT, ABUSE BY OWNER, OR INCIDENTS THAT ARE BEYOND CONTRACTOR'S CONTROL.
- STRUCTURAL FAILURES INCLUDING PLANTINGS FALLING OR BLOWING OVER.
- 2. MAINTENANCE: INITIAL MAINTENANCE SHALL BE PROVIDED IMMEDIATELY AFTER EACH AREA IS PLANTED AND CONTINUE UNTIL SUBSTANTIAL COMPLETION. UPON SUBSTANTIAL COMPLETION, MAINTENANCE FOR ALL PLANT MATERIAL SHALL BE PROVIDED FOR
- ONE YEAR AT A MINIMUM SHALL INCLUDE: TREE AND SHRUB MAINTENANCE: MAINTAIN PLANTINGS BY PRUNING, CULTIVATING, WATERING, WEEDING, FERTILIZING, RESTORING PLANTING SAUCERS, AND RESETTING TO PROPER GRADES OR VERTICAL POSITION, AS REQUIRED TO ESTABLISH HEALTHY, VIABLE PLANTINGS. SPRAY OR TREAT AS REQUIRED TO
- KEEP TREES AND SHRUBS FREE OF INSECTS AND DISEASE. GROUND COVER AND PLANT MAINTENANCE: MAINTAIN AND ESTABLISH PLANTINGS BY WATERING, WEEDING, FERTILIZING, MULCHING, AND OTHER OPERATIONS AS REQUIRED TO ESTABLISH HEALTHY, VIABLE PLANTINGS.
- PROTECT EXTERIOR PLANTS FROM DAMAGE DUE TO LANDSCAPE OPERATIONS, OPERATIONS BY OTHER CONTRACTORS AND TRADES, AND OTHERS. MAINTAIN PROTECTION DURING INSTALLATION AND MAINTENANCE PERIODS. TREAT, REPAIR, OR REPLACE DAMAGED PLANTINGS.

LANDSCAPE CALCULATIONS PERIMETER BUFFERS 10' TYPE 'B' LARGE TREES REQUIRED: 4 (4/100 LF) PROVIDED SMALL TREES 7 (7/100 LF) REQUIRED: PROVIDED: SHRUBS REQUIRED: 12 (12/100 LF) PROVIDED: 12' TYPE 'C' LARGE TREES REQUIRED: 3 (4/100 LF) PROVIDED SMALL TREES 5 (8/100 LF) REQUIRED: PROVIDED: SHRUBS REQUIRED: 17 (30/100 LF) PROVIDED:

2 (4/100 LF)

4 (8/100 LF)

12 (30/100 LF)

5 (6/100 LF)

10 (12/100 LF)

29 (40/100 LF)

= 2

PLANT SCHEDULE OVERALL LANDSCAPE PLAN

= 1 [1 LARGE TREE PER 2000 SF]

20' TYPE 'C'

LARGE TREES

SMALL TREES

SHRUBS

30' TYPE 'D'

REQUIRED:

PROVIDED

REQUIRED:

PROVIDED:

REQUIRED:

PROVIDED:

LARGE TREES

SMALL TREES

REQUIRED:

PROVIDED

REQUIRED: PROVIDED:


REQUIRED:


PROVIDED:

PARKING AREAS:

VEHICLE USE AREAS:

REQUIRED: PROVIDED:

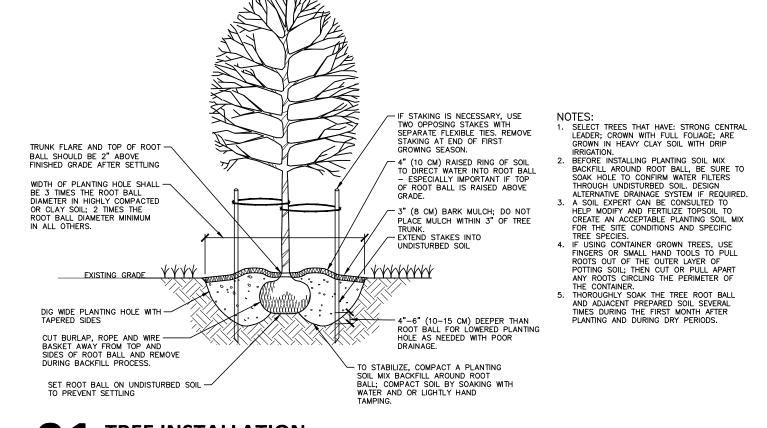

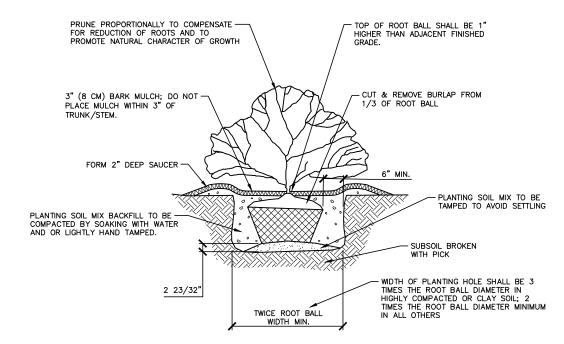

SHRUB INSTALLATION

SCALE: 3/8"=1'-0"

2905 Meridian Parkway Durham, NC 27713

phone 919. 361. 5000

www.mcadamsco.com


The John R. McAdams Company, Inc

fax 919. 361. 2269 license number: C-0293, C-187

CLIENT

REFUEL OPERATING COMPANY, LLC 547 LONG POINT RS, SUITE 103 MT. PLEASANT, SC 29464 Ryan Robinson, PMP PHONE: 843. 388. 4966



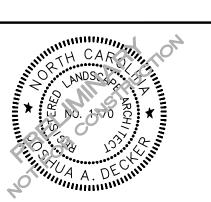

REVISIONS

NO. DATE

PLAN INFORMATION

PROJECT NO. RFM-21002 FILENAME RFM21002-LS1 CHECKED BY DRAWN BY

SCALE DATE 09. 23. 2022

SHEET


LANDSCAPE NOTES AND **CALCULATIONS**

LARGE TREES	CODE	<u>QTY</u>	COMMON NAME	BOTANICAL NAME	CAL	HEIGHT	_
- 1000000000000000000000000000000000000	NBG	6	Black Gum	Nyssa sylvatica	2" min		
• • • • • • • • • • • • • • • • • • • •	QHL	8	Laurel Oak	Quercus hemisphaerica	2" min		
+	QRU	11	Red Oak	Quercus rubra	2" min		
SMALL TREES	CODE	QTY	COMMON NAME	BOTANICAL NAME	CAL	HEIGHT	
	HCS	15	Silverbell	Halesia carolina	2.5"		
	IAH	11	American Holly	llex opaca	-	6` min	
SHRUBS	CODE	<u>QTY</u>	COMMON NAME	BOTANICAL NAME	SPREAD	HEIGHT	
\odot	CAAB	14	American Beautyberry	Callicarpa americana	-	24" min	
(+)	НООН	16	Oakleaf Hydrangea	Hydrangea quercifolia	-	24" min	
	ICCC	7	Carissa Holly	Ilex cornuta `Carissa`	-	24" min	
\otimes	ICSJ	40	Steeds Japanese Holly	Ilex crenata `Steeds`	-	30"min	
\oplus	IGNN	19	Nigra Inkberry	Ilex glabra `Nigra`	-	24" min	
\bigoplus	IVSW	28	Virginia Sweetspire	Itea virginica	-	24" min	
GRASSES	CODE	<u>QTY</u>	COMMON NAME	BOTANICAL NAME	SPREAD	HEIGHT	
***	PAHH	16	Hameln Dwarf Fountain Grass	Pennisetum alopecuroides 'Hameln'	-	3 gal	
GROUND COVERS	<u>CODE</u>	<u>QTY</u>	COMMON NAME	BOTANICAL NAME	<u>CONT</u>	<u>HEIGHT</u>	SPACING
	CYDA	12,395 sf	Bermuda Sod	Cynodon dactylon	Sod		
	LMMW	612	Monroe White Liriope	Liriope muscari `Monroe White`	4" pot		12" o.c.
A A V	PAFG	230	Cassian Fountain Grass	Pennisetum alopecuroides 'Cassian'	4" pot		12" o.c.

SEE SHEET CO.00 FOR ALL PROJECT, SITE, GRADING, STORM DRAINAGE AND UTILITY

ALL CONSTRUCTION SHALL BE IN ACCORDANCE WITH THE CURRENT TOWN OF CHAPEL HILL, NCDOT, OWASA, AND ORANGE COUNTY ENGINEERING DESIGN AND CONSTRUCTION STANDARDS

PRELIMINARY DRAWING - NOT RELEASED FOR CONSTRUCTION

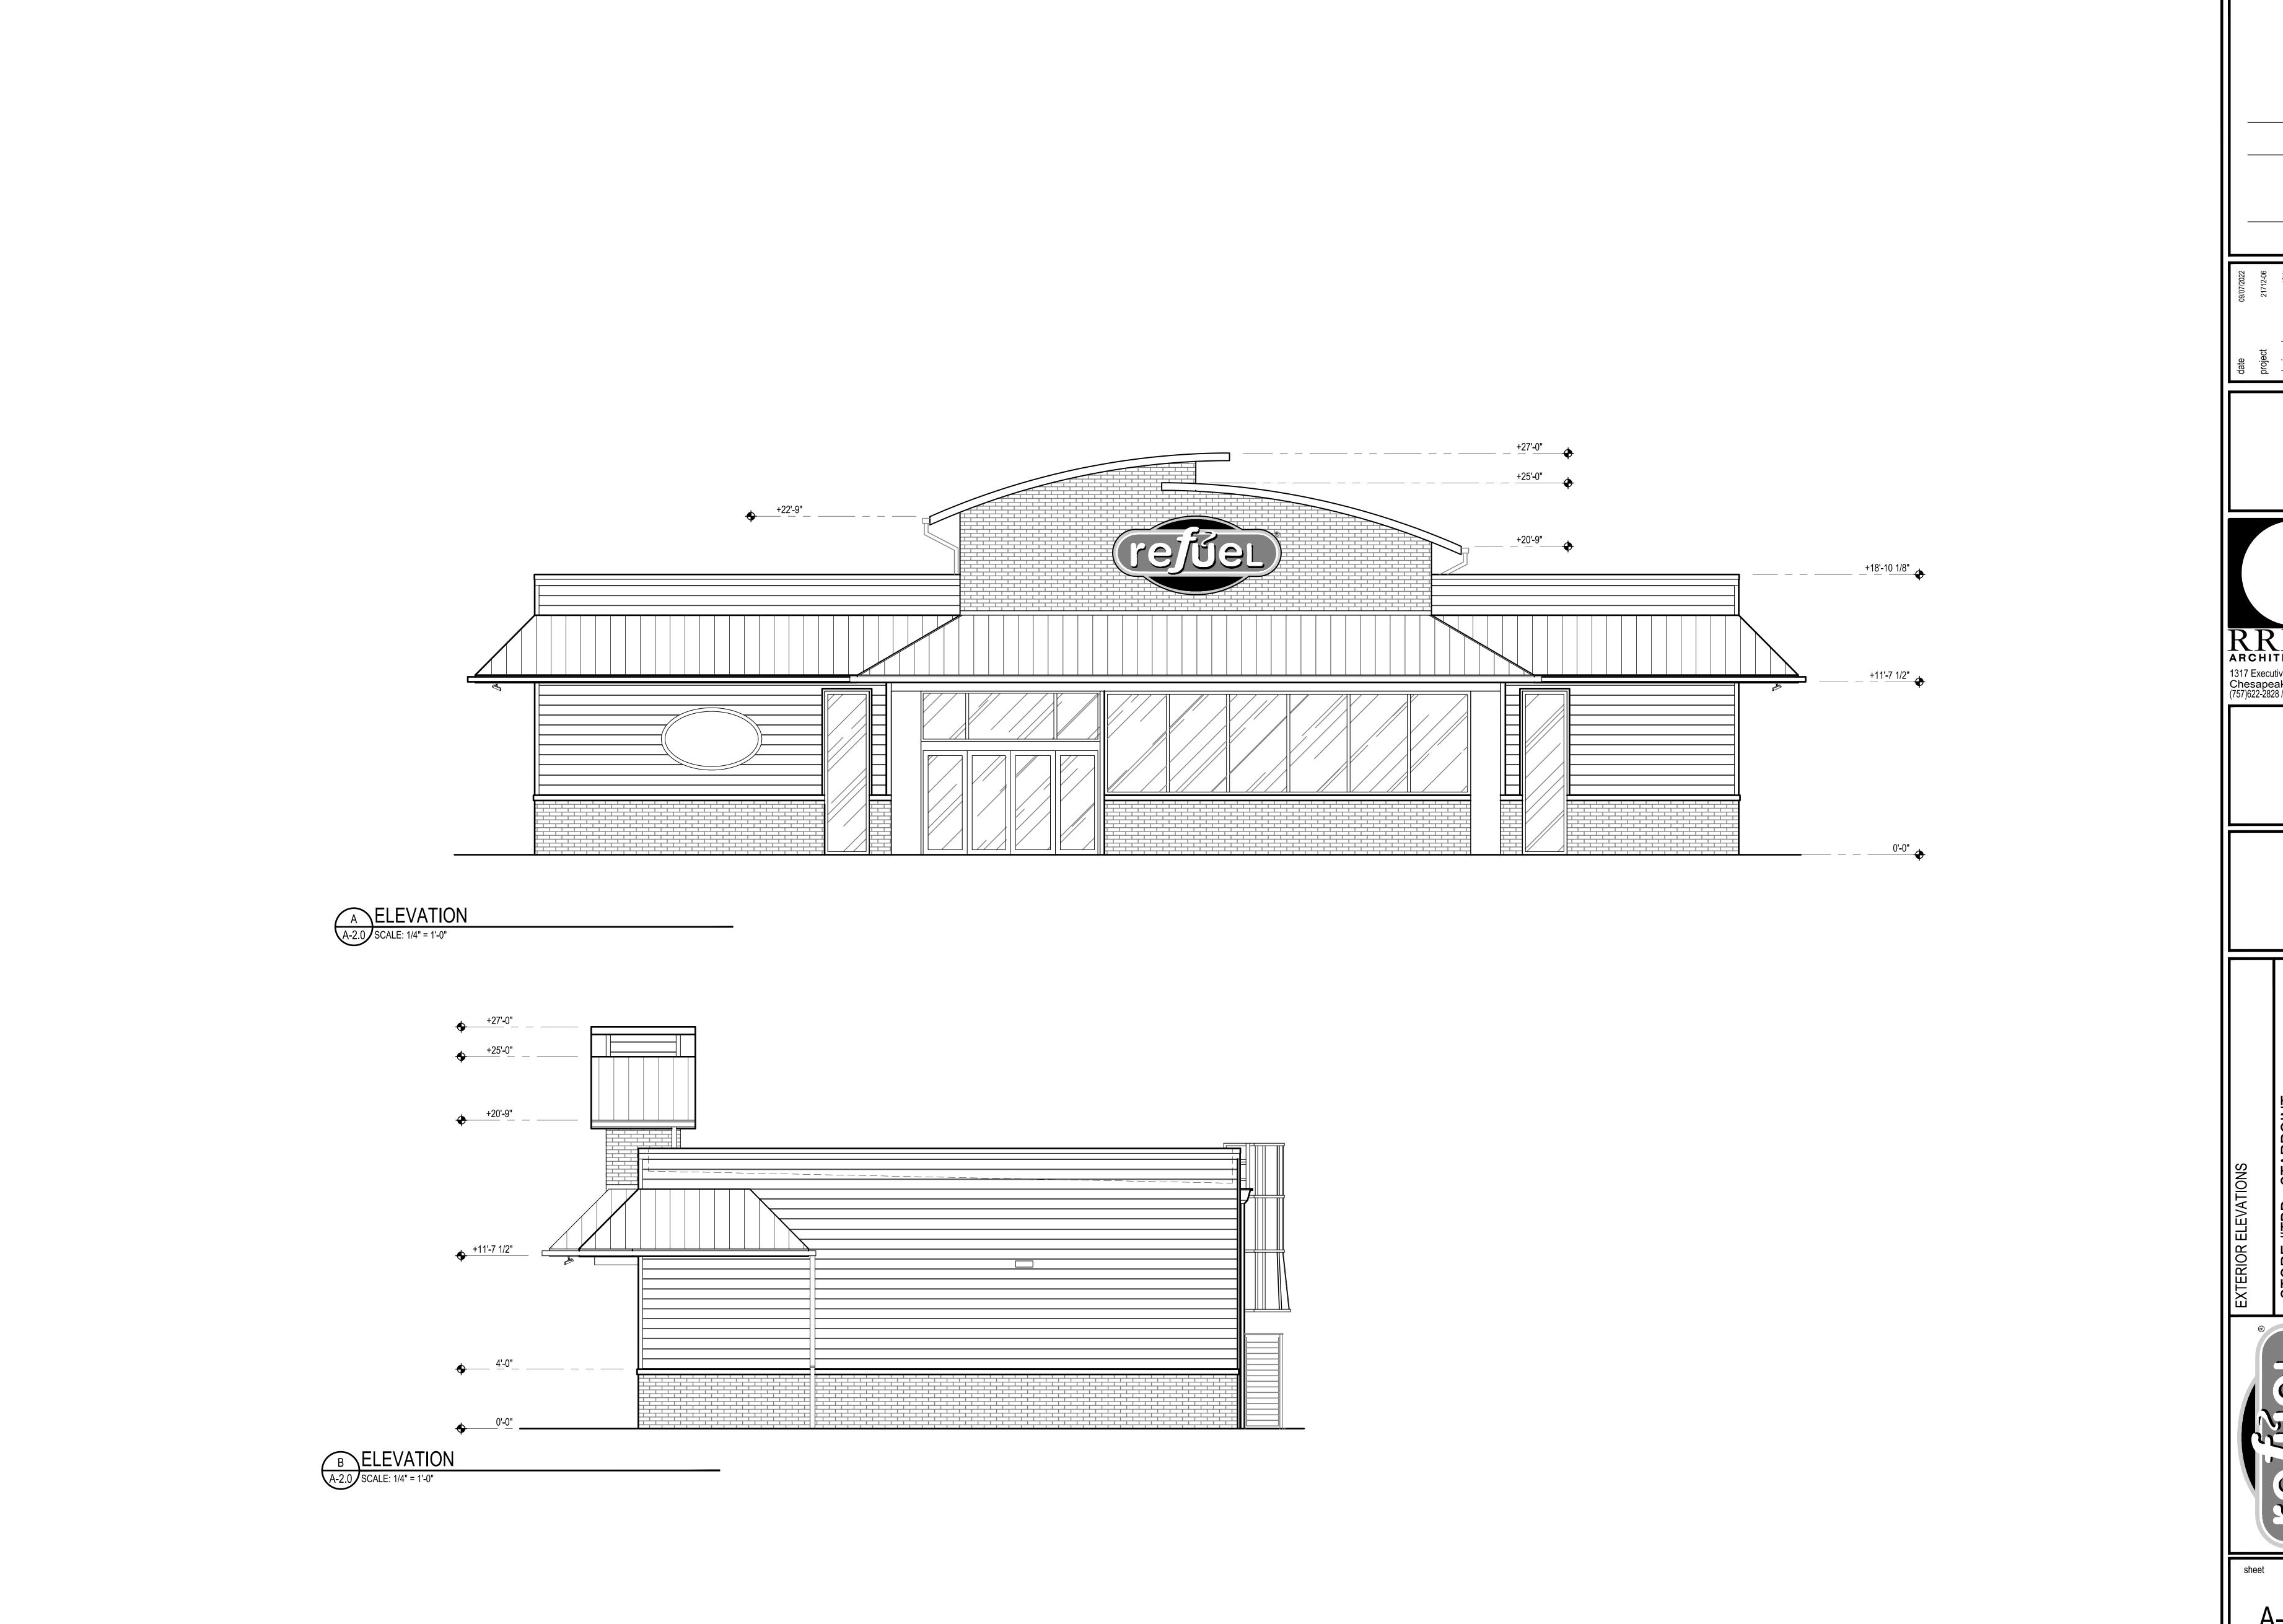

3/32"=1'-0"

1/8"=1'-0"

1/4"=1'-0"

3/8"=1'-0"

1/2"=1'-0"

0 6" 1' 2' 3/4"=1'-0"

3"=1'-0"


6"=1'-0"



Chesapeake, VA 23320 (757)622-2828 / fax (757)622-6883



A-2.0

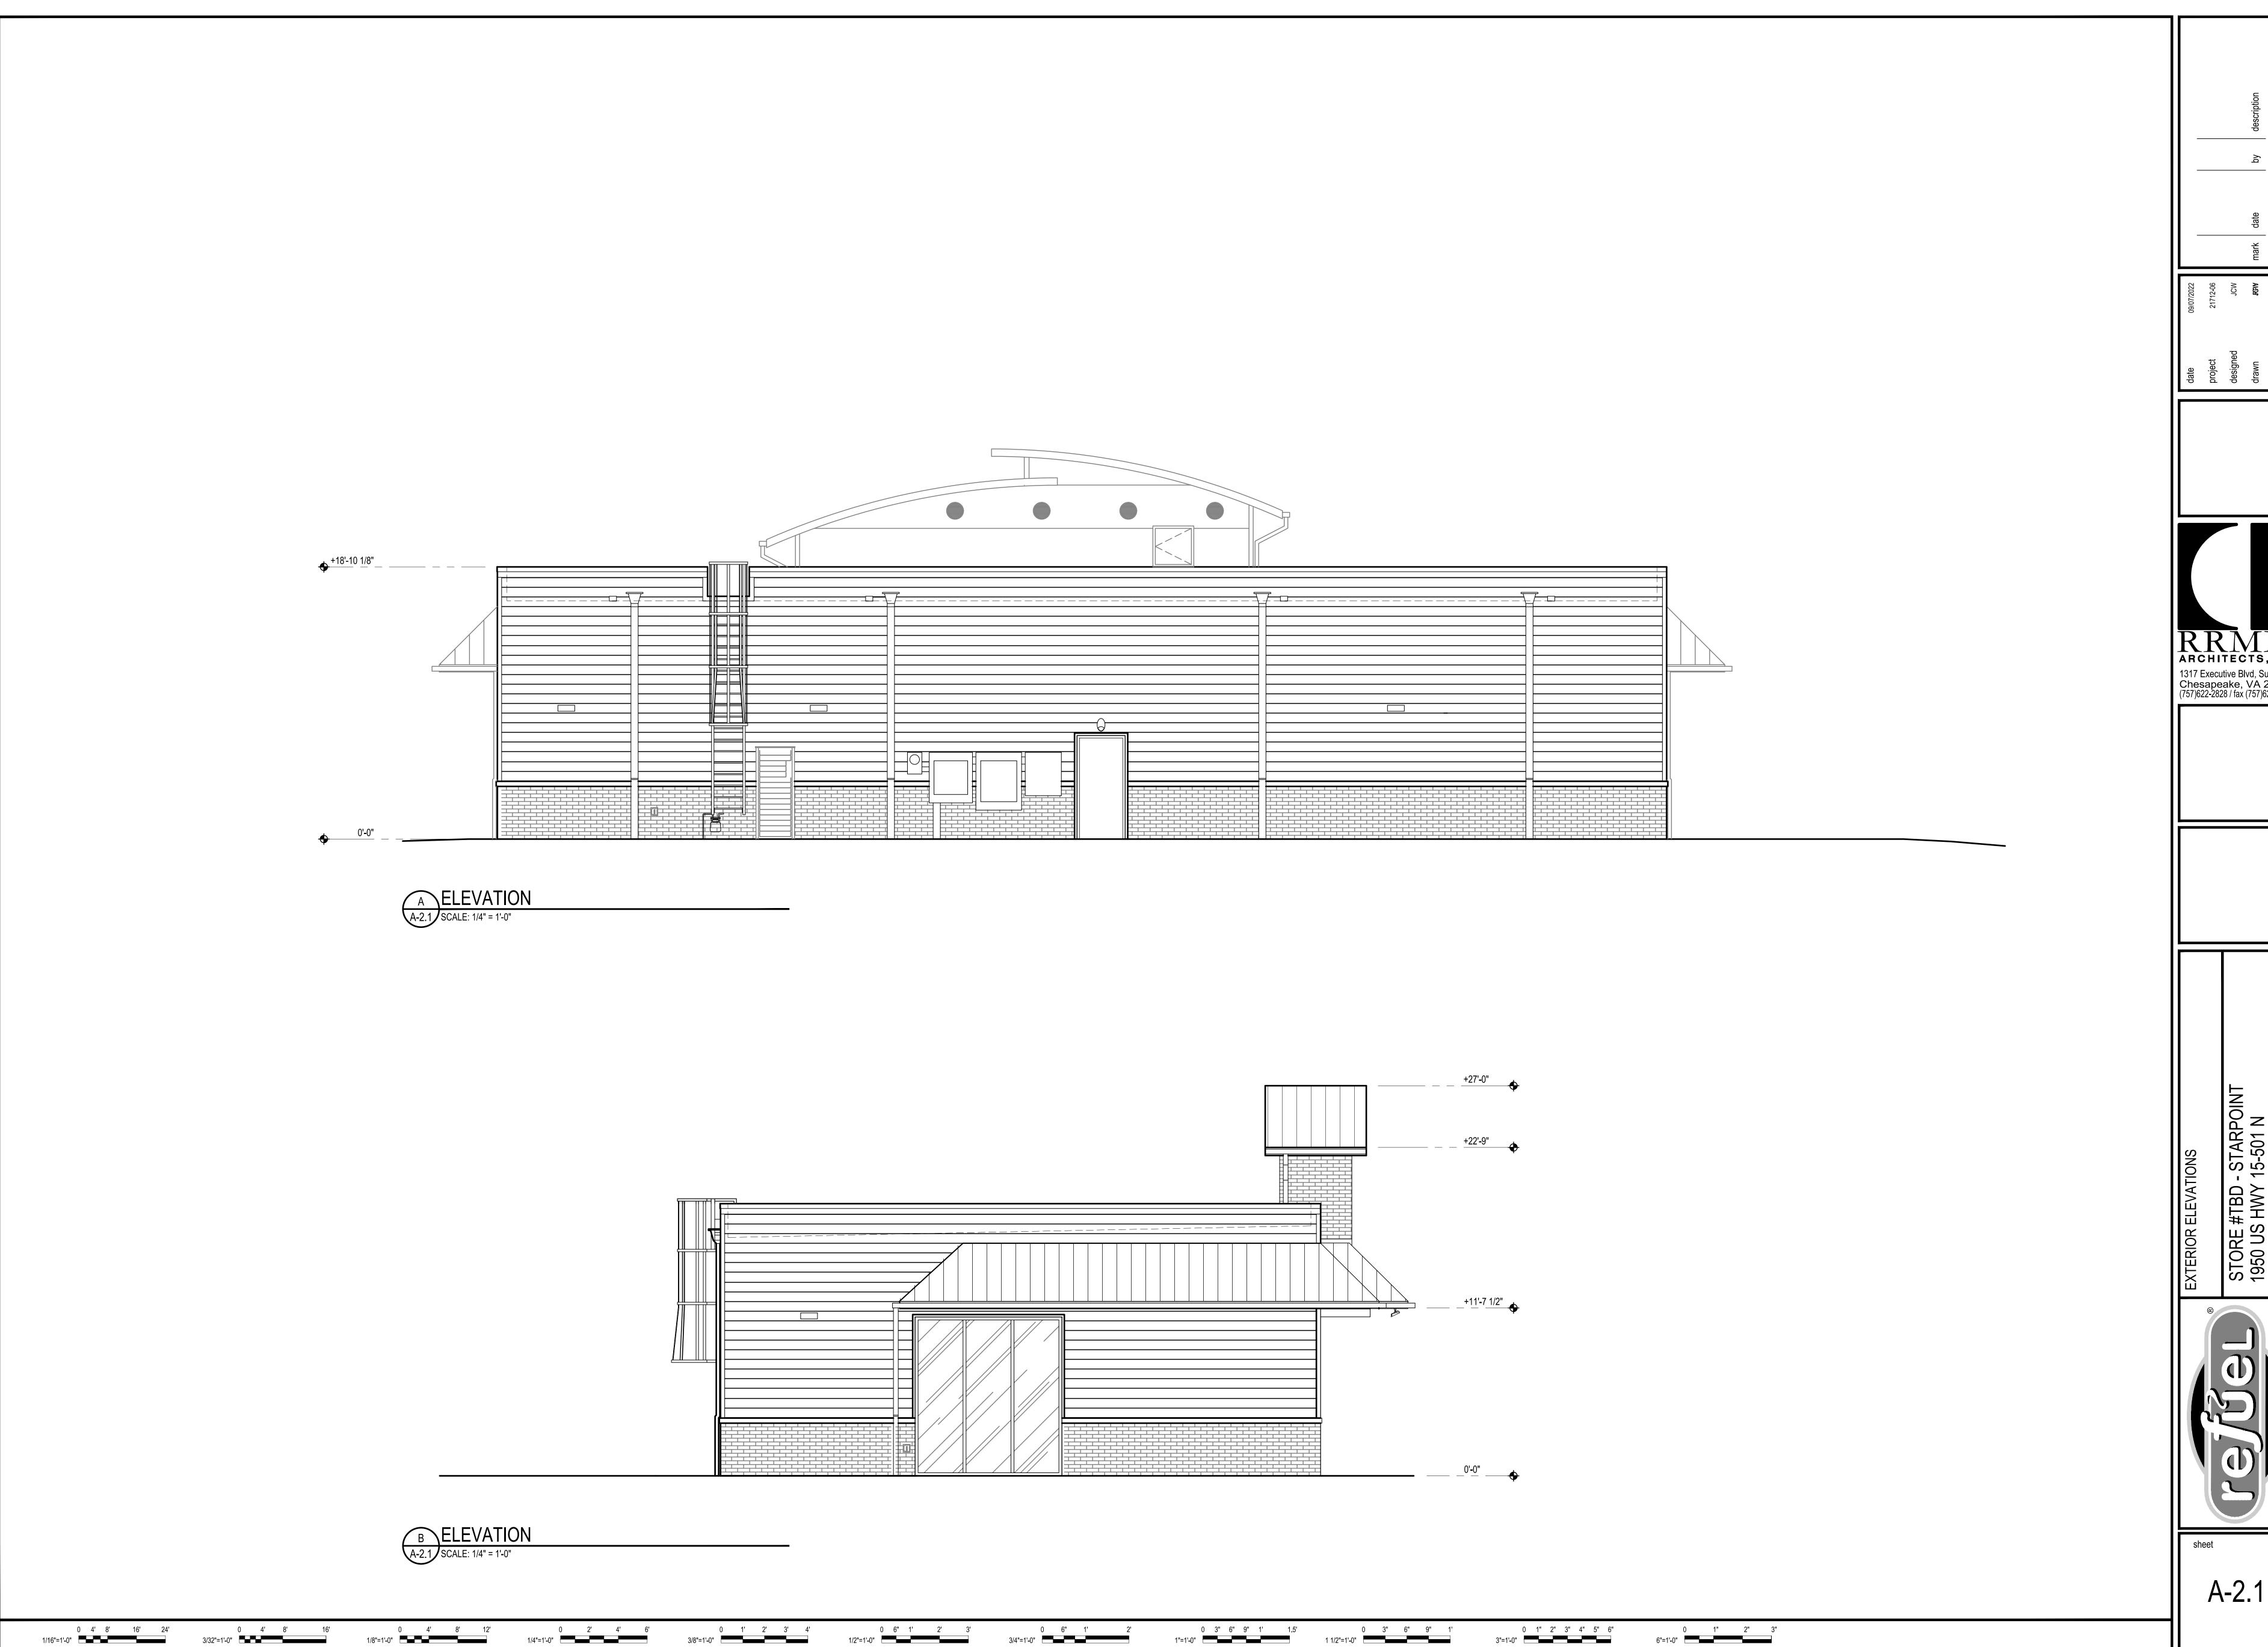



Chesapeake, VA 23320 (757)622-2828 / fax (757)622-6883

