

J:\30773\30773.0001\30773.0001\DRAWINGS\COND ZONING\30773.0001_CST.DWG - 09/26/2023 - 14:04




CONDITIONAL ZONING OF GATEWAY

PREPARED FOR:
NORTHVIEW PARTNERS
6131 FALLS OF THE NEUSE ROAD
SUITE 202
RALEIGH, NC 27609

J-30773.0001

PRELIMINARY, NOT
FOR CONSTRUCTION

PREPARED BY:


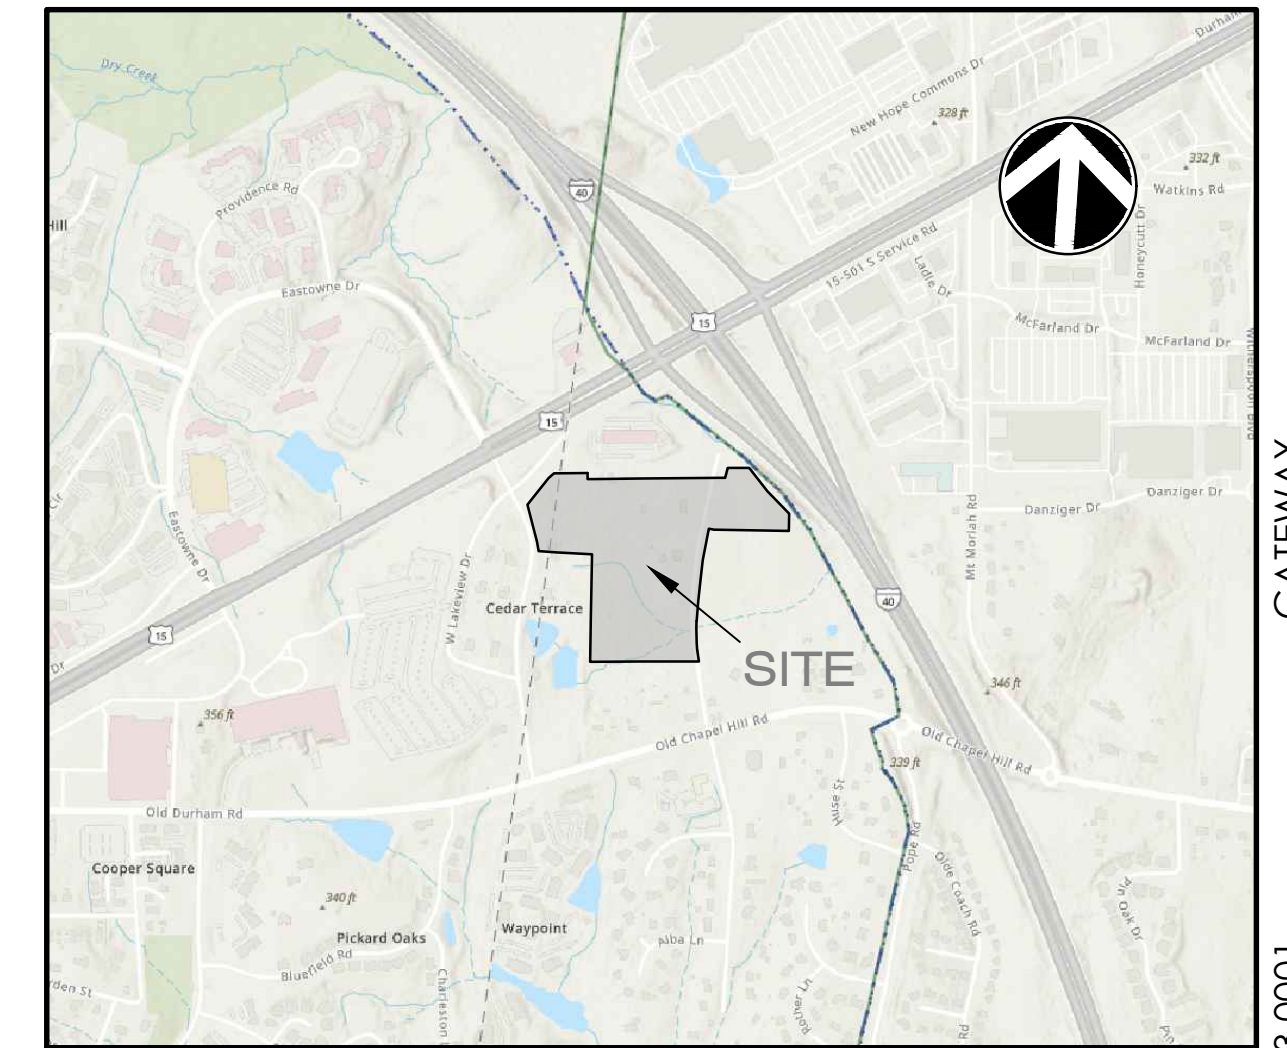


VICINITY MAP
NOT TO SCALE

J-30773.0001

REVISION HISTORY			
REV. NO.	REVISION	BY	DATE
3	SUBMITTAL #4	T&H	9/20/2023
2	SUBMITTAL #3	T&H	9/1/2023
1	SUBMITTAL #2	T&H	7/31/2023
	INITIAL SUBMITTAL	T&H	6/8/2023



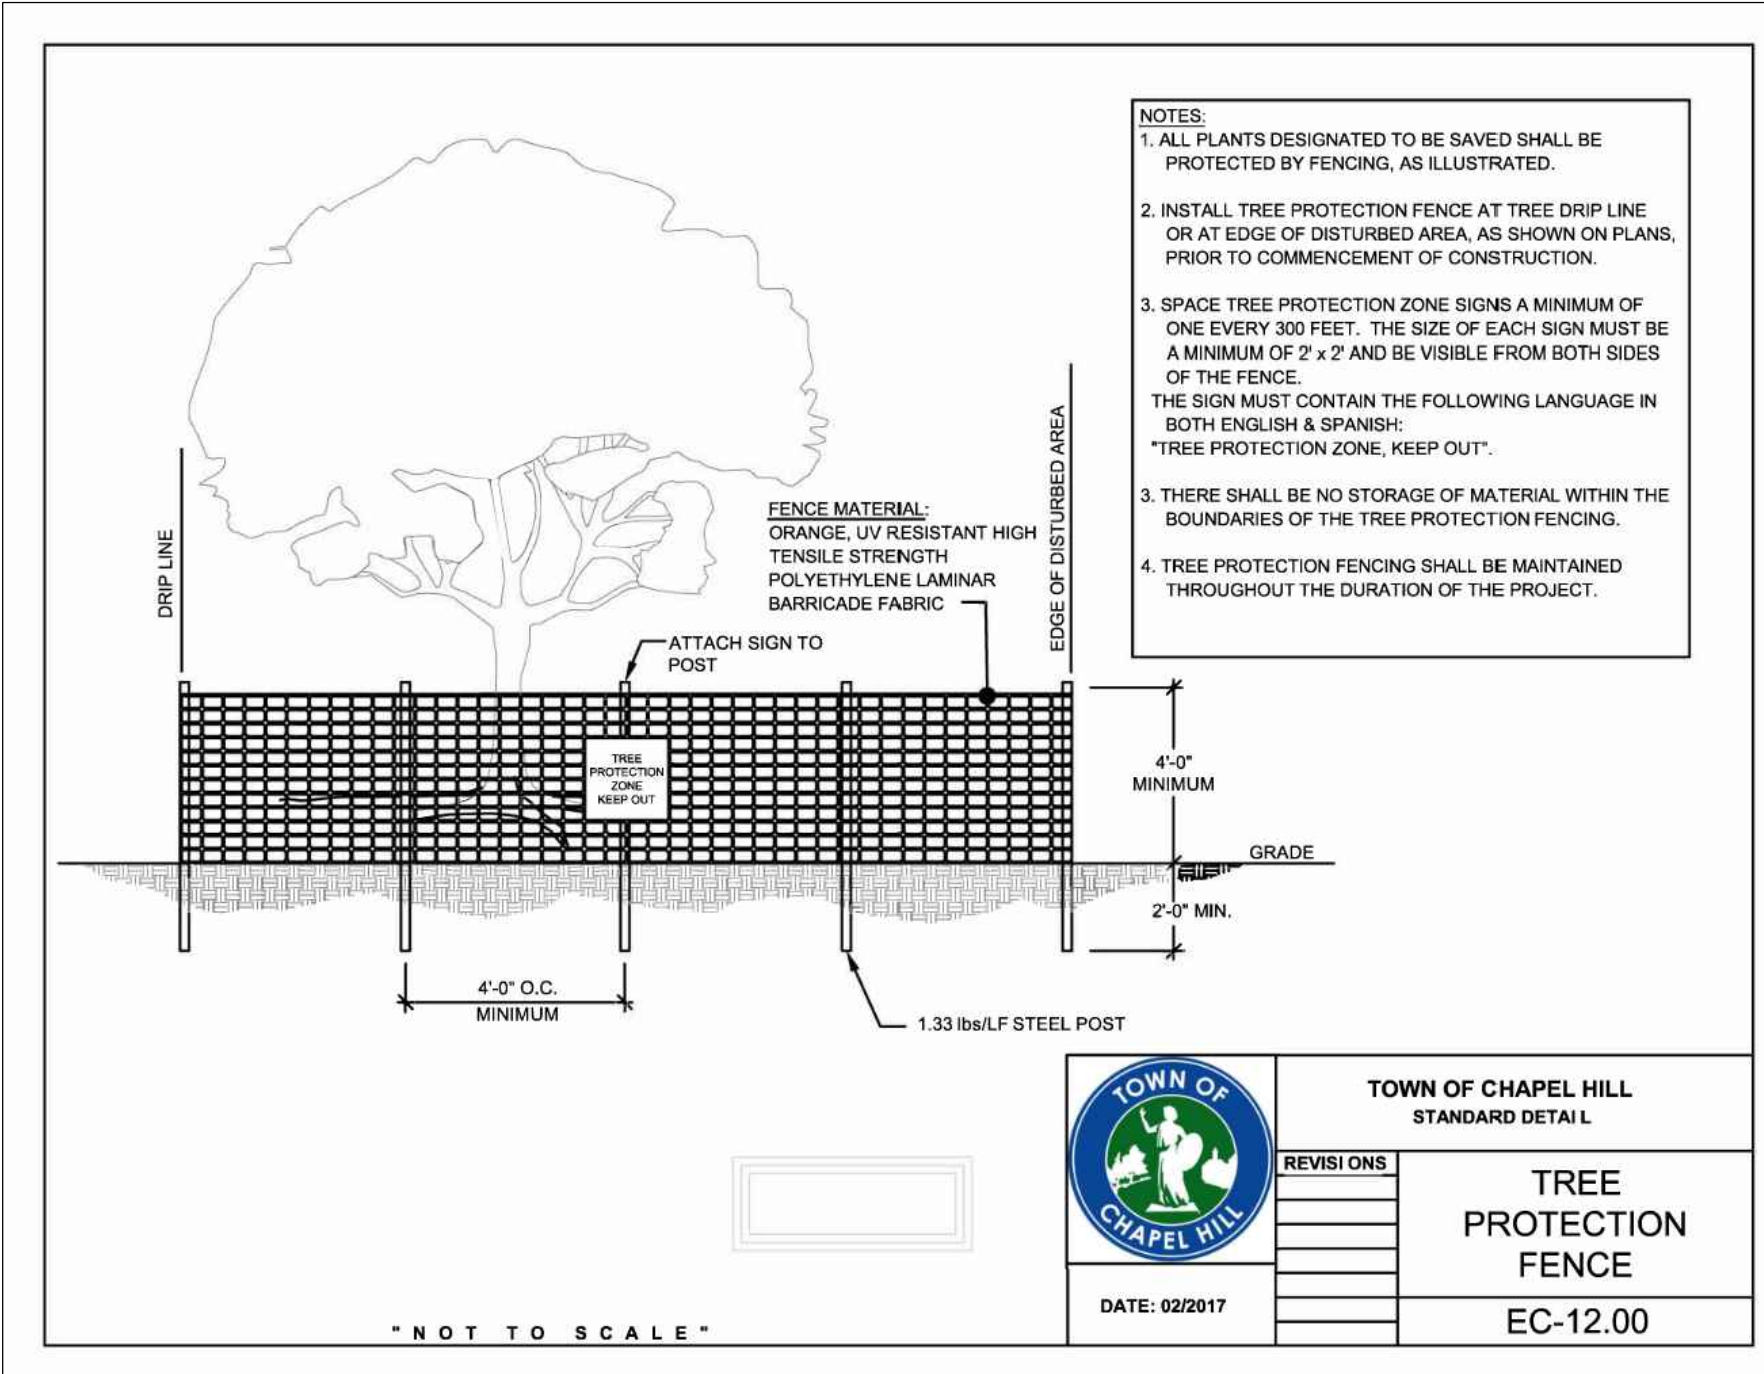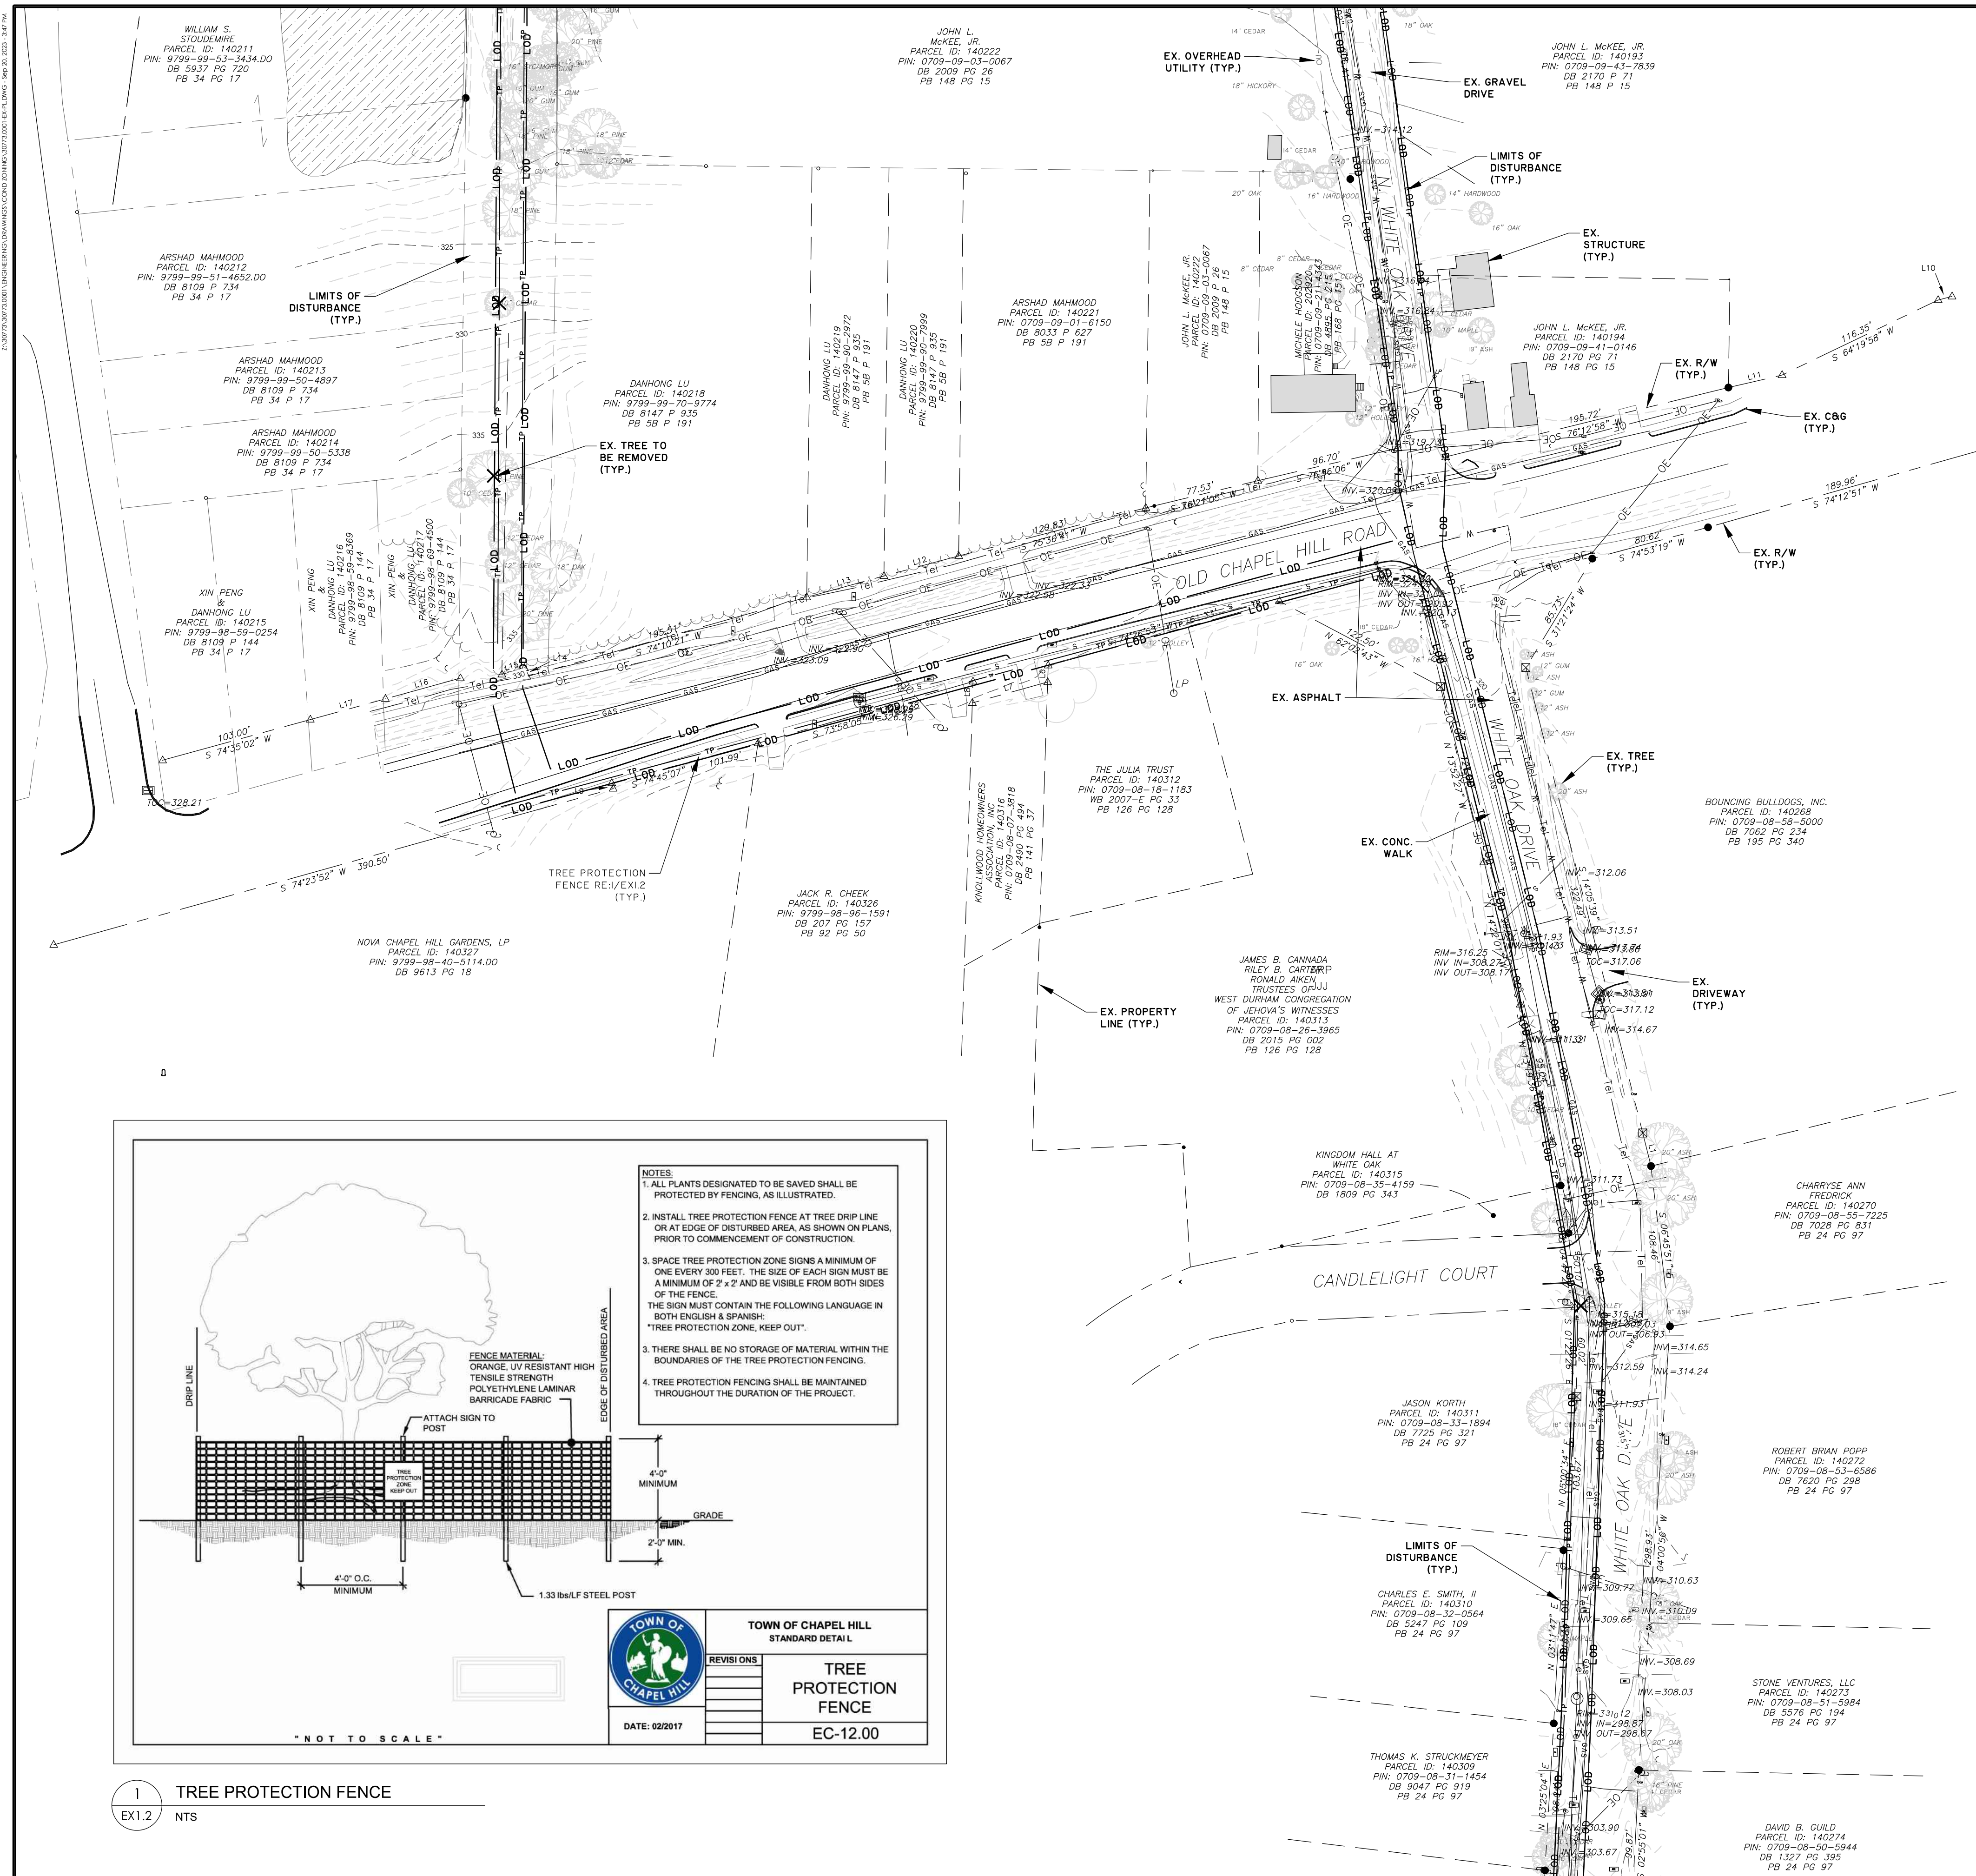

- NOTES:**
1. ALL PLANTS DESIGNATED TO BE SAVED SHALL BE PROTECTED BY FENCING, AS ILLUSTRATED.
 2. INSTALL TREE PROTECTION FENCE AT TREE DRIP LINE OR AT EDGE OF DISTURBED AREA AS SHOWN ON PLANS, PRIOR TO COMMENCEMENT OF CONSTRUCTION.
 3. SPACE TREE PROTECTION ZONE SIGNS A MINIMUM OF ONE EVERY 300 FEET. THE SIZE OF EACH SIGN MUST BE A MINIMUM OF 2' x 2' AND BE VISIBLE FROM BOTH SIDES OF THE FENCE. THE SIGN MUST CONTAIN THE FOLLOWING LANGUAGE IN BOTH ENGLISH & SPANISH: "TREE PROTECTION ZONE, KEEP OUT".
 3. THERE SHALL BE NO STORAGE OF MATERIAL WITHIN THE BOUNDARIES OF THE TREE PROTECTION FENCING.
 4. TREE PROTECTION FENCING SHALL BE MAINTAINED THROUGHOUT THE DURATION OF THE PROJECT.

TOWN OF CHAPEL HILL
STANDARD DETAIL


TREE PROTECTION FENCE
EC-12.00

REVISIONS

DATE: 02/2017

1 TREE PROTECTION FENCE
EX1.2 NTS

NO.	REVISIONS	BY	DATE
3	SUBMITTAL #4	T&H	9/20/2023
2	SUBMITTAL #3	T&H	9/1/2023
1	SUBMITTAL #2	T&H	7/31/2023
	INITIAL SUBMITTAL	T&H	6/8/2023

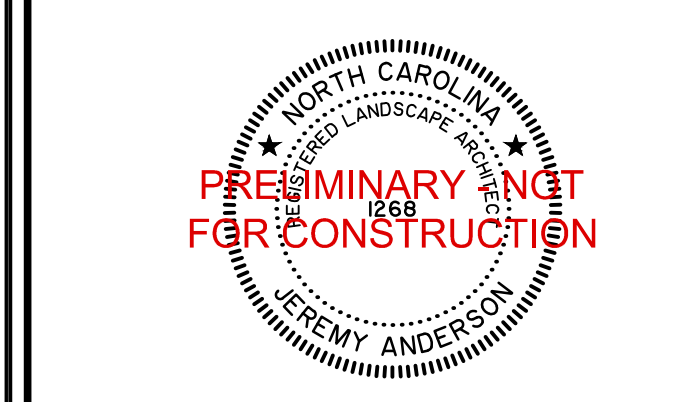

THOMAS & HUTTON


111 W. MAIN STREET
DURHAM, NC 27701
919.682.0368
www.thomasandhutton.com

EXISTING CONDITIONS PLAN

GATEWAY

PROJECT LOCATION:
East Lakeview Drive
Chapel Hill, NC

CLIENT/OWNER:
NorthView Partners

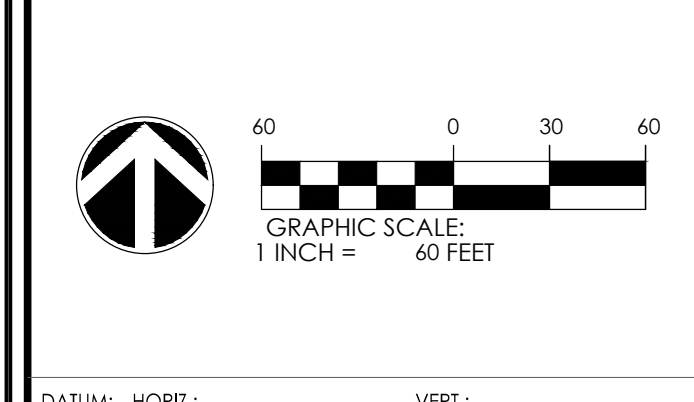

DATUM: HORIZ. VERT.:

JOB NO: 30773.0001

DATE:

DRAWN: AMO, JSA, MIC

DESIGNED: AMO

REVIEWED: AMO, JSA

APPROVED:

SCALE: 1" = 60'

EX1.2



DISTURBANCES & IMPERVIOUS SURFACES

RESOURCE CONSERVATION DISTRICT (RCD) ZONE

ZONE	AREA ON-SITE (SF)	AREA OF DISTURBANCE (SF)	RATIO OF AREA DISTURBED (%)	IMPERVIOUS SURFACE (SF)	RATIO OF IMPERVIOUS SURFACE (%)
STREAMSIDE	6,921	6,921	100%	2,726	39.39%


JORDAN BUFFER DISTURBANCE

IMPACT LOCATION	AREA OF DISTURBANCE (SF)
LINEAR IMPACT	N/A
ZONE 1 IMPACT	1,560
ZONE 2 IMPACT	2,687


SLOPE KEY

- 0% TO 10% SLOPES (NOT HATCHED) = 629,512 SF (623,759 SF TO BE DISTURBED)
- 10% TO 15% SLOPES = 26,992 SF (26,922 SF TO BE DISTURBED)
- 15% TO 25% SLOPES = 6,703 SF (6,703 SF TO BE DISTURBED)
- 25% AND STEEPER SLOPES = 0 SF (0 SF TO BE DISTURBED)

OVERALL ON-SITE DISTURBED AREA = 661,724 SF

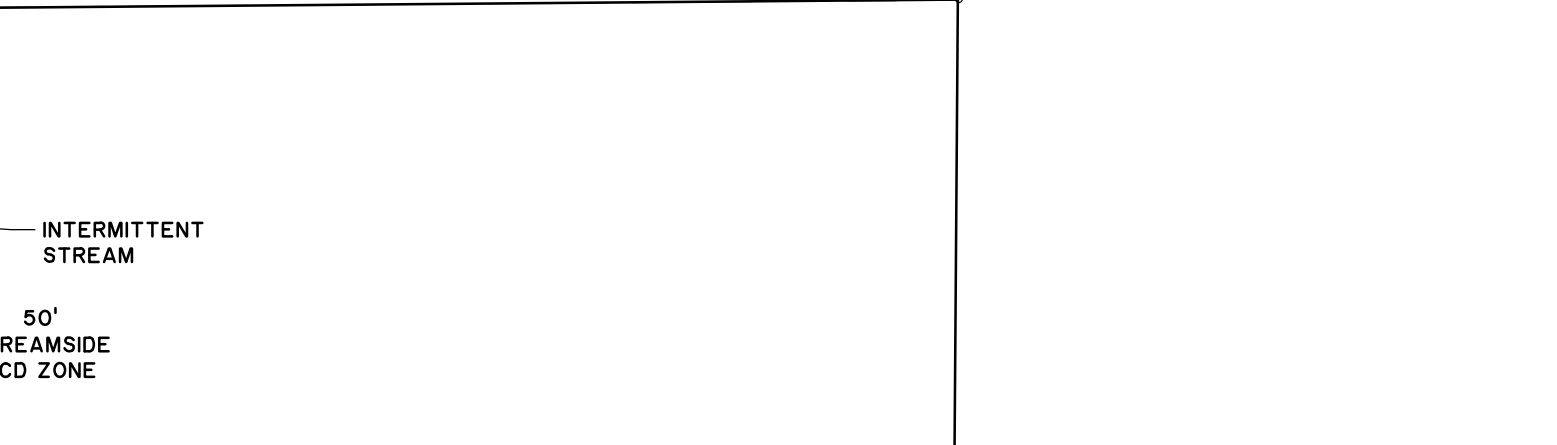

NO.	REVISIONS	BY	DATE
3	SUBMITTAL #4	T&H	9/20/2023
2	SUBMITTAL #3	T&H	9/1/2023
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	INITIAL SUBMITTAL	T&H	6/8/2023

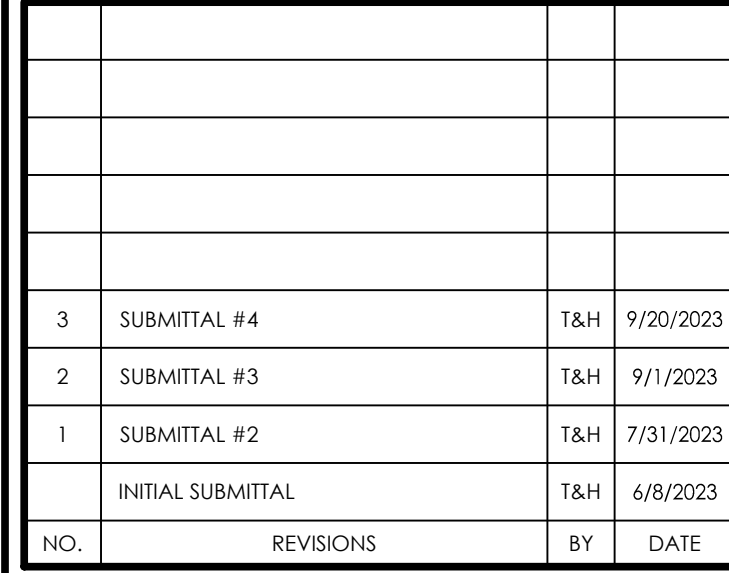

THOMAS & HUTTON


111 W. MAIN STREET
DURHAM, NC 27701
919.682.0368
www.thomasandhutton.com

STEEP SLOPE PLAN

GATEWAY

PROJECT LOCATION:
East Lakeview Drive
Chapel Hill, NC

CLIENT/OWNER:
NorthView Partners

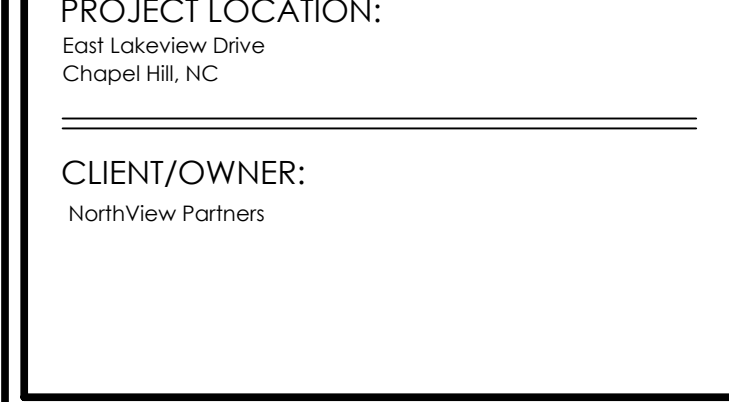

DATUM: HORIZ. VERT.:


JOB NO: 30773.0001

DATE: DRAWN: AMO, JSA

DESIGNED: REVIEWED: APPROVED:

SCALE: 1" = 60'

EX1.3

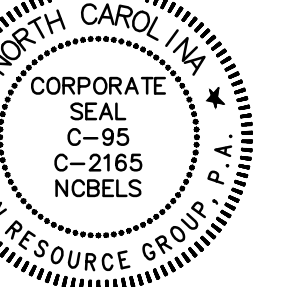


REZONING

GATEWAY
APARTMENTS
CHAPEL HILL, NORTH CAROLINA

NORTHVIEW PARTNERS
6131 FALLS OF NEUSE ROAD, SUITE 202
RALEIGH, NORTH CAROLINA 27609


SITE PLAN

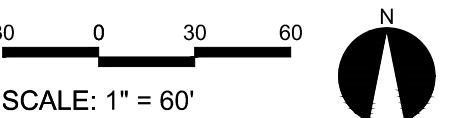

PROJECT #: 443-023
DRAWN BY: JO
CHECKED BY: SK

JUNE 8, 2023

REVISIONS:

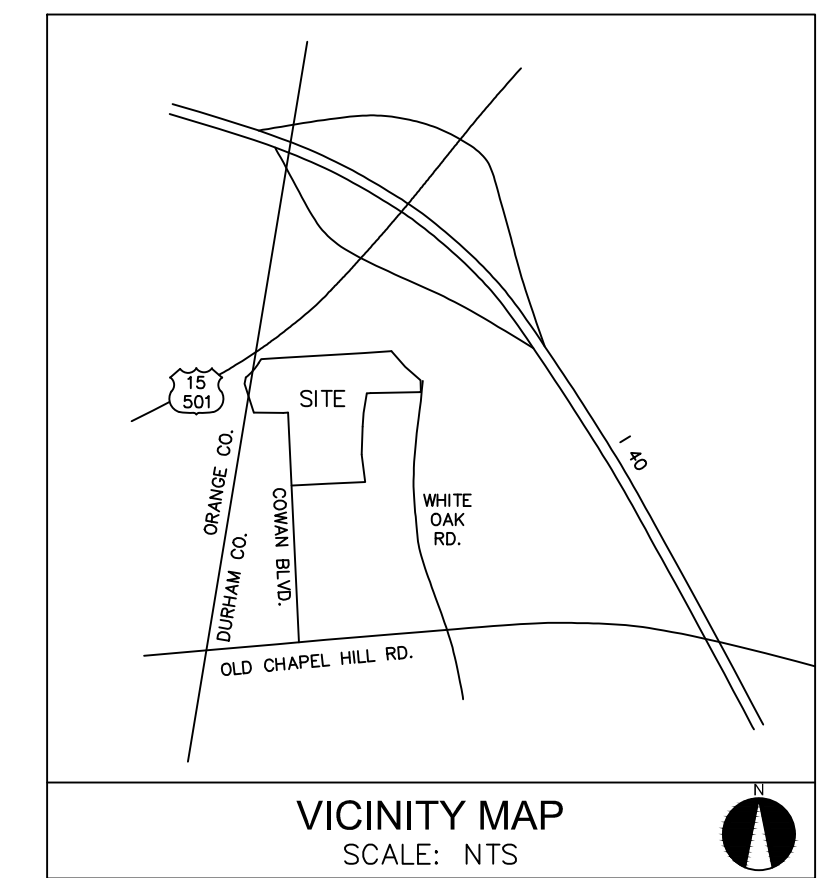

SITE DATA

TAX MAP NO. —
ORANGE COUNTY:
DURHAM COUNTY:

9890-90-4183, 9799-99-4937, 9799-99-4931
9890-90-52-6125.DD, 9890-90-50-7784.DD,
9890-90-50-8052.DD, 9890-90-81-4582,
9799-99-88-4004, 9799-99-85-3851,
9799-99-84-3831, 0709-09-05-9350,
0709-09-06-9881, 0709-09-18-0371,
0800-00-10-2025, 0800-00-11-3370,
0800-12-12-4064, 0800-00-12-5860,
0800-00-41-8958

EXISTING ZONING:
PROPOSED ZONING:

R-1
R-6

LAND AREA:
NET LAND AREA:
10% OF NET LAND AREA:
GROSS LAND AREA:

15.375 AC (669,759 SF)
13.354 AC (583,048 SF)
1.338 AC (58,305 SF)
14.723 AC (641,353 SF)

LAND DISTURBANCE:
IMPERVIOUS AREA:

19.007 AC (827,974 SF)
388,802 SF

PROPOSED USE:

DWELLING UNITS, MULTIFAMILY OVER 7 DWELLING UNITS

PROPOSED UNITS:

316 APARTMENT UNITS
(19) STUDIO UNITS (6%)
(158) 1 BEDROOM UNITS (50%)
(107) 2 BEDROOM UNITS (34%)
(32) 3 BEDROOM UNITS (10%)
72 SENIOR APARTMENT UNITS
(57) 1 BEDROOM UNITS (79%)
(15) 2 BEDROOM UNITS (21%)
TOTAL = 388 UNITS

PROPOSED FLOOR AREA:

BUILDING #1 = 91,904 GSF
BUILDING #2 = 101,846 GSF
BUILDING #3 = 92,292 GSF
BUILDING #4 = 92,292 GSF
BUILDING #5 = 31,887 GSF
CLUBHOUSE = 12,630 GSF
TOTAL MF = 427,851 GSF
SENIORS MF = 73,630 GSF
OVERALL = 501,559 GSF

DENSITY:
FLOOR AREA RATIO (FAR):
PROPOSED FLOOR AREA RATIO:

25.24 DUA
0.303
0.78

PARKING REQUIRED —

APARTMENTS:

1 BEDROOM: 1 MIN.—1.25 MAX. = 177 MIN.—221 MAX.
2 BEDROOM: 1.4 MIN.—1.75 MAX. = 150 MIN.—187 MAX.
3 BEDROOM: 1.75 MIN.—2.25 MAX. = 56 MIN.—72 MAX.
= 383 MIN. — 480 MAX.
1 BEDROOM: 1 MIN.—1.25 MAX. = 57 MIN.—71 MAX.
2 BEDROOM: 1.4 MIN.—1.75 MAX. = 21 MIN.—26 MAX.
= 78 MIN. — 97 MAX.

PARKING PROVIDED —

MF APARTMENTS:

332 STANDARD SPACES (216 EVC)
14 EV SPACES (3.84%)
17 ACCESSIBLE SPACES
2 EV ACCESSIBLE SPACES (0.54%)
92 ON STREET SPACES
= 457 SPACES (1.45/UNIT)
40 STANDARD SPACES (40EVC)
2 EV SPACE (1.92%)
8 ACCESSIBLE SPACES
1 EV ACCESSIBLE SPACE (1.96%)
7 ON STREET SPACES
= 58 SPACES (0.80/UNIT)
TOTAL SPACES = 515 SPACES

NOTE:

— NOT ALL ON STREET PARKING TO COUNT
TOWARDS MINIMUM/MAXIMUM PARKING
— 3% MIN. OF ALL PARKING TO BE EV (16 SPACES MIN.)
— EV CAPABLE — MF APTS. — 216 EV CAPABLE
SENIOR APTS. — 40 EV CAPABLE
TOTAL — 256 EVC TO BE
CONVERTED FROM
STANDARD PARKING
SPACES

BICYCLE PARKING REQUIRED —

APARTMENTS:

1 SPACE / 4 DWELLING UNITS = 79 SPACES
10% SHORT TERM = 8 SPACES
90% LONG TERM = 71 SPACES
1 SPACE / 4 DWELLING UNITS = 18 SPACES
10% SHORT TERM = 2 SPACES
90% LONG TERM = 16 SPACES

SENIOR APARTMENTS:

BICYCLE PARKING PROVIDED —

APARTMENTS:

79 SPACES; 4 SHORT TERM RACKS (8 SPACES) +
BIKE STRUCTURE & INTERNAL BIKE SPACES
(SEE ARCHITECTURAL)
16 SPACES; 1 SHORT TERM RACKS (2 SPACES) +
BIKE STRUCTURE & INTERNAL BIKE SPACES
(SEE ARCHITECTURAL)

SENIOR APARTMENTS:

TREE PRESERVATION REQUIRED:

TREE PRESERVATION PROVIDED:

30%
SEE SHEET L1.0 & L1.1 FOR FURTHER DETAIL

RECREATIONAL SPACE REQUIRED:

RECREATIONAL SPACE PROVIDED:

MULTIFAMILY RATIO: 0.05 = 14.723 AC
SEE SHEET C1.1 FOR FURTHER DETAIL

STREET SETBACK:


INTERIOR SETBACK:

BUILDING HEIGHT ALLOWED:


20'


6'

65' @ SETBACK, 60' @ CORE

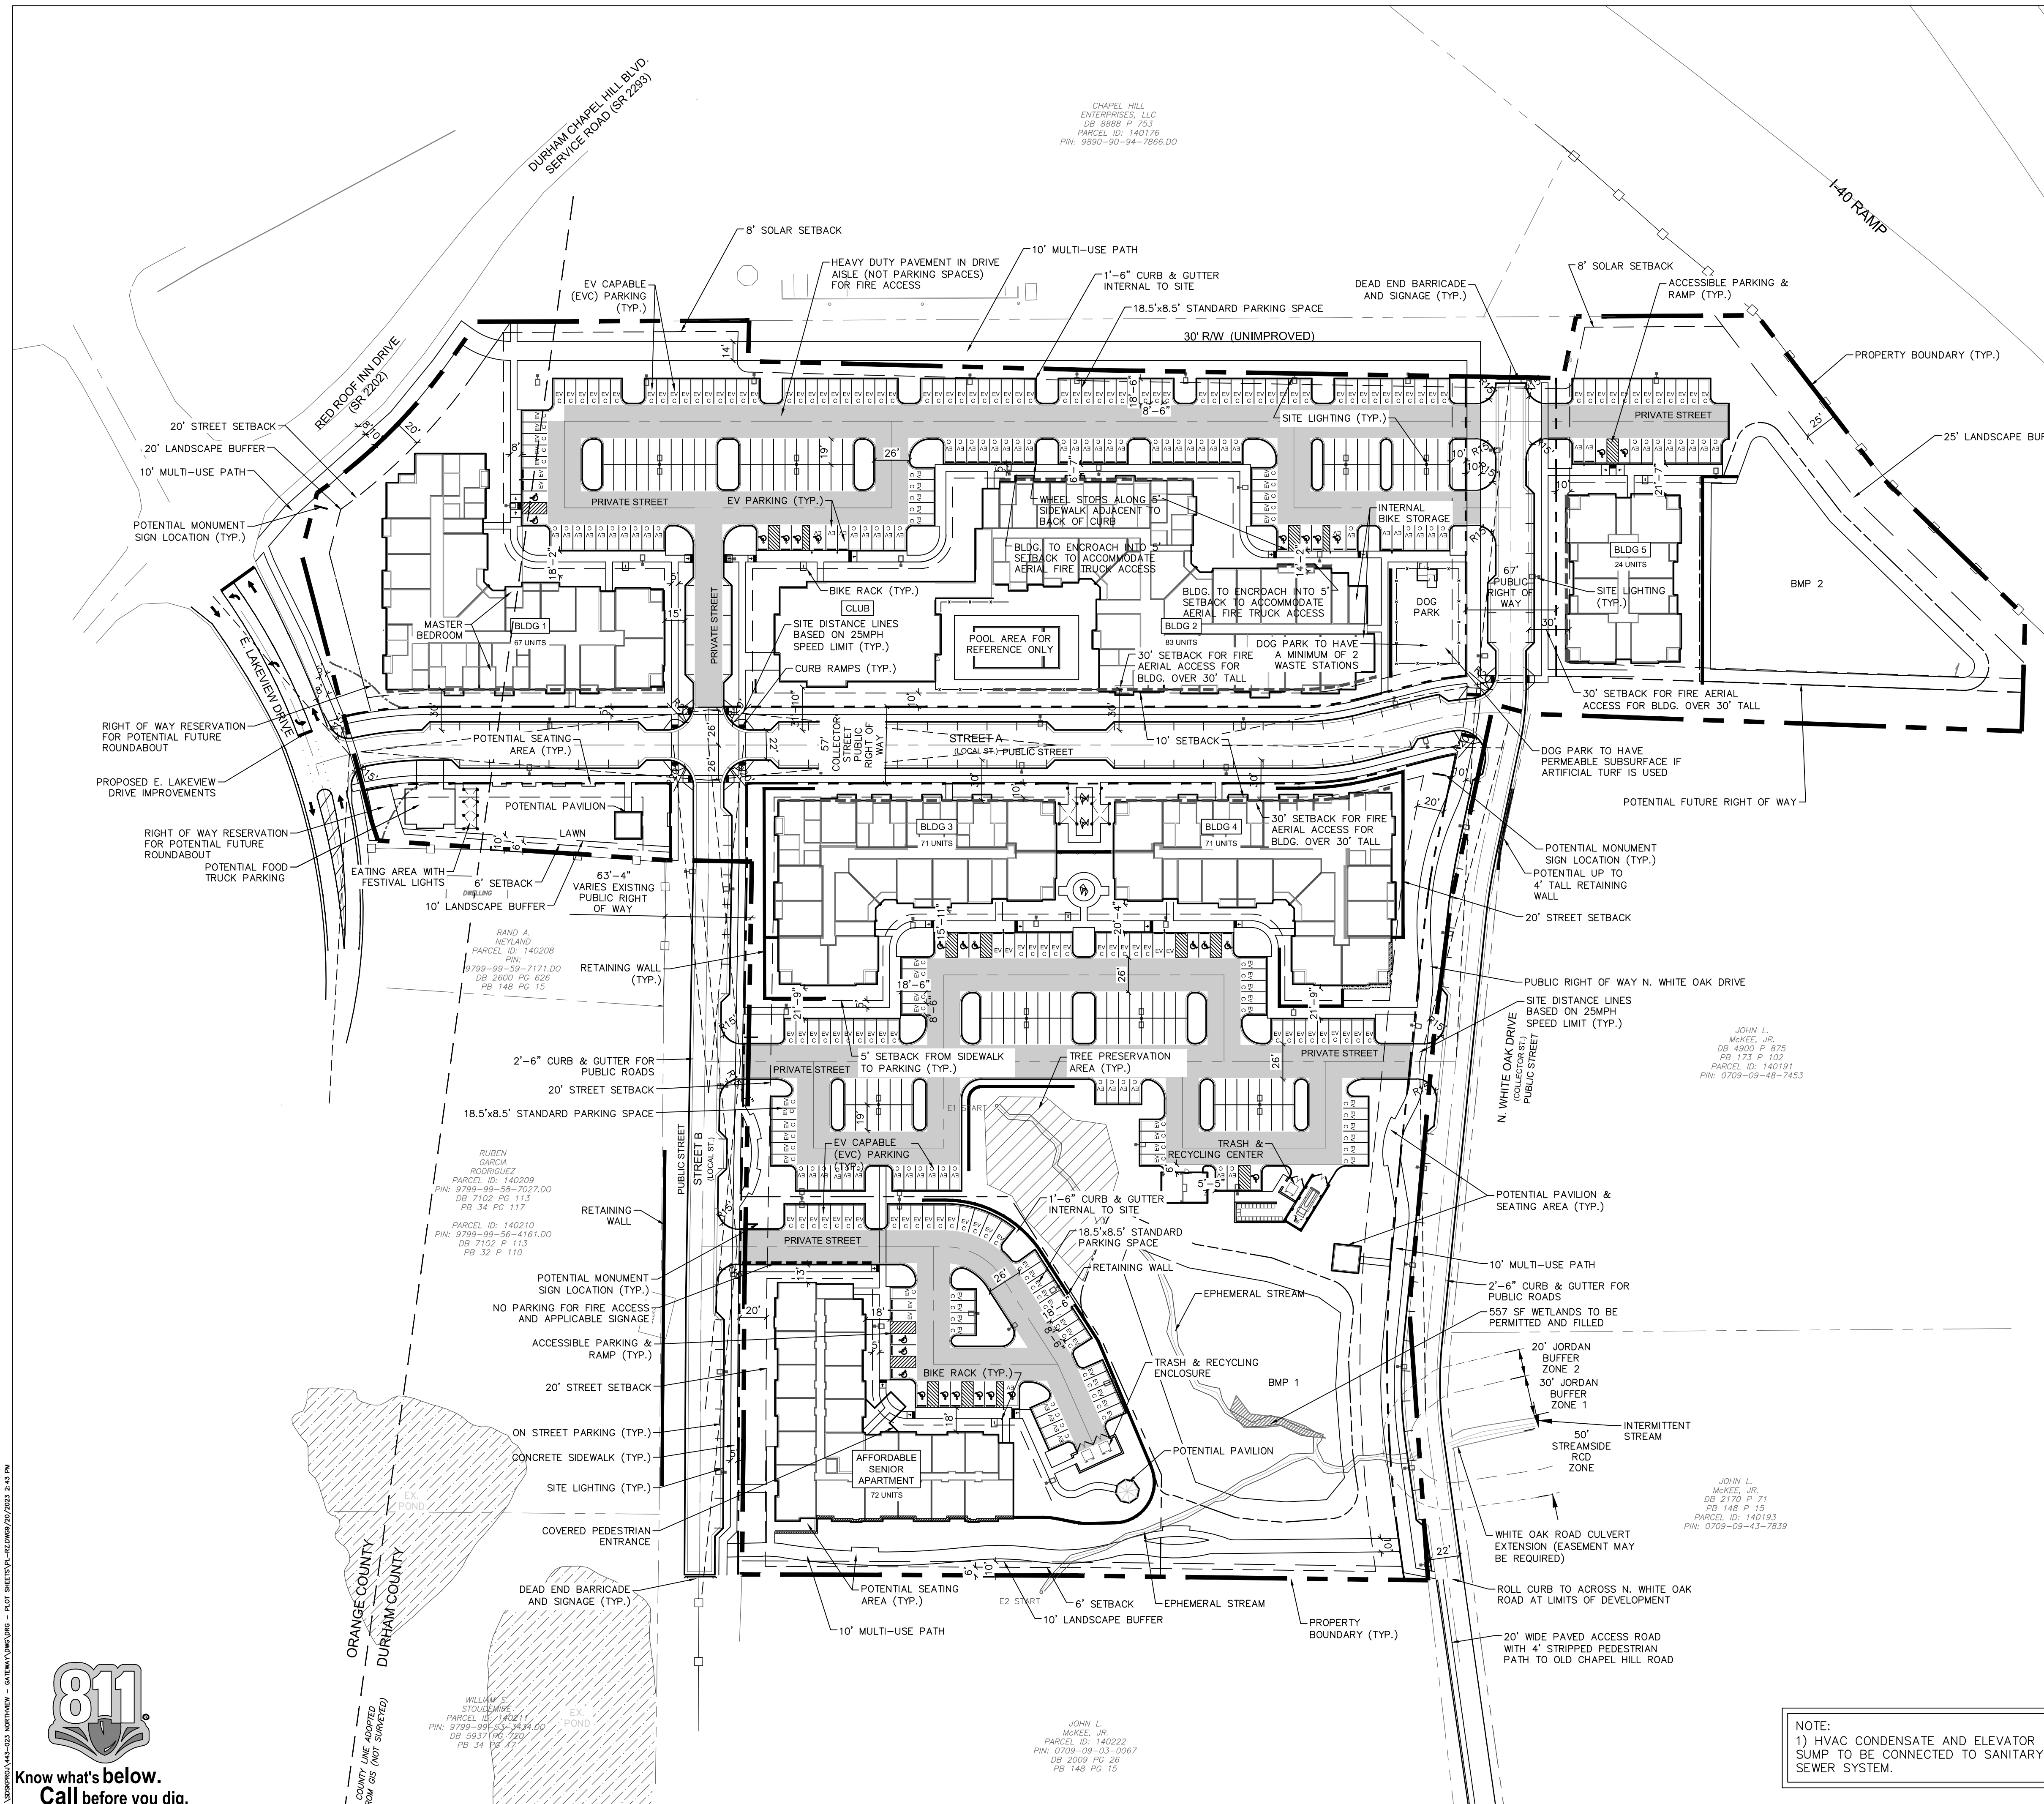

NOTE:
1) HVAC CONDENSATE AND ELEVATOR
SUMP TO BE CONNECTED TO SANITARY
SEWER SYSTEM.

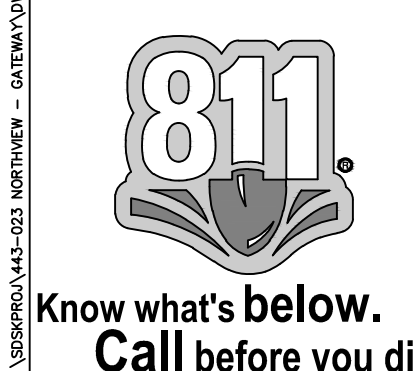

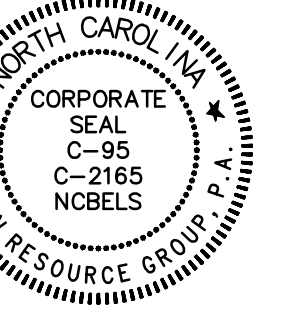


REZONING

GATEWAY APARTMENTS
 CHAPEL HILL, NORTH CAROLINA

NORTHVIEW PARTNERS
 6131 FALLS OF NEUSE ROAD, SUITE 202
 RALEIGH, NORTH CAROLINA 27609

OPEN SPACE PLAN

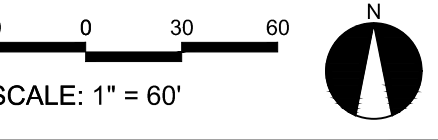


PROJECT #: 443-023
 DRAWN BY: JO
 CHECKED BY: SK

JUNE 8, 2023

REVISIONS:

RECREATIONAL OPEN SPACE

NET SITE AREA:	641,353 SF (14.723 AC)
MULTIFAMILY RATIO: 0.050	
RECREATIONAL OPEN SPACE REQUIRED:	641,353 X 0.05 = 32,068 SF (0.736 AC)
RECREATIONAL OPEN SPACE PROVIDED:	GREENWAY PATHS = 26,296 SF (0.60 AC)
	LAWN / PARK = 10,115 SF (0.23 AC)
	TOTAL = 36,411 SF (0.83 AC)

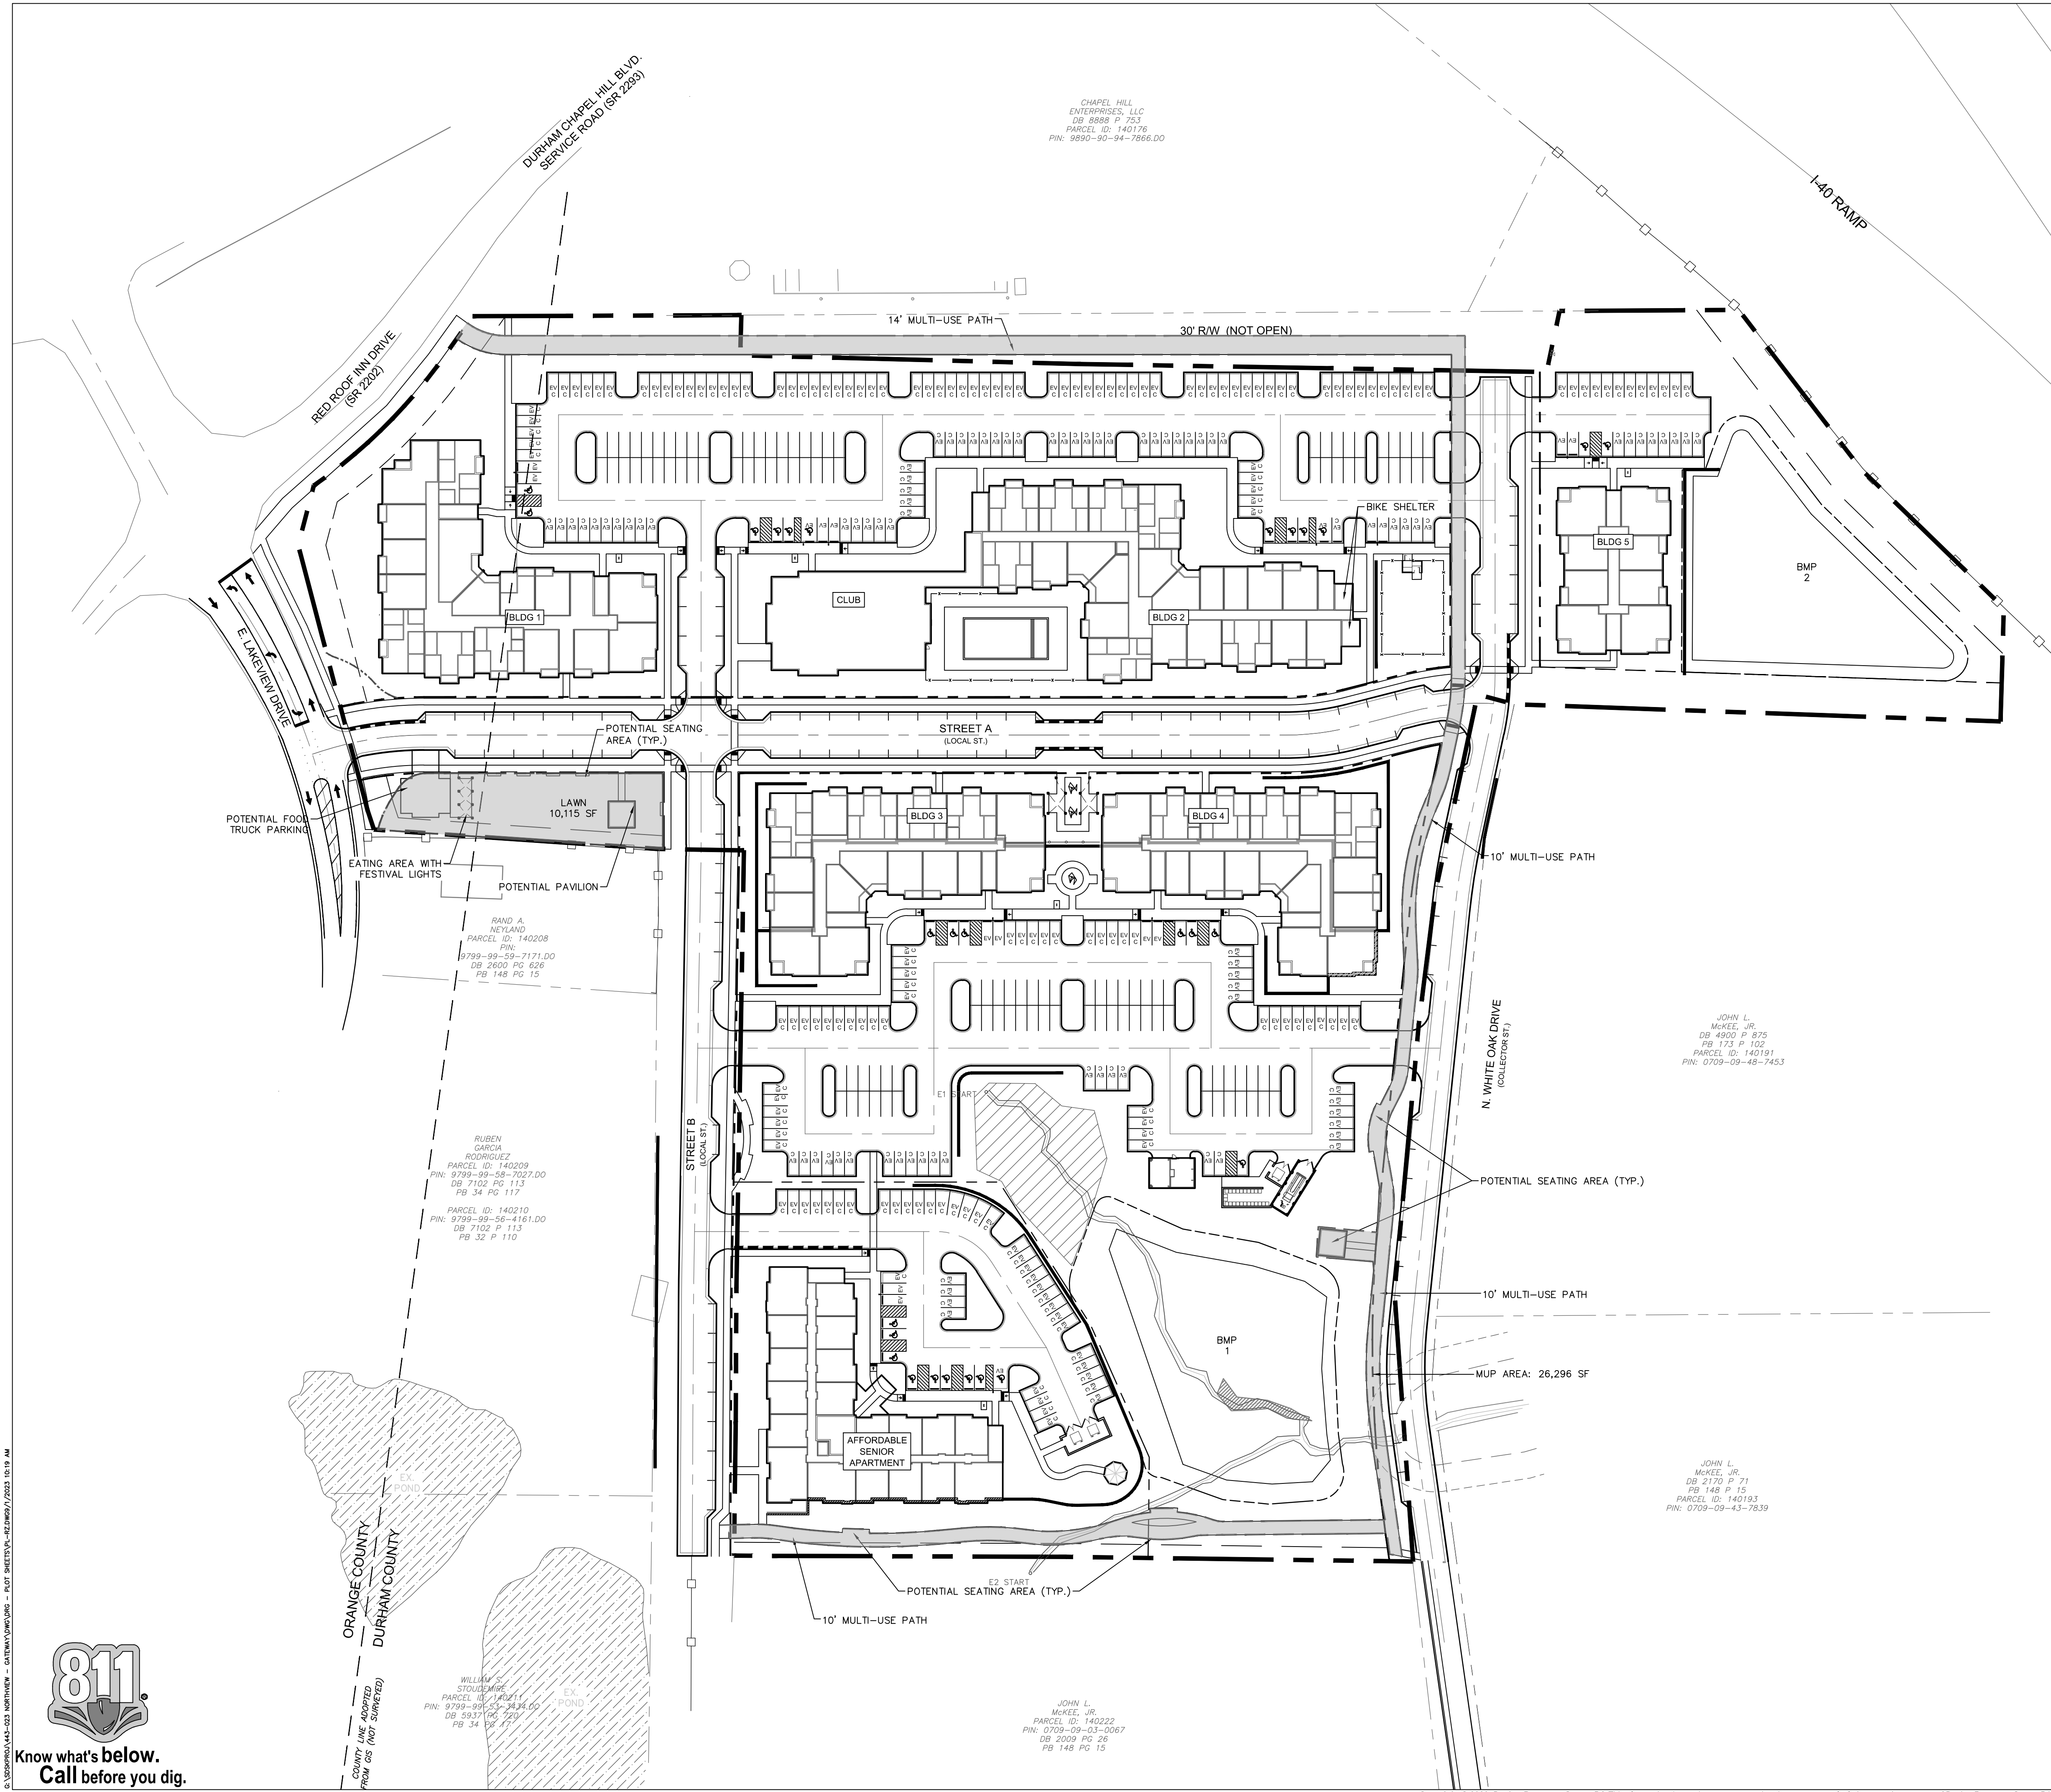

CHAPEL HILL ENTERPRISES, LLC
 DB 8588 P 703
 PARCEL ID: 140175
 PIN: 9890-90-94-7666.00

RAND A. NEYLAND
 PARCEL ID: 140208
 PIN: 9799-99-59-7171.00
 DB 2600 PG 626
 PB 148 PG 15

RUBEN GARCIA RODRIGUEZ
 PARCEL ID: 140209
 PIN: 9799-99-58-7027.00
 DB 7102 PG 113
 PB 34 PG 117

PARCEL ID: 140210
 PIN: 9799-99-56-4161.00
 DB 7102 P 113
 PB 32 P 110


WILLIAM STOUSSMIRE
 PARCEL ID: 140211
 PIN: 9799-99-55-4888.00
 DB 5937 PG 220
 PB 34 PG 117

JOHN L. MCKEE, JR.
 PARCEL ID: 140222
 PIN: 0709-09-03-0067
 DB 2009 PG 26
 PB 148 PG 15

JOHN L. MCKEE, JR.
 DB 4900 P 875
 PB 173 P 102
 PARCEL ID: 140191
 PIN: 0709-09-48-7453

JOHN L. MCKEE, JR.
 DB 2170 P 71
 PB 148 P 15
 PARCEL ID: 140193
 PIN: 0709-09-43-7839



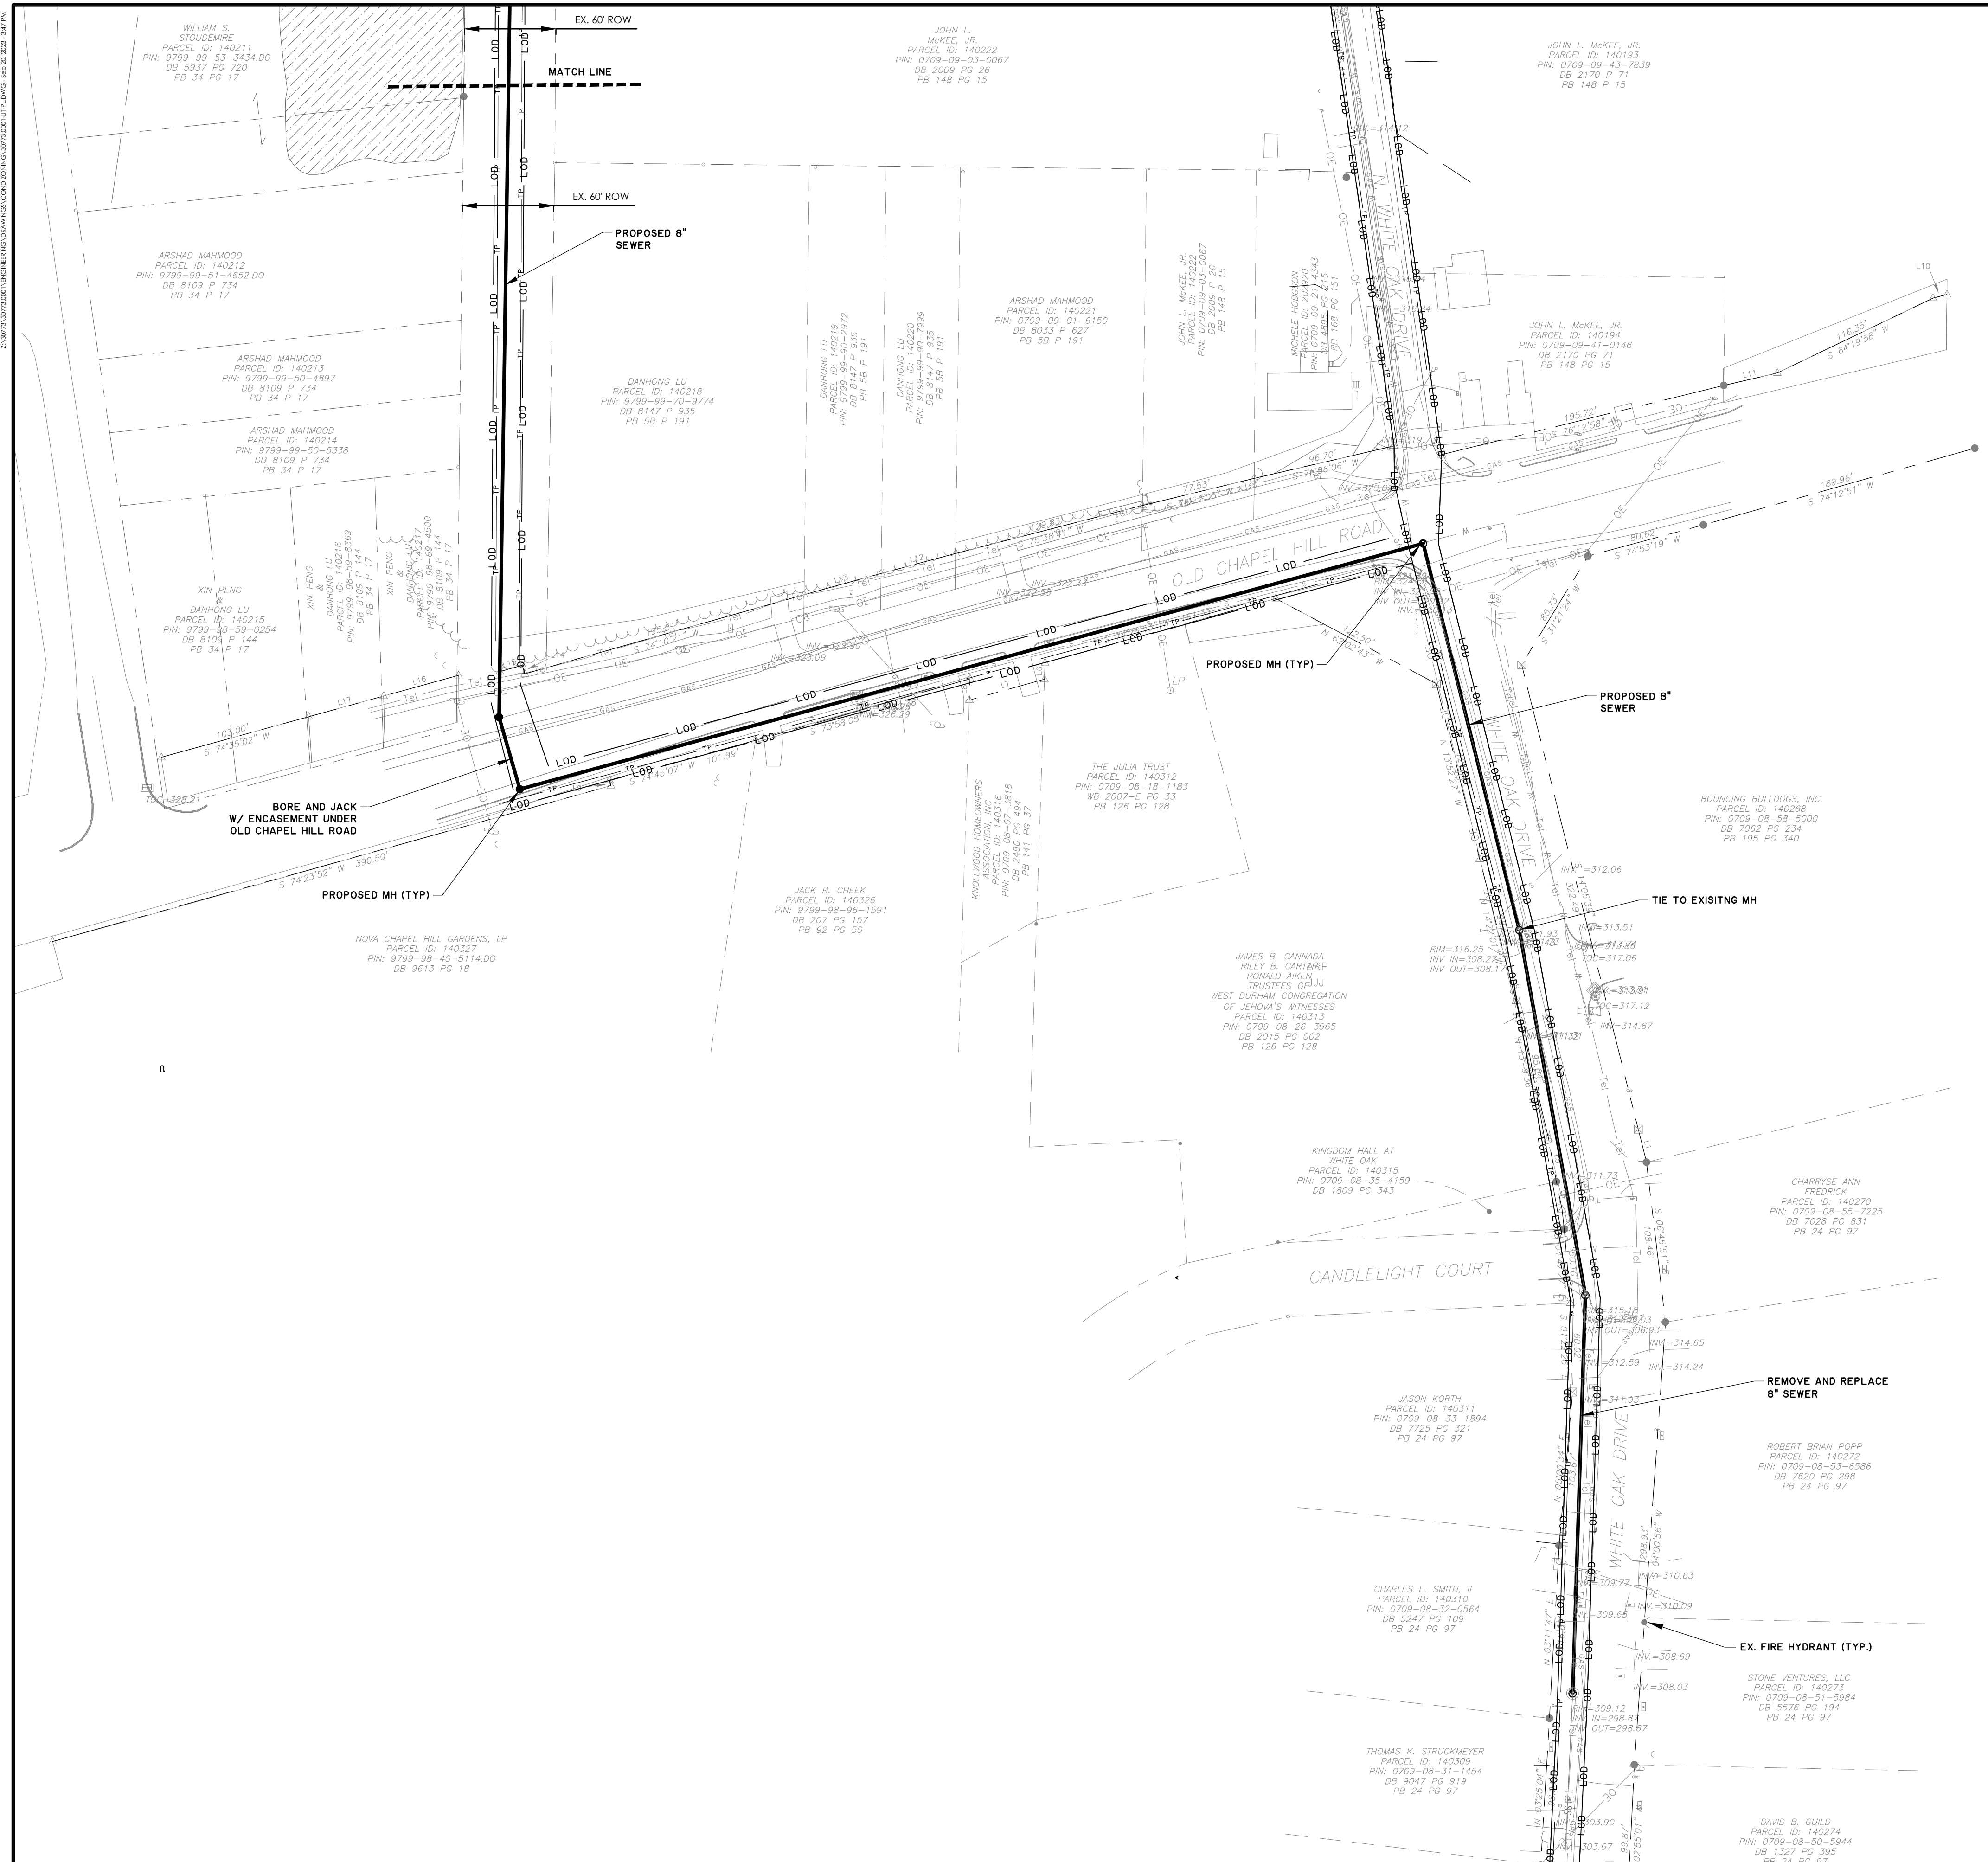

NO.	REVISIONS	BY	DATE
3	SUBMITAL #4	T&H	9/20/2023
2	SUBMITAL #3	T&H	9/11/2023
1	SUBMITAL #2	T&H	7/31/2023
	INITIAL SUBMITAL	T&H	6/8/2023

THOMAS & HUTTON


111 W. MAIN STREET
 DURHAM, NC 27701
 919.682.0368
 www.thomasandhutton.com

UTILITY PLAN

GATEWAY


PROJECT LOCATION:
 East Lakeview Drive
 Chapel Hill, NC

CLIENT/OWNER:
 NorthView Partners

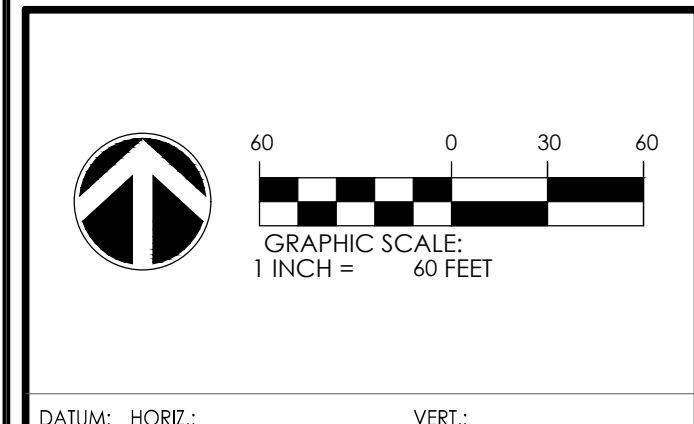

DATUM:	HORZ.:	VERT.:
JOB NO.:	30773.0001	
DATE:		
DRAWN:	AMO, JSA	
DESIGNED:		
REVIEWED:		
APPROVED:		
SCALE:	1" = 60'	

C2.2

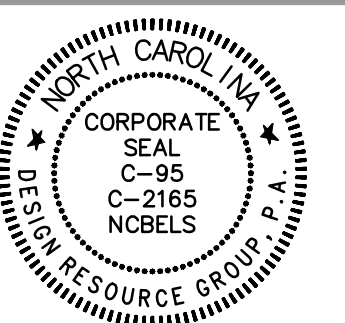


REZONING

**GATEWAY
APARTMENTS**
CHAPEL HILL, NORTH CAROLINA

NORTHVIEW PARTNERS
6131 FALLS OF NEUSE ROAD, SUITE 202
RALEIGH, NORTH CAROLINA 27609

**GRADING &
DRAINAGE
PLAN**

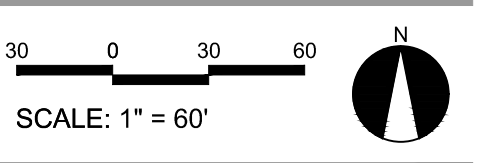

PROJECT #: 443-023
DRAWN BY: JO
CHECKED BY: SK

JUNE 8, 2023

REVISIONS:

SITE ACCESSIBILITY NOTES

- ALL BUILDINGS WITHIN THE BOUNDARY OF THIS SITE, UNLESS OTHERWISE STATED AS EXEMPT, SHALL HAVE "ACCESSIBLE ROUTES" AS REQUIRED THAT CONFORM TO THE REQUIREMENTS OF "THE AMERICANS WITH DISABILITIES ACT," "FAIR HOUSING STANDARDS," ICC ANS A 117.1-209 AND GOVERNING STATE HANDICAP CODE STANDARDS.

THESE STANDARDS FOR ACCESSIBILITY INCLUDE, BUT ARE NOT LIMITED TO:


MAXIMUM WALK SLOPE = 1:20
MAXIMUM RAMP SLOPE = 1:12 WITH RAILING
MAXIMUM CROSS SLOPE = 1:50 (2%)
ALL WALKS TO BE BROOM FINISHED CONCRETE UNLESS OTHERWISE SPECIFIED ON THESE DRAWINGS
MAXIMUM ACCESSIBLE ROUTE LENGTH (NC) = 200'
- THE PAVEMENT SLOPE WITHIN ACCESSIBLE PARKING SPACES SHALL NOT EXCEED 2% IN ALL DIRECTIONS. 1.5% IS RECOMMENDED.
- CONTRACTOR TO CONTACT DESIGN RESOURCE GROUP FOR ANY VARYING SITE CONDITIONS OR DISCREPANCIES AFFECTING SITE ACCESSIBILITY REQUIREMENTS.

ADDITIONAL ACCESSIBLE ROUTE NOTES FOR ACCESSIBILITY COMPLIANCE WITH ICC/ANSI A117.1-2009, AND 2010 ADA STANDARDS.

- PROTRUDING OBJECTS ON CIRCULATION PATHS WITHIN COMMON USE AREAS TO COMPLY WITH ANS 2009 SECTION 307, INCLUDING:
 - PROTRUSING LIMITS: OBJECTS WITH LEADING EDGES MORE THAN 27" AND NOT MORE THAN 80" ABOVE THE FLOOR SHALL PROTRUDE 4" MAXIMUM HORIZONTALLY INTO THE CIRCULATION PATH. EXCEPTIONS INCLUDE HANDRAILS, DOOR CLOSERS, AND DOOR STOPS.
 - POST MOUNTED OBJECTS: OBJECTS ON POSTS OR PYLONS SHALL BE PERMITTED TO OVERHANG 4" MAXIMUM WHERE MORE THAN 27" AND NOT MORE THAN 80" ABOVE THE FLOOR. OBJECTS ON MULTIPLE POSTS OR PYLONS WHERE THE CLEAR DISTANCE BETWEEN THE POSTS OR PYLONS IS GREATER THAN 12" SHALL HAVE THE LOWEST EDGE OF SUCH OBJECT EITHER 27" MAXIMUM OR 80" MINIMUM ABOVE THE FLOOR.
 - REDUCED VERTICAL CLEARANCE: GUARDRAILS OR OTHER BARRIERS SHALL BE PROVIDED WHERE OBJECT PROTRUSION IS BEYOND THE LIMITS ALLOWED BY SECTIONS 307.2 AND 307.3, AND WHERE THE VERTICAL CLEARANCE IS LESS THAN 80" ABOVE THE FLOOR, THE LEADING EDGE OF SUCH GUARDRAIL OR BARRIER SHALL BE 27" MAXIMUM ABOVE THE FLOOR.
- PROTRUDING OBJECTS ON CIRCULATION PATHS WITHIN PUBLIC USE AREAS TO COMPLY WITH 2010 ADA SECTION 307, INCLUDING:
 - 2010 ADA SECTION 307.2: OBJECTS PROJECTING FROM WALLS
 - 2010 ADA SECTION 307.4: MINIMUM CLEAR HEADROOM
- FLOOR AND GROUND SURFACES IN COMMON USE AREAS SHALL BE STABLE, FIRM, AND SLIP RESISTANT AND SHALL COMPLY WITH ANS 2009 SECTION 302.
- FLOOR AND GROUND SURFACES ALONG ACCESSIBLE ROUTES AND IN ACCESSIBLE ROOMS AND SPACES WITH PUBLIC USE AREAS SHALL BE STABLE, FIRM, AND SLIP-RESISTANT AND SHALL COMPLY WITH 2010 ADA SECTION 302.
- CHANGES IN LEVEL IN COMMON USE AREAS SHALL COMPLY WITH ANS 2009 SECTION 303, INCLUDING:
 - ANSI 2009 SECTION 303.2: VERTICAL
 - ANSI 2009 SECTION 303.3: BEVELED
 - ANSI 2009 SECTION 303.4: RAMPS
- CHANGES IN LEVEL ALONG ACCESSIBLE ROUTES AND IN ACCESSIBLE ROOMS AND SPACES WITH PUBLIC USE AREAS SHALL COMPLY WITH 2010 ADA SECTION 303, INCLUDING:
 - 2010 ADA SECTION 303.2: VERTICAL
 - 2010 ADA SECTION 303.3: BEVELED
 - 2010 ADA SECTION 303.4: RAMPS

TREE PROTECTION NOTES:


- PRIOR TO DEMOLITION, CLEARING, CONSTRUCTION, GRADING, AND INSTALLATION OF EROSION CONTROL MEASURES; TREE PROTECTIVE BARRIERS MUST BE INSTALLED AROUND ALL TREE SAVE AREAS BY THE DEVELOPER AND APPROVED BY THE CITY.
- THE TREE PROTECTION FENCE SHALL BE LOCATED ALONG THE PERIMETER OF THE TREE SAVE AREA (DRIP LINE PLUS 5 FEET). TREE PROTECTION FENCING FOR A FOREST CANOPY STANDS AREA IS TO BE LOCATED ALONG THE PERIMETER OF THE TREE SAVE AREA AROUND THE FOREST EDGE. TREE PROTECTION FENCING SHALL CONSIST OF ORANGE SAFETY FENCING OR A COMBINATION OF ORANGE SAFETY FENCING WITH SILT FENCING AT A MINIMUM OF 4 FEET IN HEIGHT ON METAL OR WOOD POSTS.
- ALL TREE PROTECTION AREAS MUST BE DESIGNATED AS SUCH WITH "TREE SAVE AREA SIGNS" POSTED IN ADDITION TO THE REQUIRED PROTECTIVE FENCING. SIGNS REQUESTING SUBCONTRACTOR COOPERATION AND COMPLIANCE WITH TREE PROTECTION STANDARDS ARE RECOMMENDED FOR SITE ENTRANCES.
- NO SOIL DISTURBANCE OR COMPACTION, STOCK PILING OF SOIL OR OTHER CONSTRUCTION MATERIAL, VEHICULAR TRAFFIC, OR STORAGE OF EQUIPMENT AND MATERIALS ARE ALLOWED WITHIN TREE SAVE AREAS.
- NO ROPES, SIGNS, WIRES, UNPROTECTED ELECTRICAL INSTALLATION OR OTHER DEVICE OR MATERIAL, SHALL BE SECURED OR FASTENED AROUND OR THROUGH A TREE OR SHRUB.
- ALL PROTECTIVE MEASURES SHALL BE MAINTAINED THROUGHOUT THE LAND DISTURBING AND CONSTRUCTION PROCESS, AND SHALL NOT BE REMOVED UNTIL FINAL LANDSCAPING IS INSTALLED.
- SEE DETAIL SHEETS FOR TREE PROTECTION, TREE AND SHRUB PLANTING.

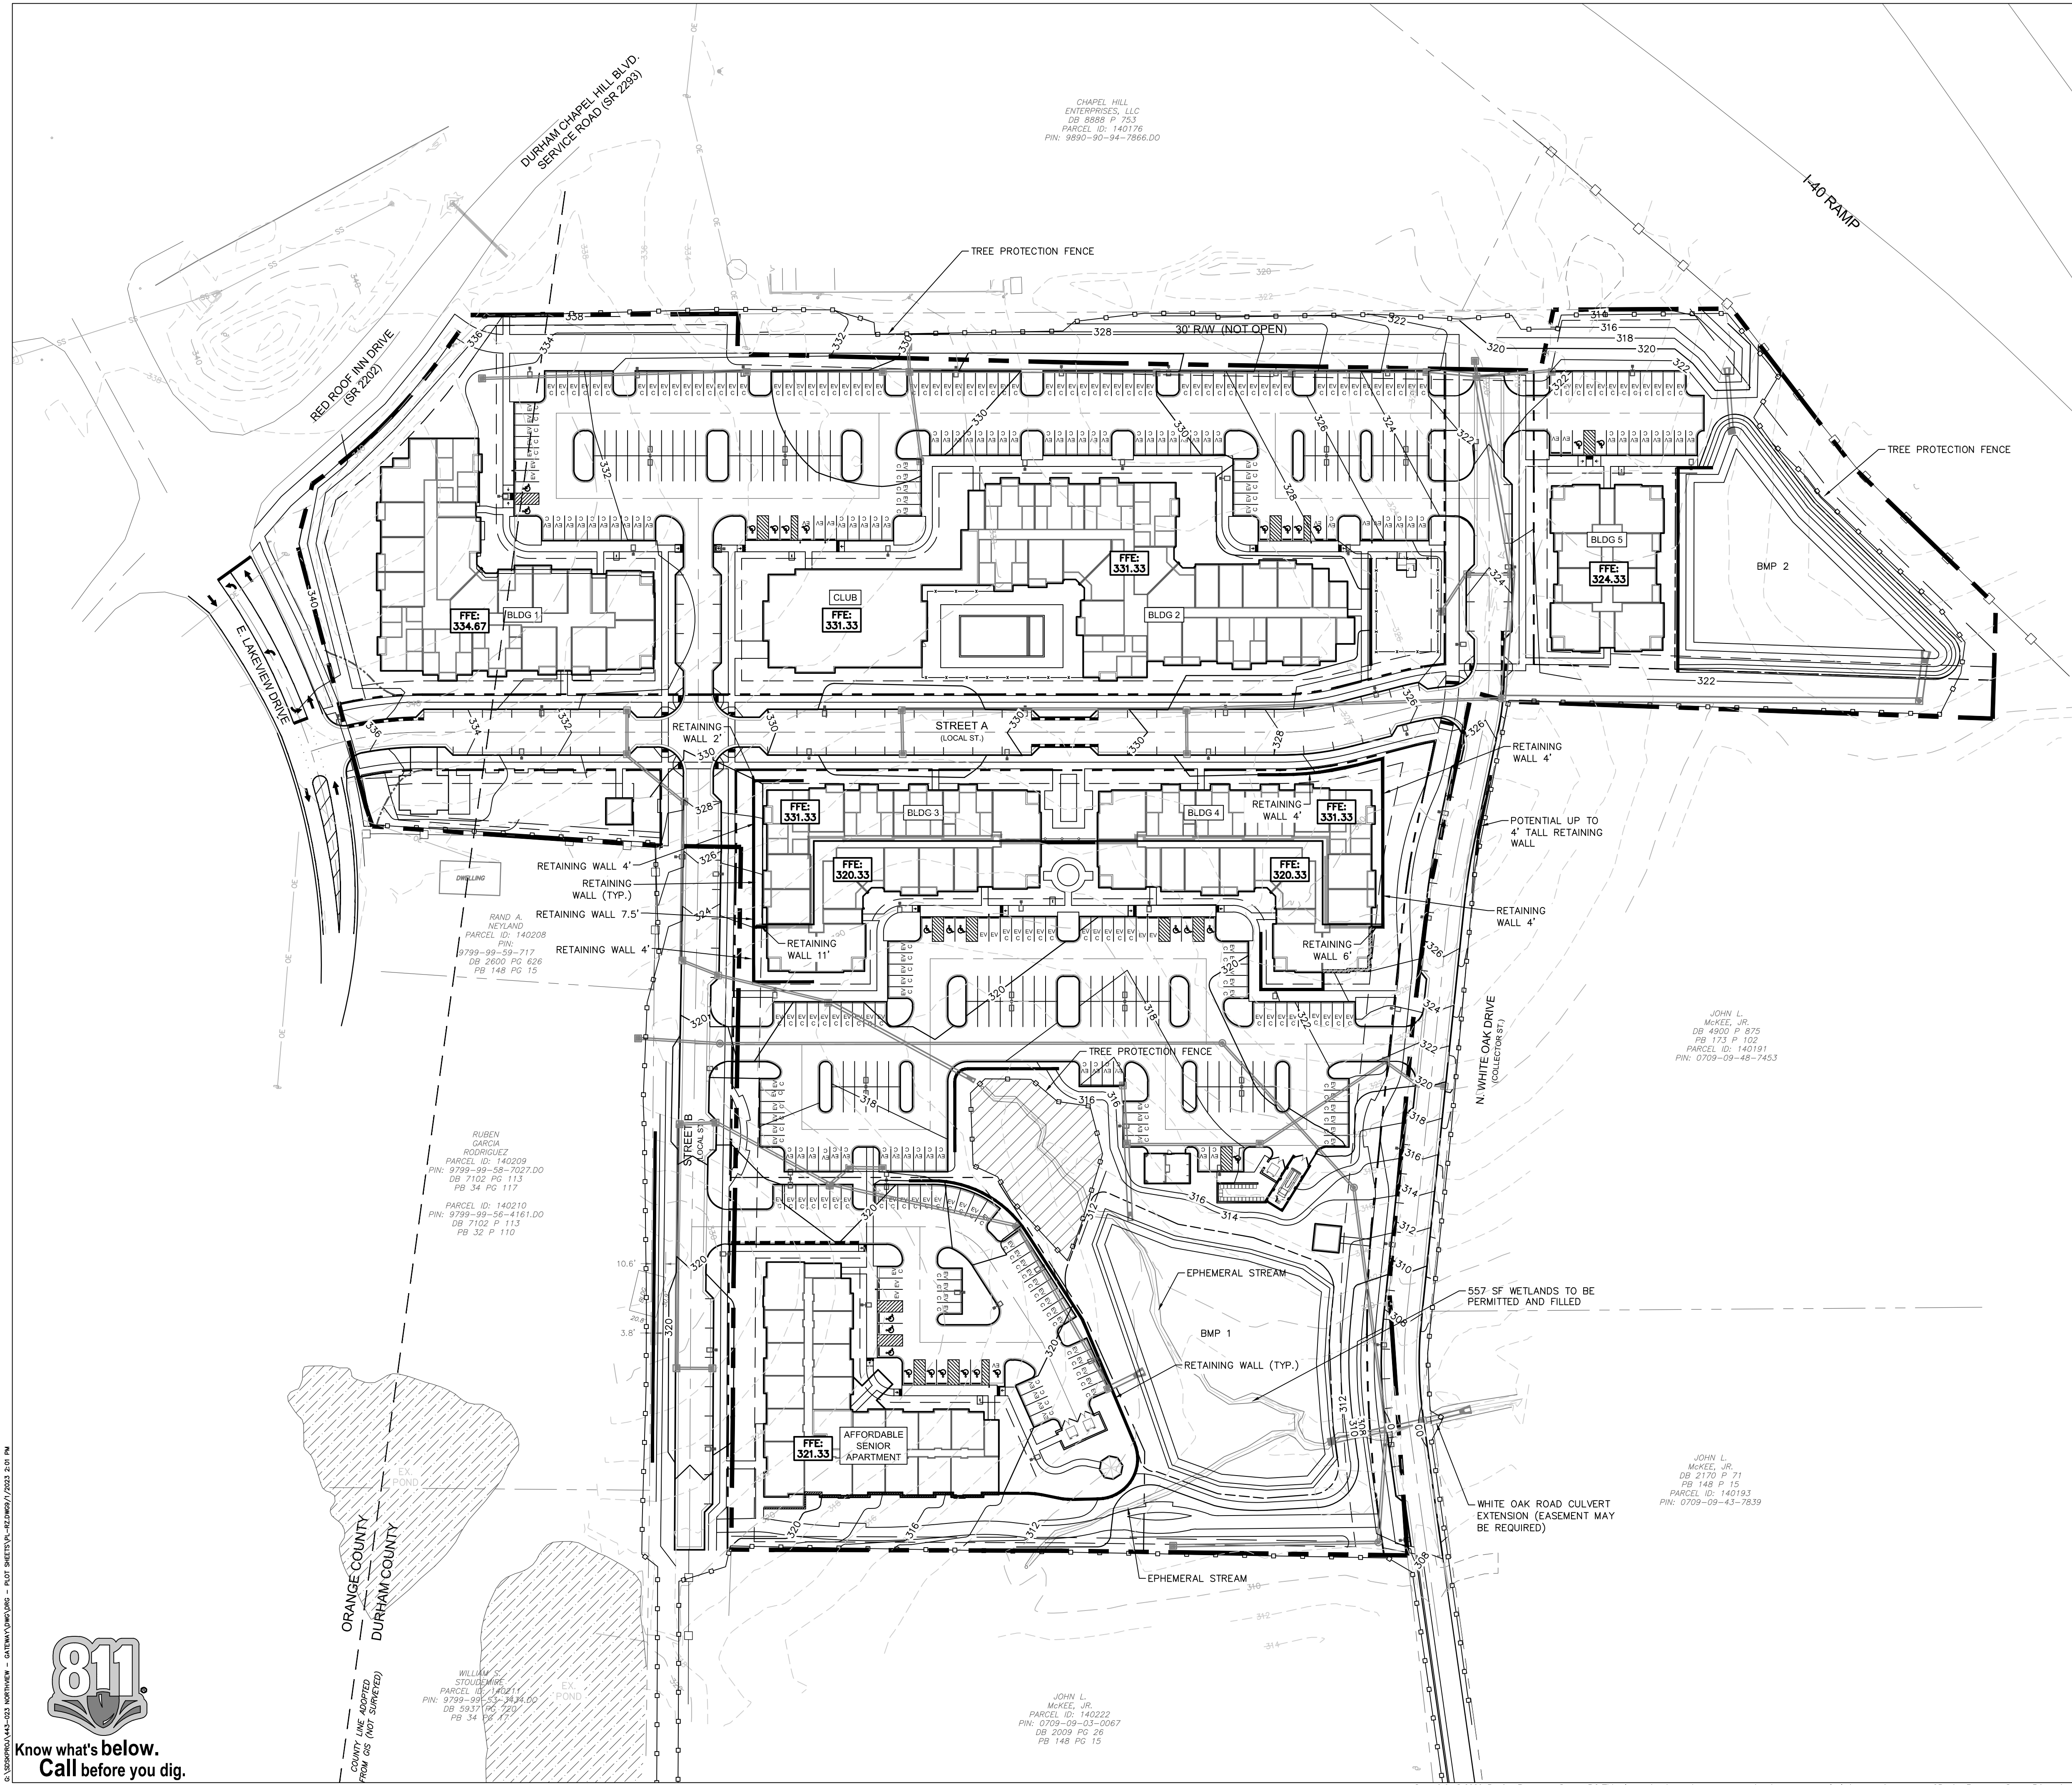

C:\WORK\14-033 NORTHVIEW - GATEWAY\DWG - PLOT SHEETS\14-033\DWG\7/2023 2 OF 11



Know what's below.
Call before you dig.

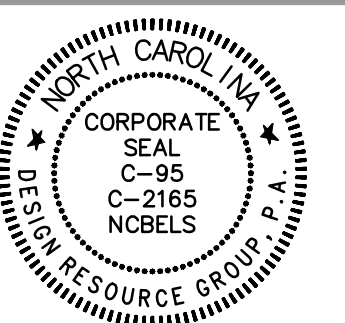

STANDARD ENGINEERING DEPARTMENT

TITLE: CURB & GUTTER SECTION
 REVISIONS: [Table]
 DET. NO.: ST-2

SCALE: 1"=1'-0"

STANDARD ENGINEERING DEPARTMENT

TITLE: TYPICAL SIDEWALK
 REVISIONS: [Table]
 DET. NO.: ST-4

NO SCALE

STANDARD ENGINEERING DEPARTMENT

TITLE: ACCESSIBLE RAMP WITH DETECTABLE WARNING DOMES
 REVISIONS: [Table]
 DET. NO.: ST-5.1

NOTE: DRAWING NOT TO SCALE

1 TOWN OF CHAPEL HILL, NORTH CAROLINA DEPARTMENT OF ENGINEERING CURB AND GUTTER SECTION STD. NO. ST-2 REV.

2 TOWN OF CHAPEL HILL, NORTH CAROLINA DEPARTMENT OF ENGINEERING TYPICAL SIDEWALK STD. NO. ST-4 REV.

3 TOWN OF CHAPEL HILL, NORTH CAROLINA DEPARTMENT OF ENGINEERING ACCESSIBLE RAMP WITH DETECTABLE WARNING DOMES STD. NO. ST-5.1 REV. 7/27/22

STANDARD ENGINEERING DEPARTMENT

TITLE: ACCESSIBLE RAMP
 REVISIONS: 09/03 JH
 DET. NO.: ST-5.2

NOTE: DRAWING NOT TO SCALE. SOURCE: NCDOT STANDARD DRAWINGS

STANDARD ENGINEERING DEPARTMENT

TITLE: ACCESSIBLE RAMP
 REVISIONS: 09/03 JH, 02/08 ER
 DET. NO.: ST-5.3

NOTE: DRAWING NOT TO SCALE. SOURCE: NCDOT STANDARD DRAWINGS

STANDARD ENGINEERING DEPARTMENT

TITLE: ACCESSIBLE RAMP
 REVISIONS: 09/03 JH
 DET. NO.: ST-5.4

SOURCE: NCDOT STANDARD DRAWINGS

4 TOWN OF CHAPEL HILL, NORTH CAROLINA DEPARTMENT OF ENGINEERING ACCESSIBLE RAMP STD. NO. ST-5.2 REV. 09/03

5 TOWN OF CHAPEL HILL, NORTH CAROLINA DEPARTMENT OF ENGINEERING ACCESSIBLE RAMP STD. NO. ST-5.3 REV. 02/08

6 TOWN OF CHAPEL HILL, NORTH CAROLINA DEPARTMENT OF ENGINEERING ACCESSIBLE RAMP STD. NO. ST-5.4 REV. 09/03

STANDARD ENGINEERING DEPARTMENT

TITLE: TYPICAL SIGN INSTALLATIONS
 REVISIONS: [Table]
 DET. NO.: ST-12

NO SCALE

TOWN OF CHAPEL HILL
ST. NAME & TRAFFIC SIGN STANDARDS

STREET NAME SIGNS

- All names will start with a 6" capital letter, followed by lower case letters. The road designations (St., Rd., Cr. ... etc.) will be in 50% superscript, aligned with the top letter edge.
- The color scheme should be a background of bright green with white high intensity grade letters & border (1/2").
- The border is NOT inset.
- The street name sign should include on the left a replication of the Town seal, & on the right a block number.
- The town seal should be the same color and height as the street name.
- Block numbers should be the same color as the superscript, 2" in height, & aligned with the bottom of the street name. The number should be centered 3/4" below the road superscript.
- The letter font should be Highway Gothic C Fed Kern RevB.
- All street name sign blades must be nine inches in height. The minimum length is 30", maximum is 48". The actual length of the blade will be dictated by the number of letters in the name.
- The street name (including Town seal, block numbers, & superscript), should be at least 4" shorter than the sign blade.
- All street name posts will be round, aluminum or steel, 2 3/8" OD, & at least 10' in length.
- STOP signs - 30" x 30"
- REGULATORY SIGNS - STOP, YIELD, DO NOT ENTER, WRONG WAY, & SPEED LIMIT signs should be fabricated with High Intensity reflective material.

ALL OTHER SIGNS

- STOP signs - 30" x 30"
- REGULATORY SIGNS - STOP, YIELD, DO NOT ENTER, WRONG WAY, & SPEED LIMIT signs should be fabricated with High Intensity reflective material.
- All other signs shall be made from Engineer Grade material.
- All other signs should be 7" from the ground to the bottom of the sign, unless more than one sign is on a post.
- Installed signs should be minimum of 2' from sign edge to the road edge.
- All other sign posts should be channel posts made of galvanized steel, 8" posts 2lbs/ft, 12" posts 3lbs/ft.
- All signs are required to be designed in accordance with the MUTCD standards.

TITLE: STREET NAME & TRAFFIC SIGN STANDARDS
 REVISIONS: 02/08 ER
 DET. NO.: ST-15

STANDARD ENGINEERING DEPARTMENT

TITLE: OVERHEAD STREET NAME SIGN
 REVISIONS: [Table]
 DET. NO.: ST-14

FONT: Highway Gothic E/M Fed Kern RevB
 Letter Height = 10.25" for Capital letters
 Green material = 3M 1177CS (ECM) Electrocoat Film
 White = 3M 3870 High Intensity

7 TOWN OF CHAPEL HILL, NORTH CAROLINA DEPARTMENT OF ENGINEERING TYPICAL SIGN INSTALLATIONS STD. NO. ST-12 REV.

8 TOWN OF CHAPEL HILL, NORTH CAROLINA DEPARTMENT OF ENGINEERING STREET NAME AND TRAFFIC SIGN STANDARD NOTES STD. NO. ST-15 REV. 02/08

9 TOWN OF CHAPEL HILL, NORTH CAROLINA DEPARTMENT OF ENGINEERING OVERHEAD STREET NAME SIGN STD. NO. ST-14 REV.

REZONING

GATEWAY APARTMENTS
CHAPEL HILL, NORTH CAROLINA

NORTHVIEW PARTNERS
6131 FALLS OF NEUSE ROAD, SUITE 202
RALEIGH, NORTH CAROLINA 27609

SITE DETAILS

SCALE: NTS

PROJECT #: 443-023
 DRAWN BY: VA
 CHECKED BY: SK

JUNE 8, 2023

REVISIONS:

A. STANDARD AUTOMOBILES

A	B	C	D	D'	E	F	F'	G
0°	8.0'	N/A	12.0'	20.0'	23.0'	28.0'	36.0'	N/A
45°	8.5'	18.0'	13.0'	20.0'	12.0'	49.0'	56.0'	2.0'
60°	8.5'	19.5'	16.0'	20.0'	9.8'	55.0'	59.0'	2.5'
75°	8.5'	19.8'	20.0'	20.0'	8.8'	59.6'	59.6'	3.0'
90°	8.5'	18.5'	25.0'	25.0'	8.5'	62.0'	62.0'	3.0'

B. COMPACT AUTOMOBILES

A	B	C	D	D'	E	F	F'	G
0°	8.0'	N/A	11.0'	20.0'	19.0'	27.0'	36.0'	N/A
45°	8.0'	15.3'	11.5'	20.0'	11.3'	42.1'	50.6'	1.5'
60°	8.0'	16.3'	13.3'	20.0'	9.2'	45.9'	52.6'	1.8'
75°	8.0'	16.5'	16.0'	20.0'	8.2'	49.0'	53.0'	2.0'
90°	8.0'	15.5'	20.0'	20.0'	8.0'	51.0'	51.0'	2.0'

ENGINEERING DEPARTMENT



STANDARD DETAILS

REVISIONS

NO.	DATE	BY

TITLE LOT LAYOUT SCHEDULE

DET. NO. P-1

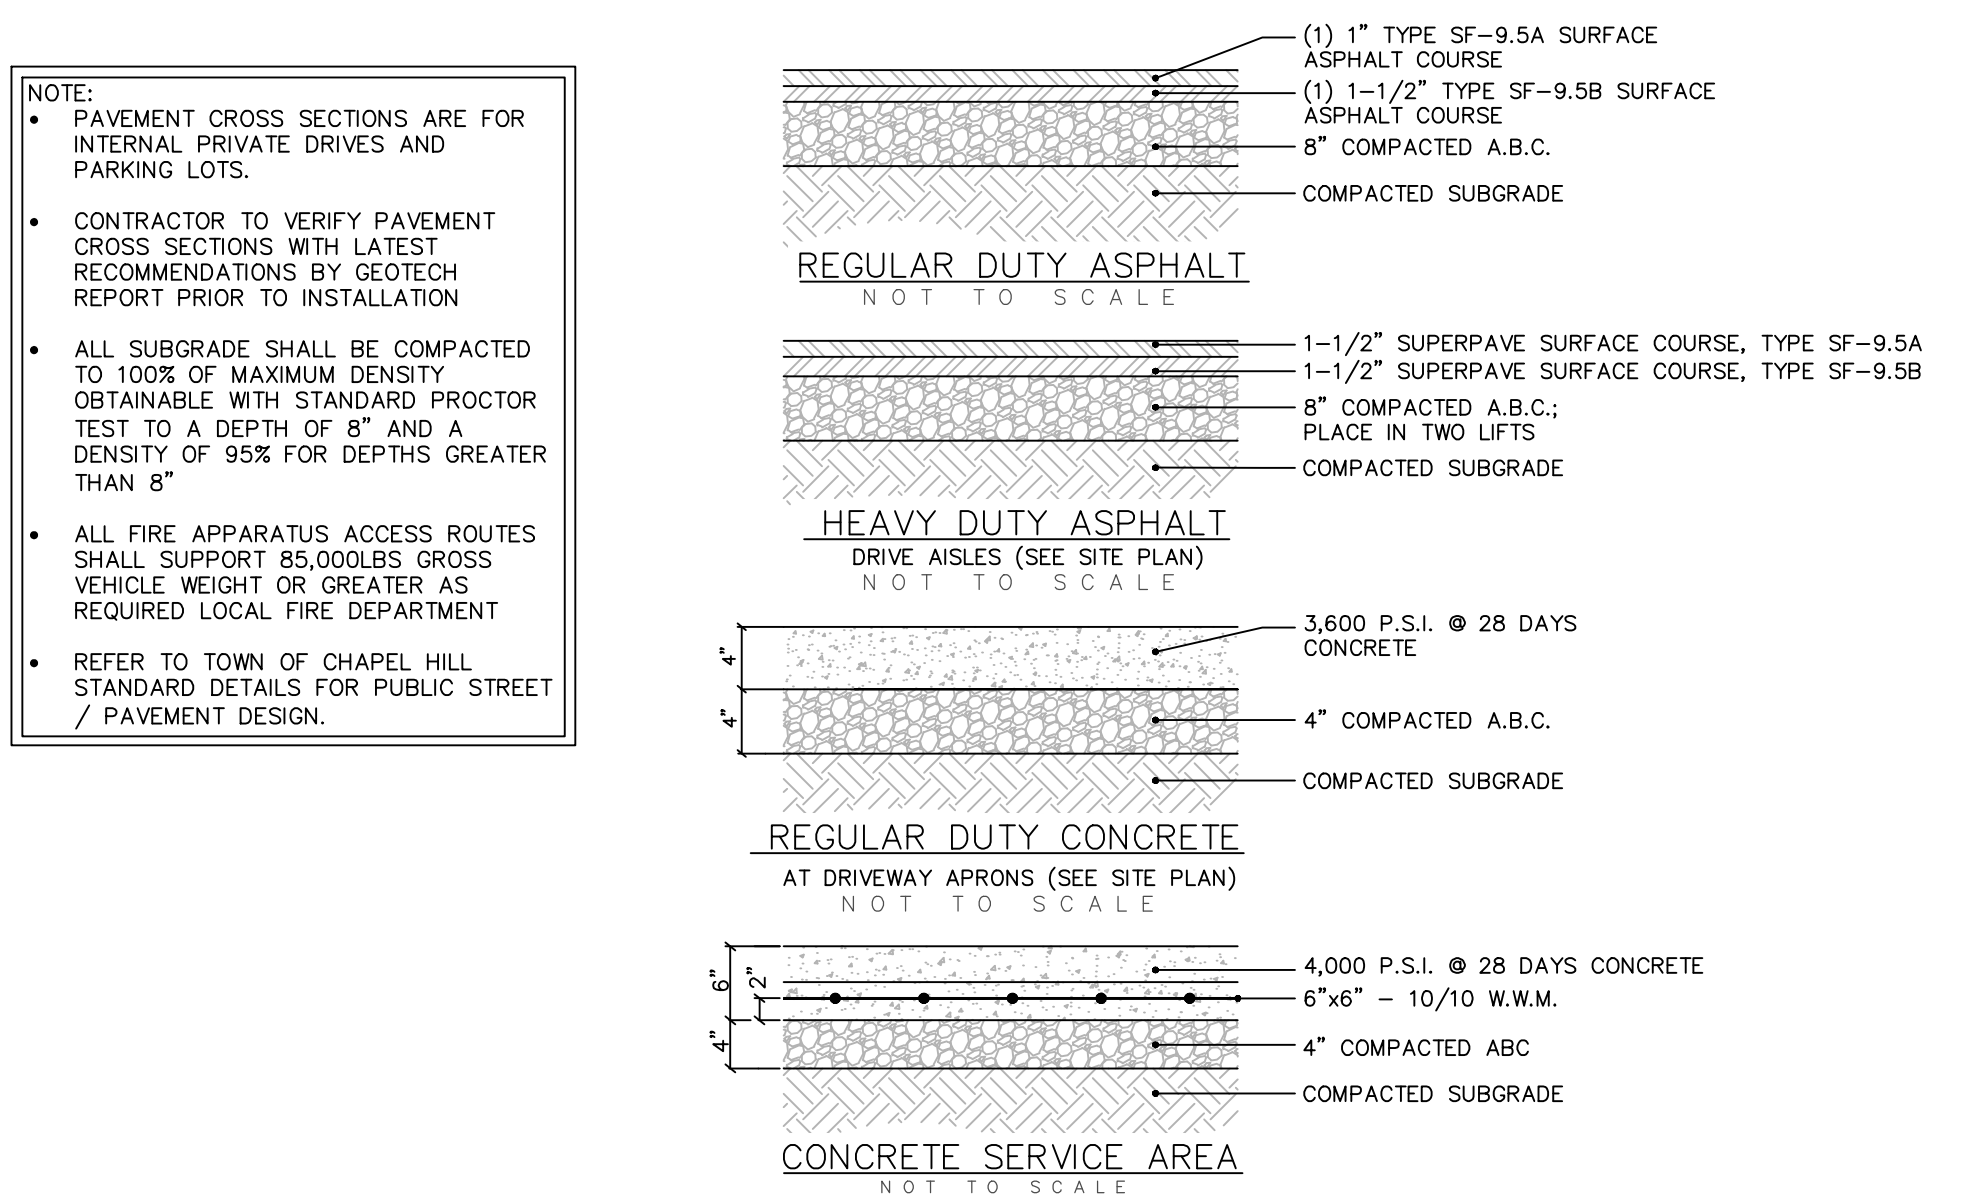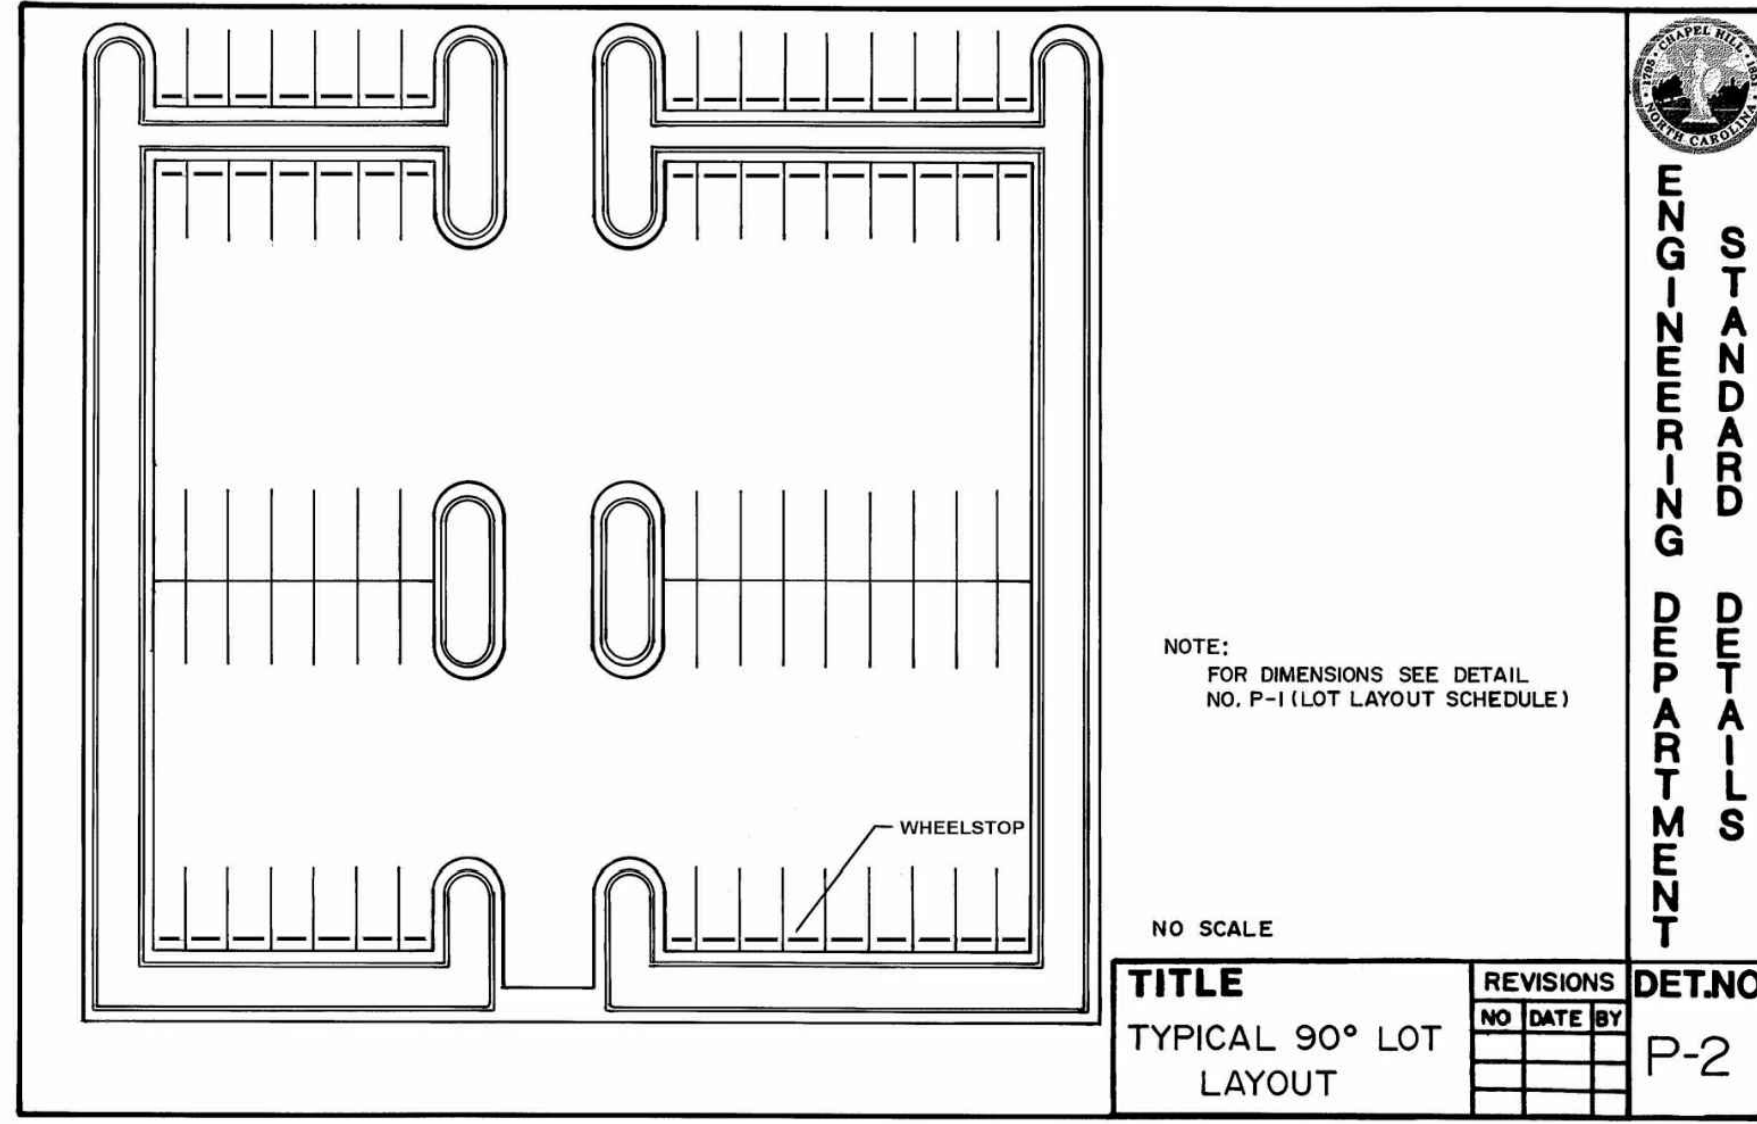

1

TOWN OF CHAPEL HILL, NORTH CAROLINA
DEPARTMENT OF ENGINEERING

PARKING LOT LAYOUT & SCHEDULE

STD. NO. REV. P-1

2

TOWN OF CHAPEL HILL, NORTH CAROLINA
DEPARTMENT OF ENGINEERING

TYPICAL 90 DEGREE PARKING LOT LAYOUT

STD. NO. REV. P-2

3

TOWN OF CHAPEL HILL, NORTH CAROLINA
DEPARTMENT OF ENGINEERING

PRIVATE PAVEMENT CROSS SECTIONS

STD. NO. REV. P-2

ACCESSIBLE PARKING REQUIREMENTS

TOTAL PARKING SPACES PROVIDED	MINIMUM NUMBER OF ACCESSIBLE SPACES REQUIRED	MINIMUM NUMBER OF ACCESSIBLE SPACES TO BE VAN ACCESSIBLE
1 TO 25	1	1
26 TO 50	2	1
51 TO 75	3	1
76 TO 100	4	1
101 TO 150	5	1
151 TO 200	6	1
201 TO 300	7	2
301 TO 400	8	2
401 TO 500	9	2
501 TO 1000	2% OF TOTAL	1 IN EVERY 6 ACCESSIBLE SPACES
1001 AND OVER	20 PLUS 1 FOR EACH 100 OVER 1000	1 IN EVERY 6 ACCESSIBLE SPACES

REFERENCE: SECTION 1106 OF NC BUILDING CODE

NOTES:

- ALL ACCESSIBLE SIGNS (R7-8P, R7-8, R7-1, AND 50.100) SHALL BE MOUNTED AT 7 FEET FROM GRADE TO BOTTOM EDGE OF SIGN FACE (PER MUTCD). MOUNTING HEIGHT CAN BE REDUCED TO 5 FEET IF PLACED IN AN AREA BETWEEN SIDEWALK AND BUILDING FACE IN WHICH PEDESTRIANS ARE NOT EXPECTED TO USE.
- IF ACCESSIBLE ROUTE IS A RAISED SIDEWALK AREA, THEN RAMPS ARE REQUIRED AT LOADING ZONE AREA. MAINTAIN MIN. 4" WIDE CONTINUOUS PASSAGE.
- VERTICAL CLEARANCE FOR VANS MUST BE GREATER THAN 98-INCHES.
- THIS DETAIL IS TO PROVIDE GENERAL GUIDANCE FOR PARKING LAYOUT AND DESIGN. REFER TO MANUAL ON UNIFORM TRAFFIC CONTROL DEVICES (MUTCD), U.S. DEPARTMENT OF TRANSPORTATION AND NORTH CAROLINA DEPARTMENT OF TRANSPORTATION SUPPLEMENT AND NC BUILDING CODE FOR ADDITIONAL INFORMATION.

ENGINEERING DEPARTMENT



STANDARD DETAILS

REVISIONS

NO.	DATE	BY

TITLE ACCESSIBLE PARKING REQUIREMENTS

DET. NO. P-1

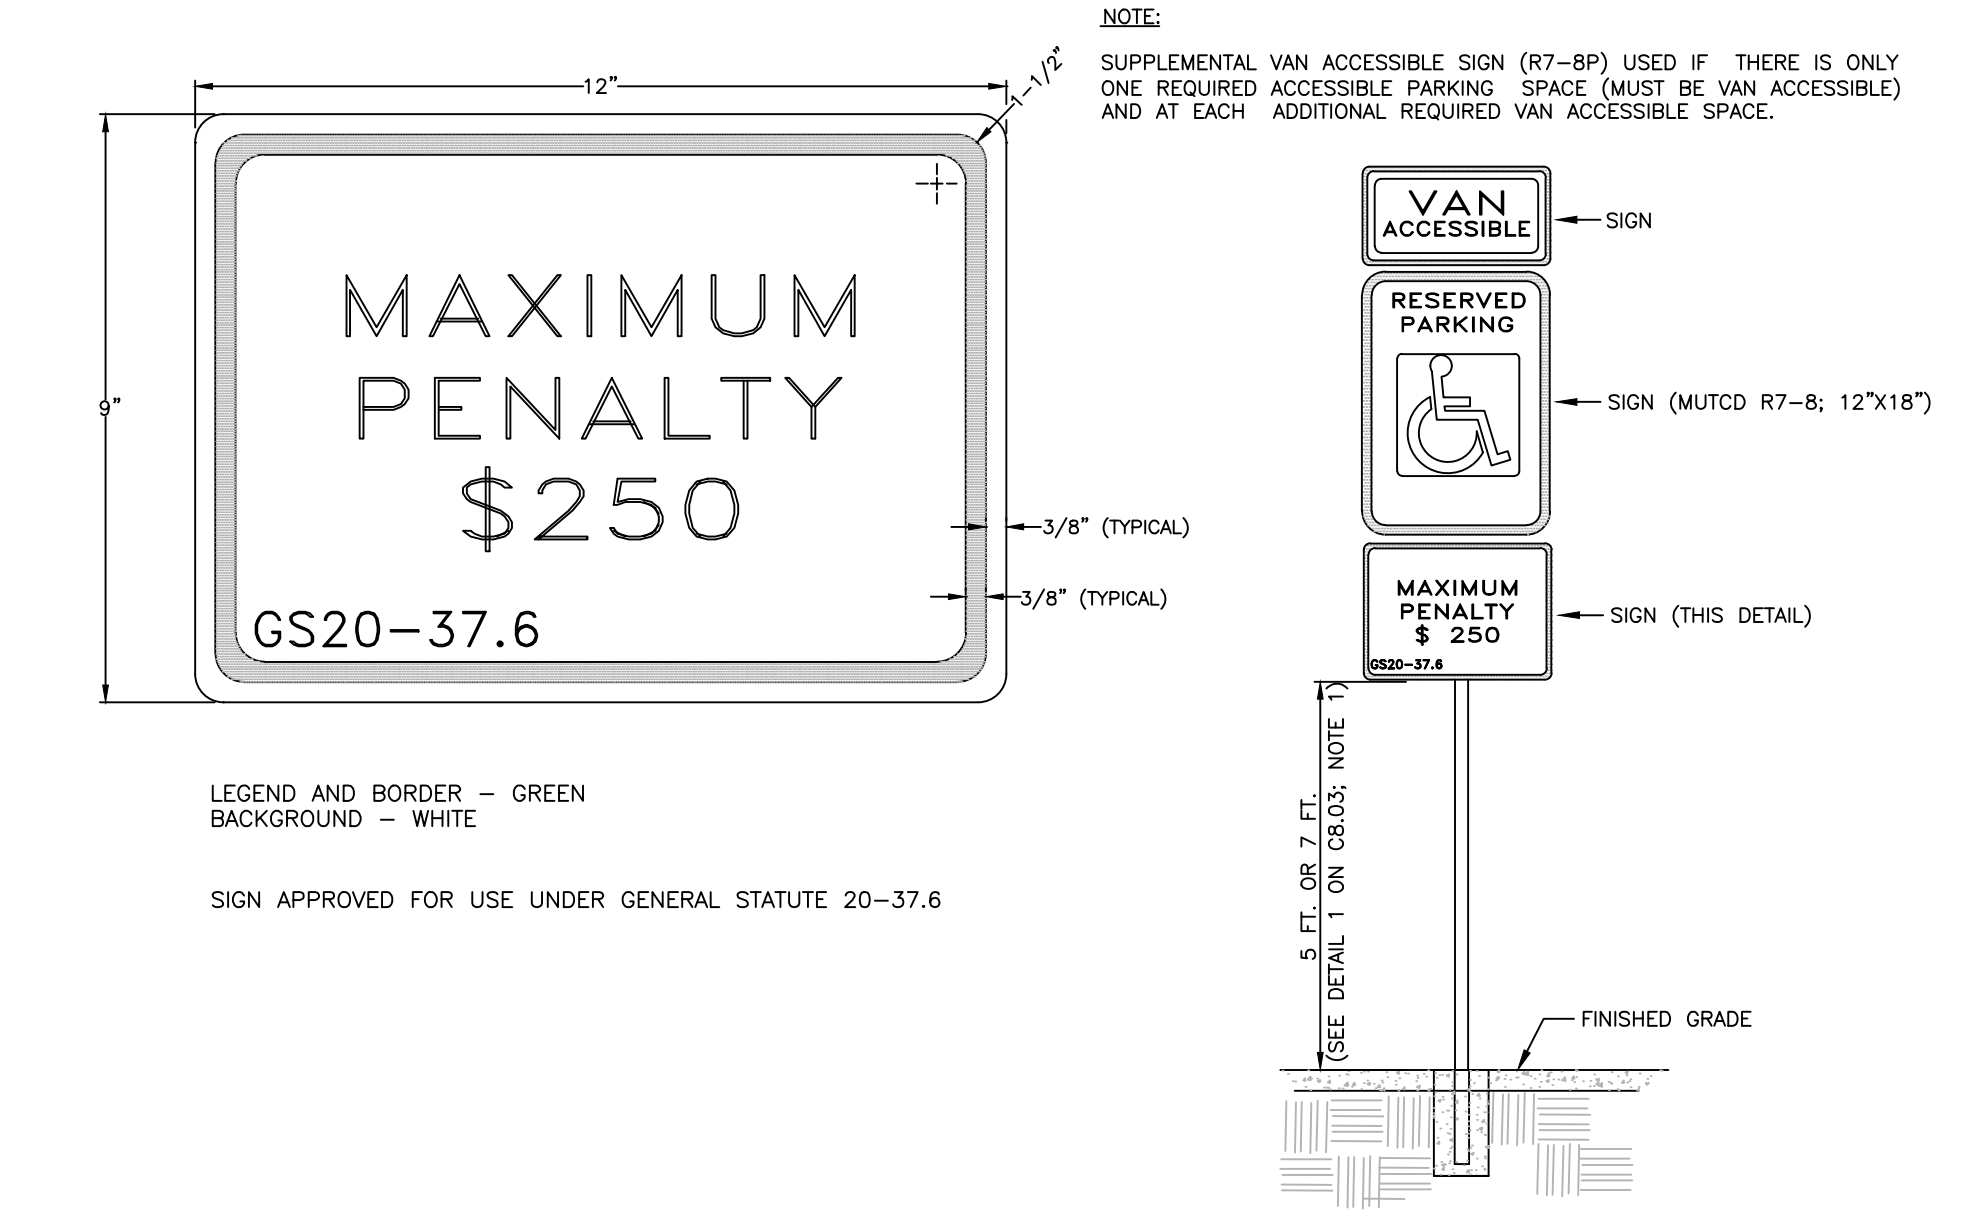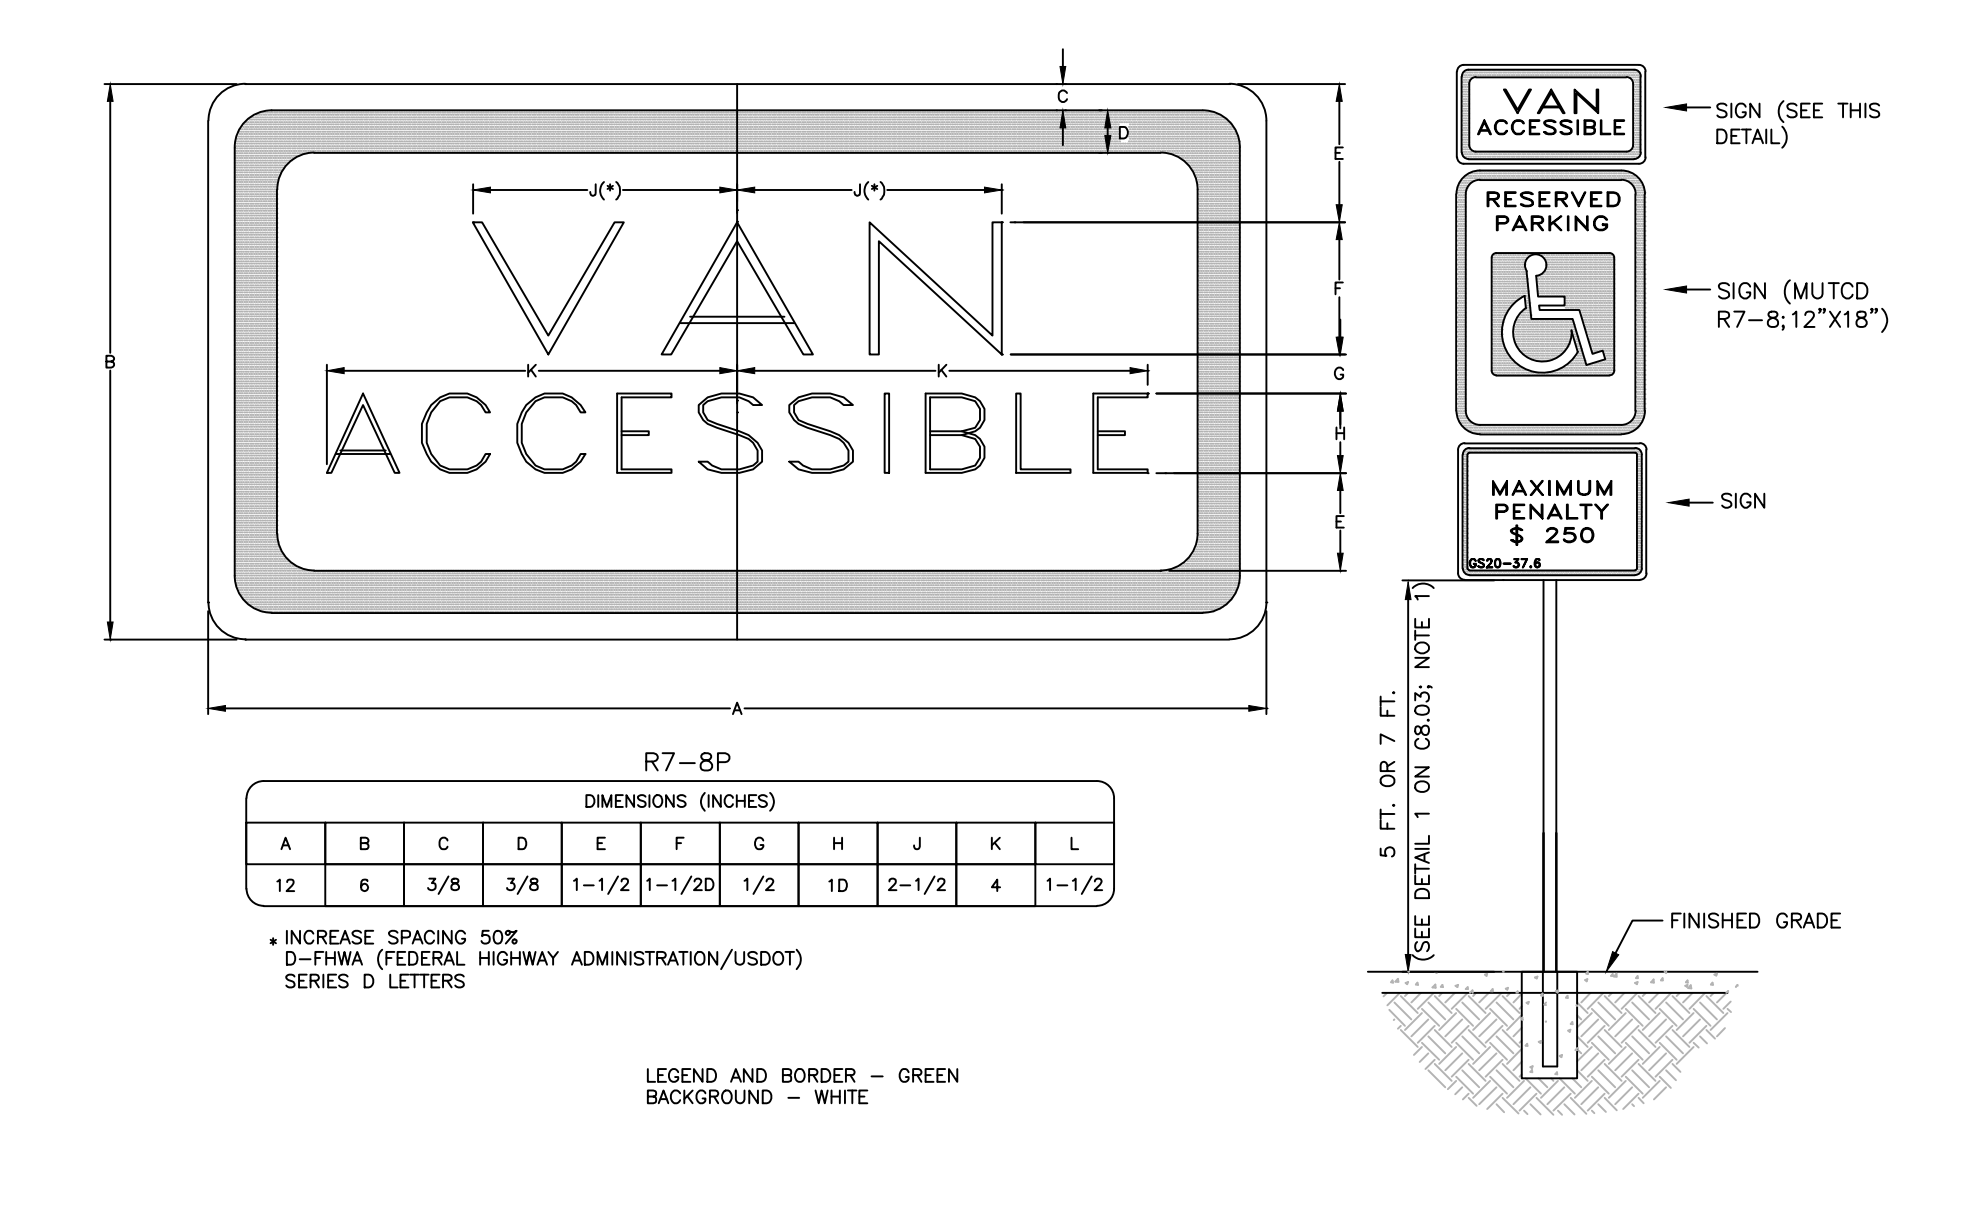

4

TOWN OF CHAPEL HILL, NORTH CAROLINA
DEPARTMENT OF ENGINEERING

ACCESSIBLE PARKING AND SIGNAGE STANDARDS

STD. NO. REV. P-1

5

TOWN OF CHAPEL HILL, NORTH CAROLINA
DEPARTMENT OF ENGINEERING

SUPPLEMENTAL VAN ACCESSIBLE SIGN (R7-8P)




STD. NO. REV. P-2

6

TOWN OF CHAPEL HILL, NORTH CAROLINA
DEPARTMENT OF ENGINEERING

SUPPLEMENTAL ACCESSIBLE SIGN

STD. NO. REV. P-2

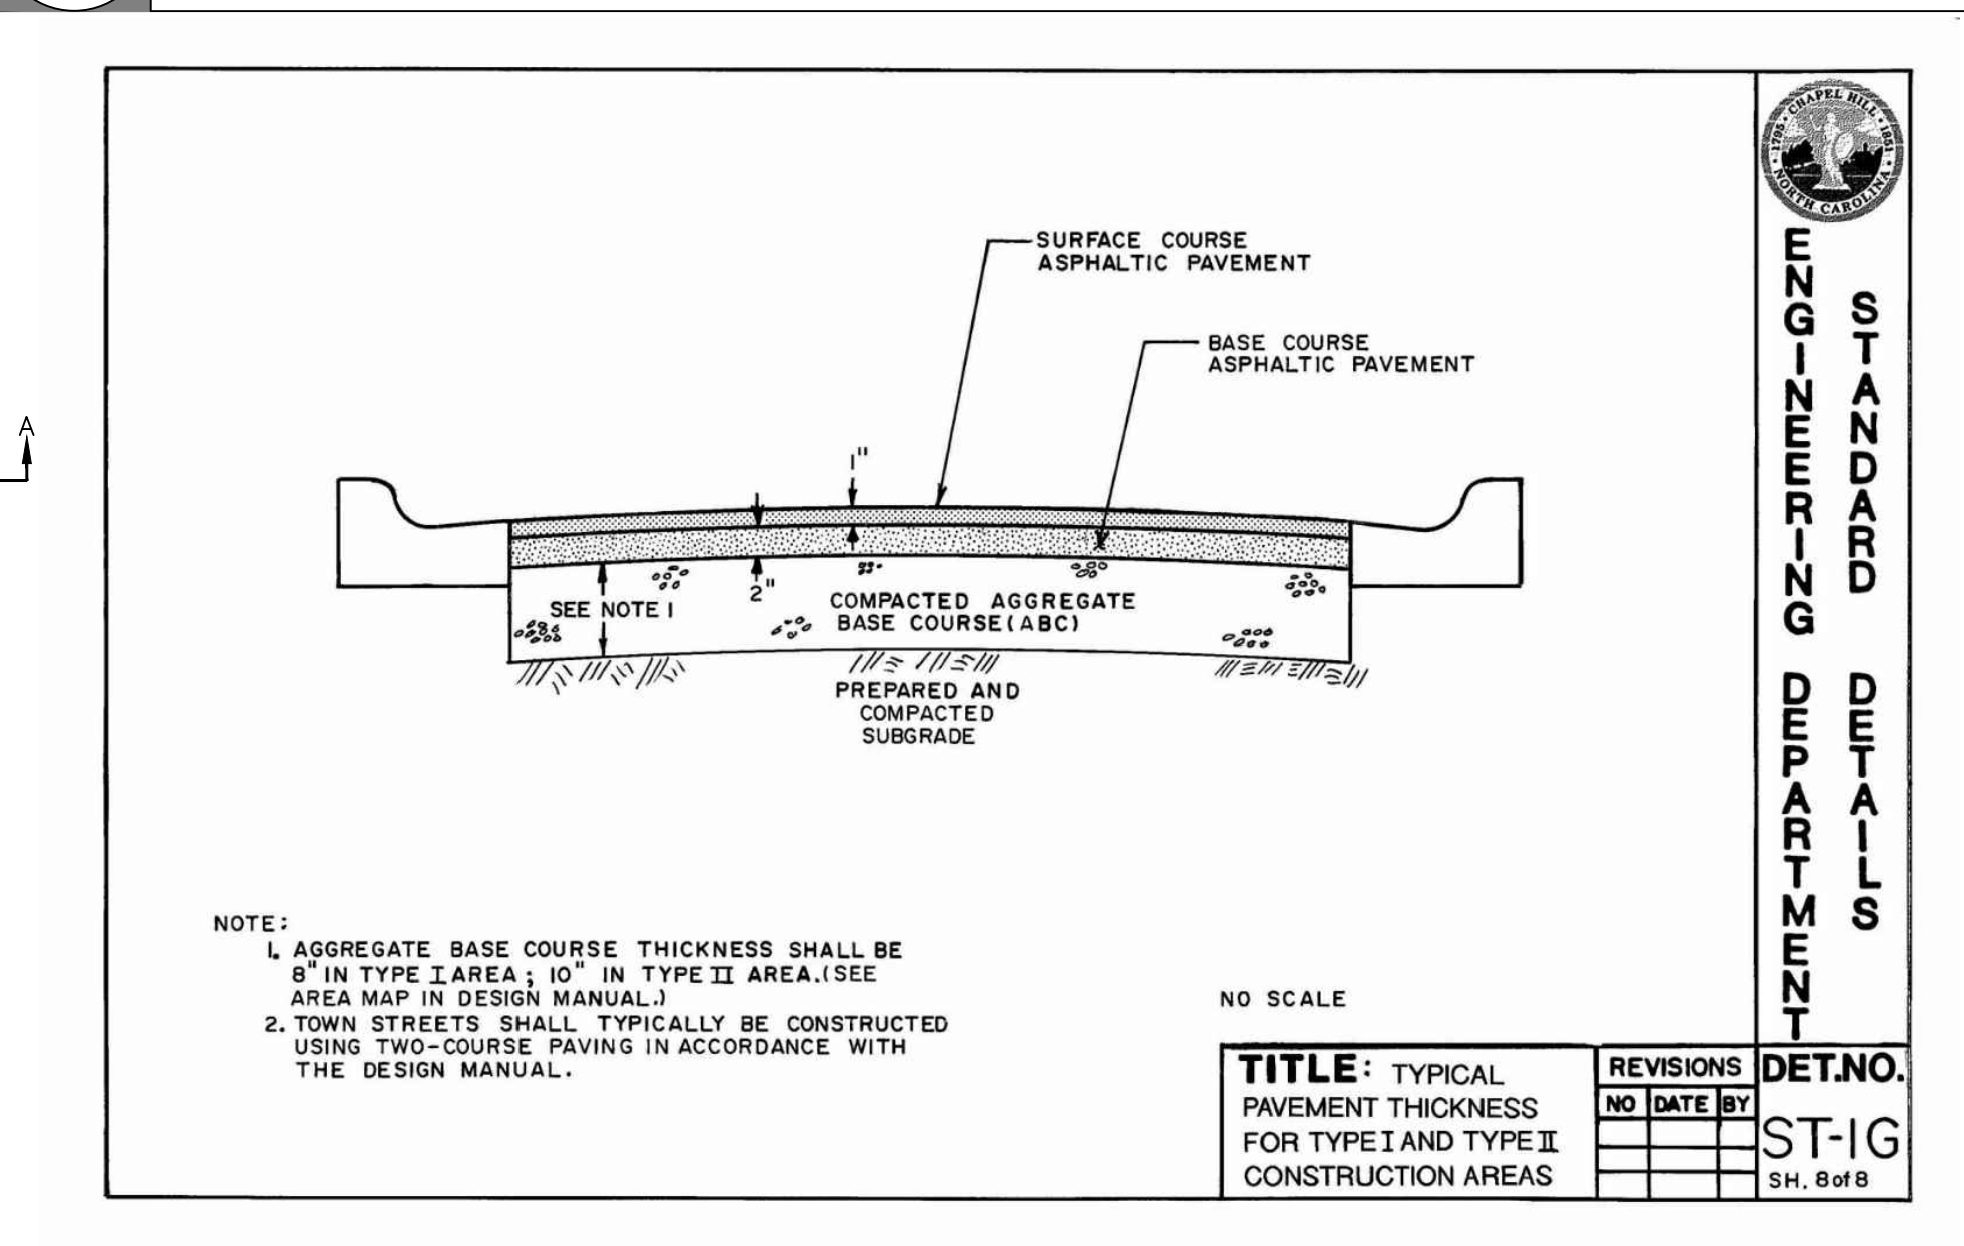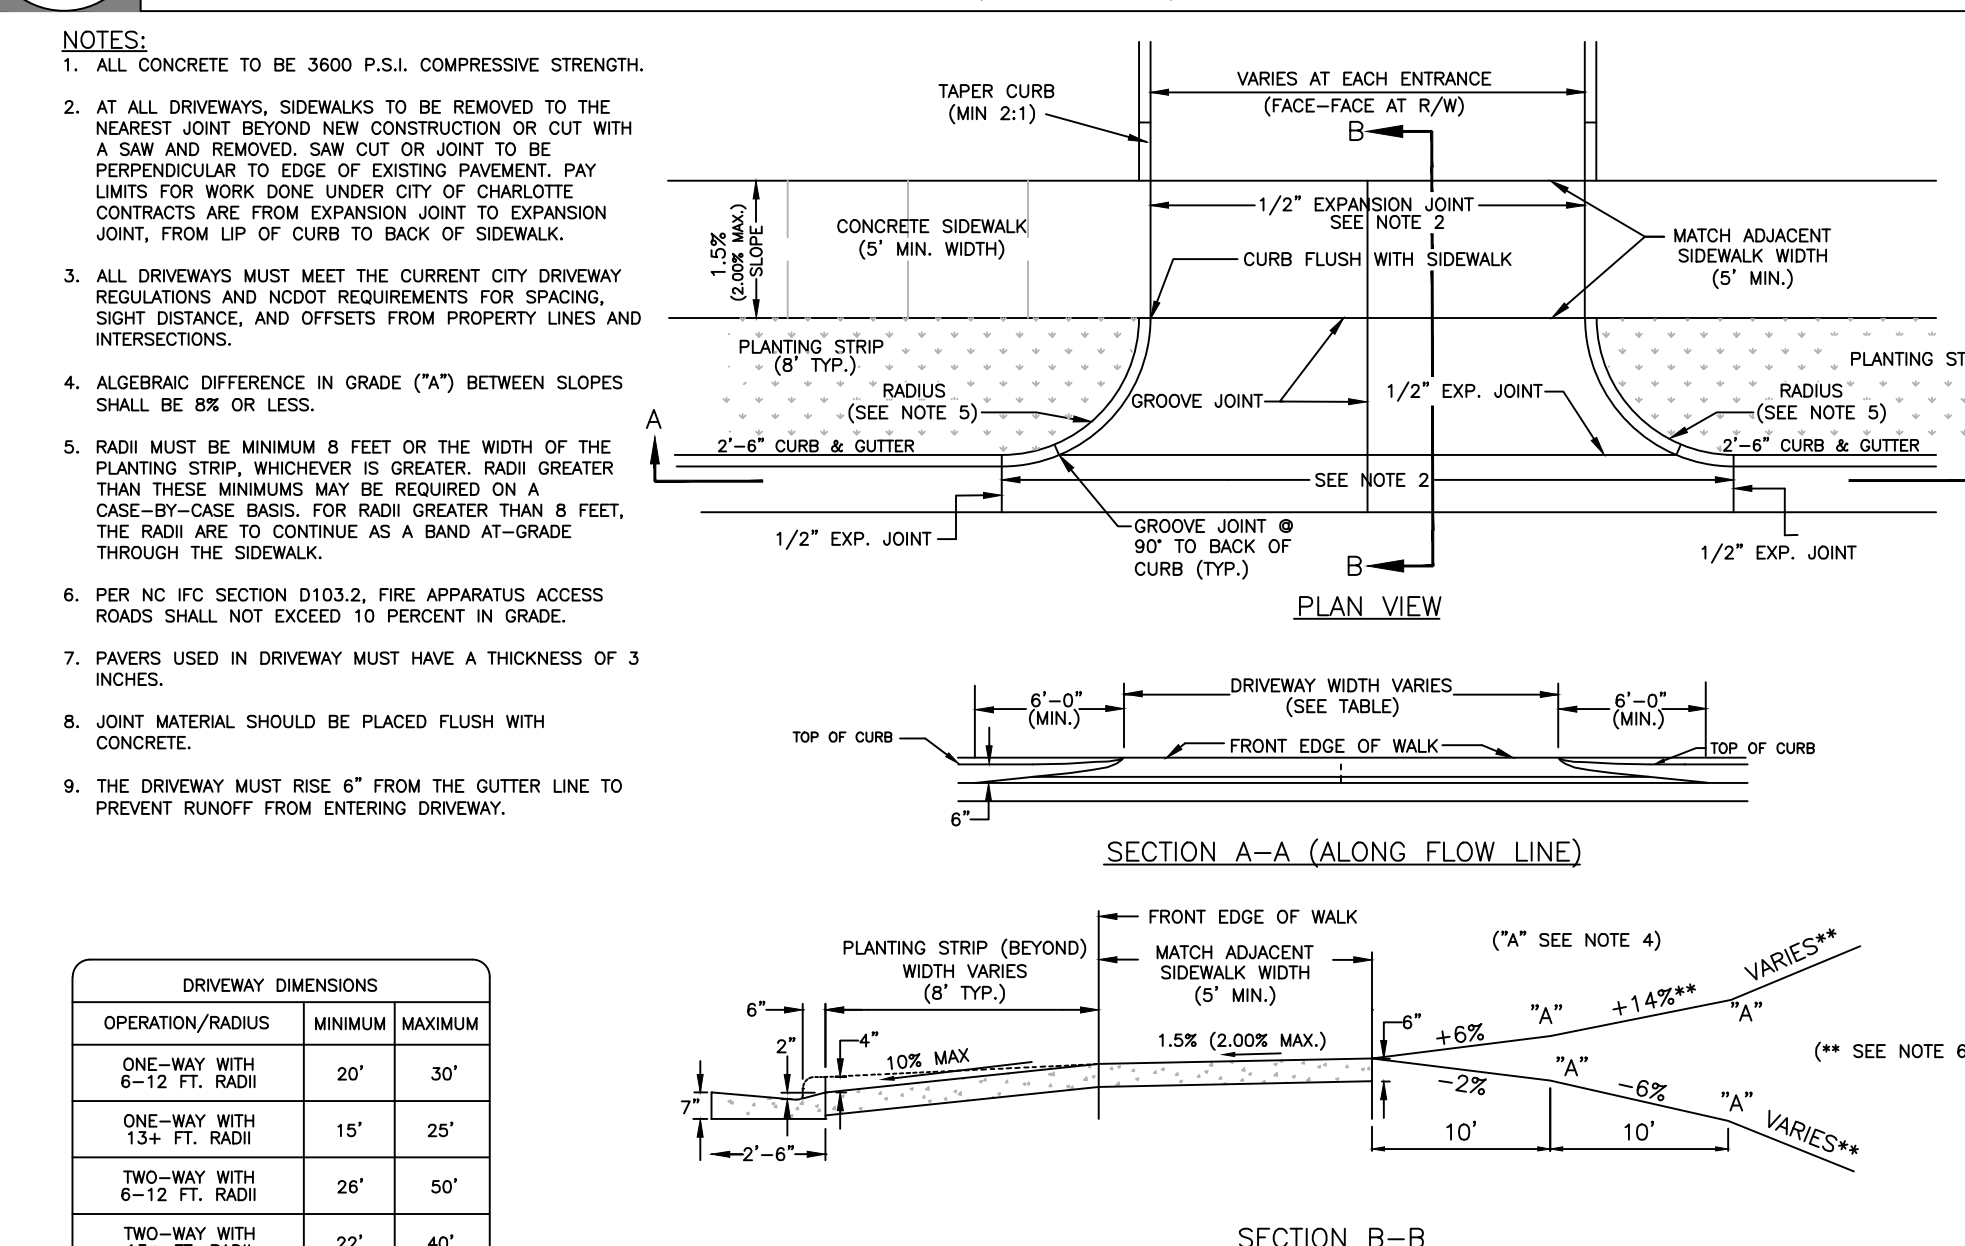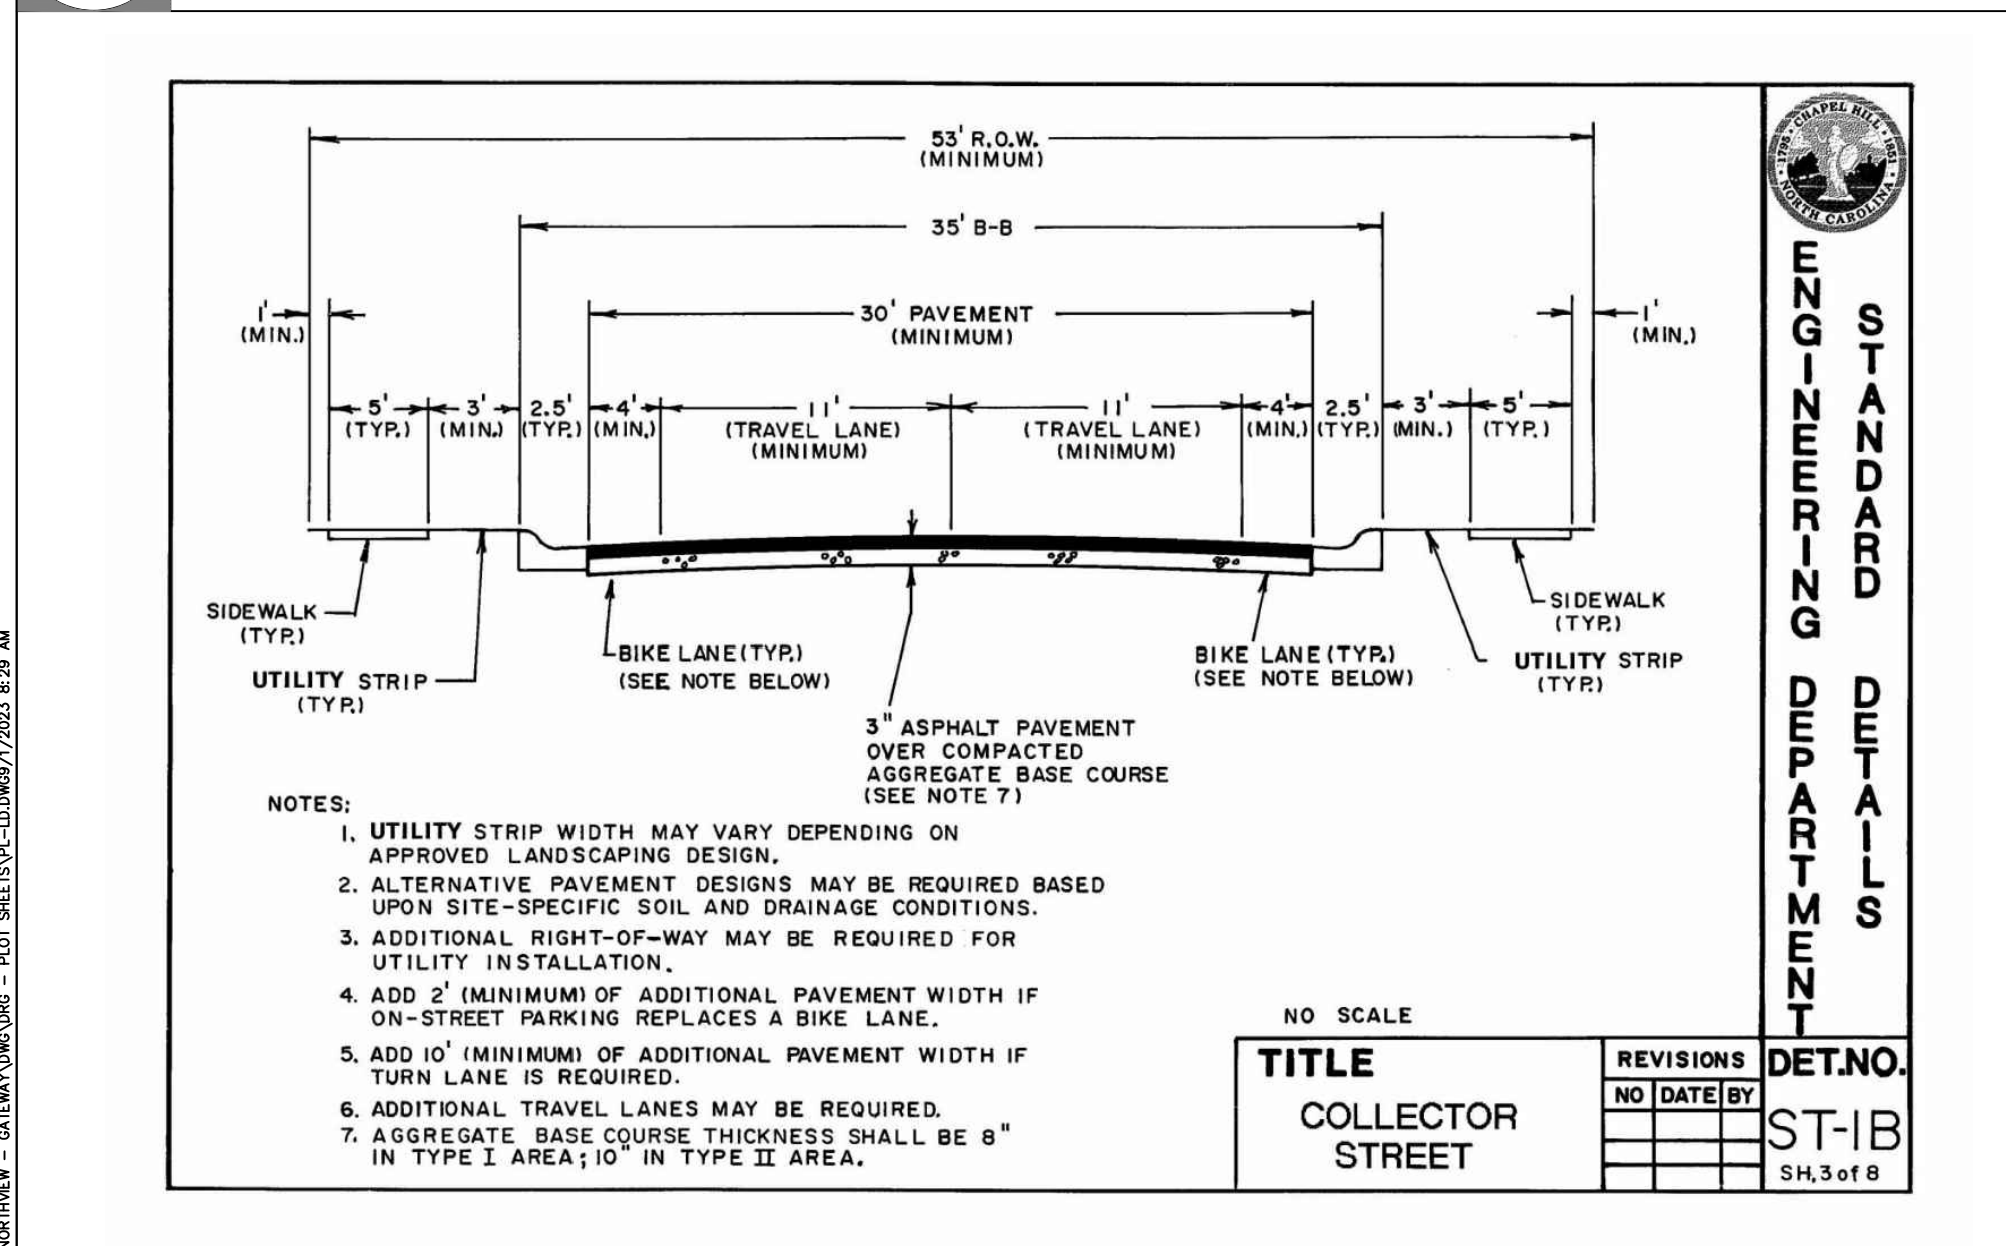

7

TOWN OF CHAPEL HILL, NORTH CAROLINA
DEPARTMENT OF ENGINEERING

COLLECTOR STREET

STD. NO. REV. ST-1B

8

TOWN OF CHAPEL HILL, NORTH CAROLINA
DEPARTMENT OF ENGINEERING

DRIVEWAY DETAIL WITH PLANTING STRIP AND STANDARD CURB

STD. NO. REV. ST-1B

9

TOWN OF CHAPEL HILL, NORTH CAROLINA
DEPARTMENT OF ENGINEERING


TYPICAL PAVEMENT THICKNESS FOR TYPE I AND TYPE II CONSTRUCTION AREAS

STD. NO. REV. ST-1G



LANDSCAPE ARCHITECTURE
CIVIL ENGINEERING
TRANSPORTATION PLANNING

2459 Wilkinson Blvd, Ste 200 Charlotte, NC 28208
704.343.0608
www.drgpr.com

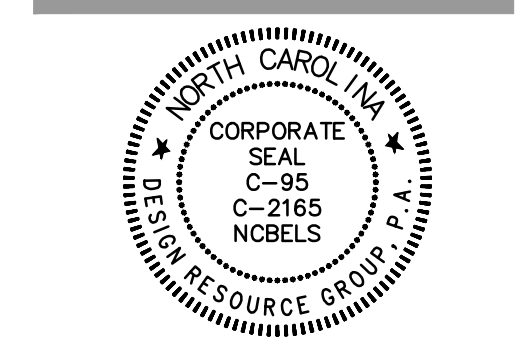

REZONING

GATEWAY APARTMENTS
CHAPEL HILL, NORTH CAROLINA

NORTHVIEW PARTNERS
6131 FALLS OF NEUSE ROAD, SUITE 202
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SITE DETAILS

SCALE: NTS

PROJECT #: 443-023
DRAWN BY: VA
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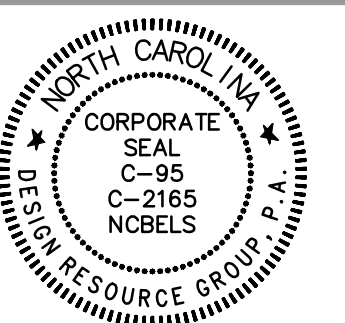
JUNE 8, 2023

REVISIONS:

REVISIONS

NO.	DATE	BY

DET. NO. ST-1G



REZONING

**GATEWAY
APARTMENTS**
CHAPEL HILL, NORTH CAROLINA

NORTHVIEW PARTNERS
6131 FALLS OF NEUSE ROAD, SUITE 202
RALEIGH, NORTH CAROLINA 27609


LANDSCAPE
PLAN

SCALE: 1" = 60'

PROJECT #: 443-023
DRAWN BY: JO
CHECKED BY: SK

JUNE 8, 2023

REVISIONS:

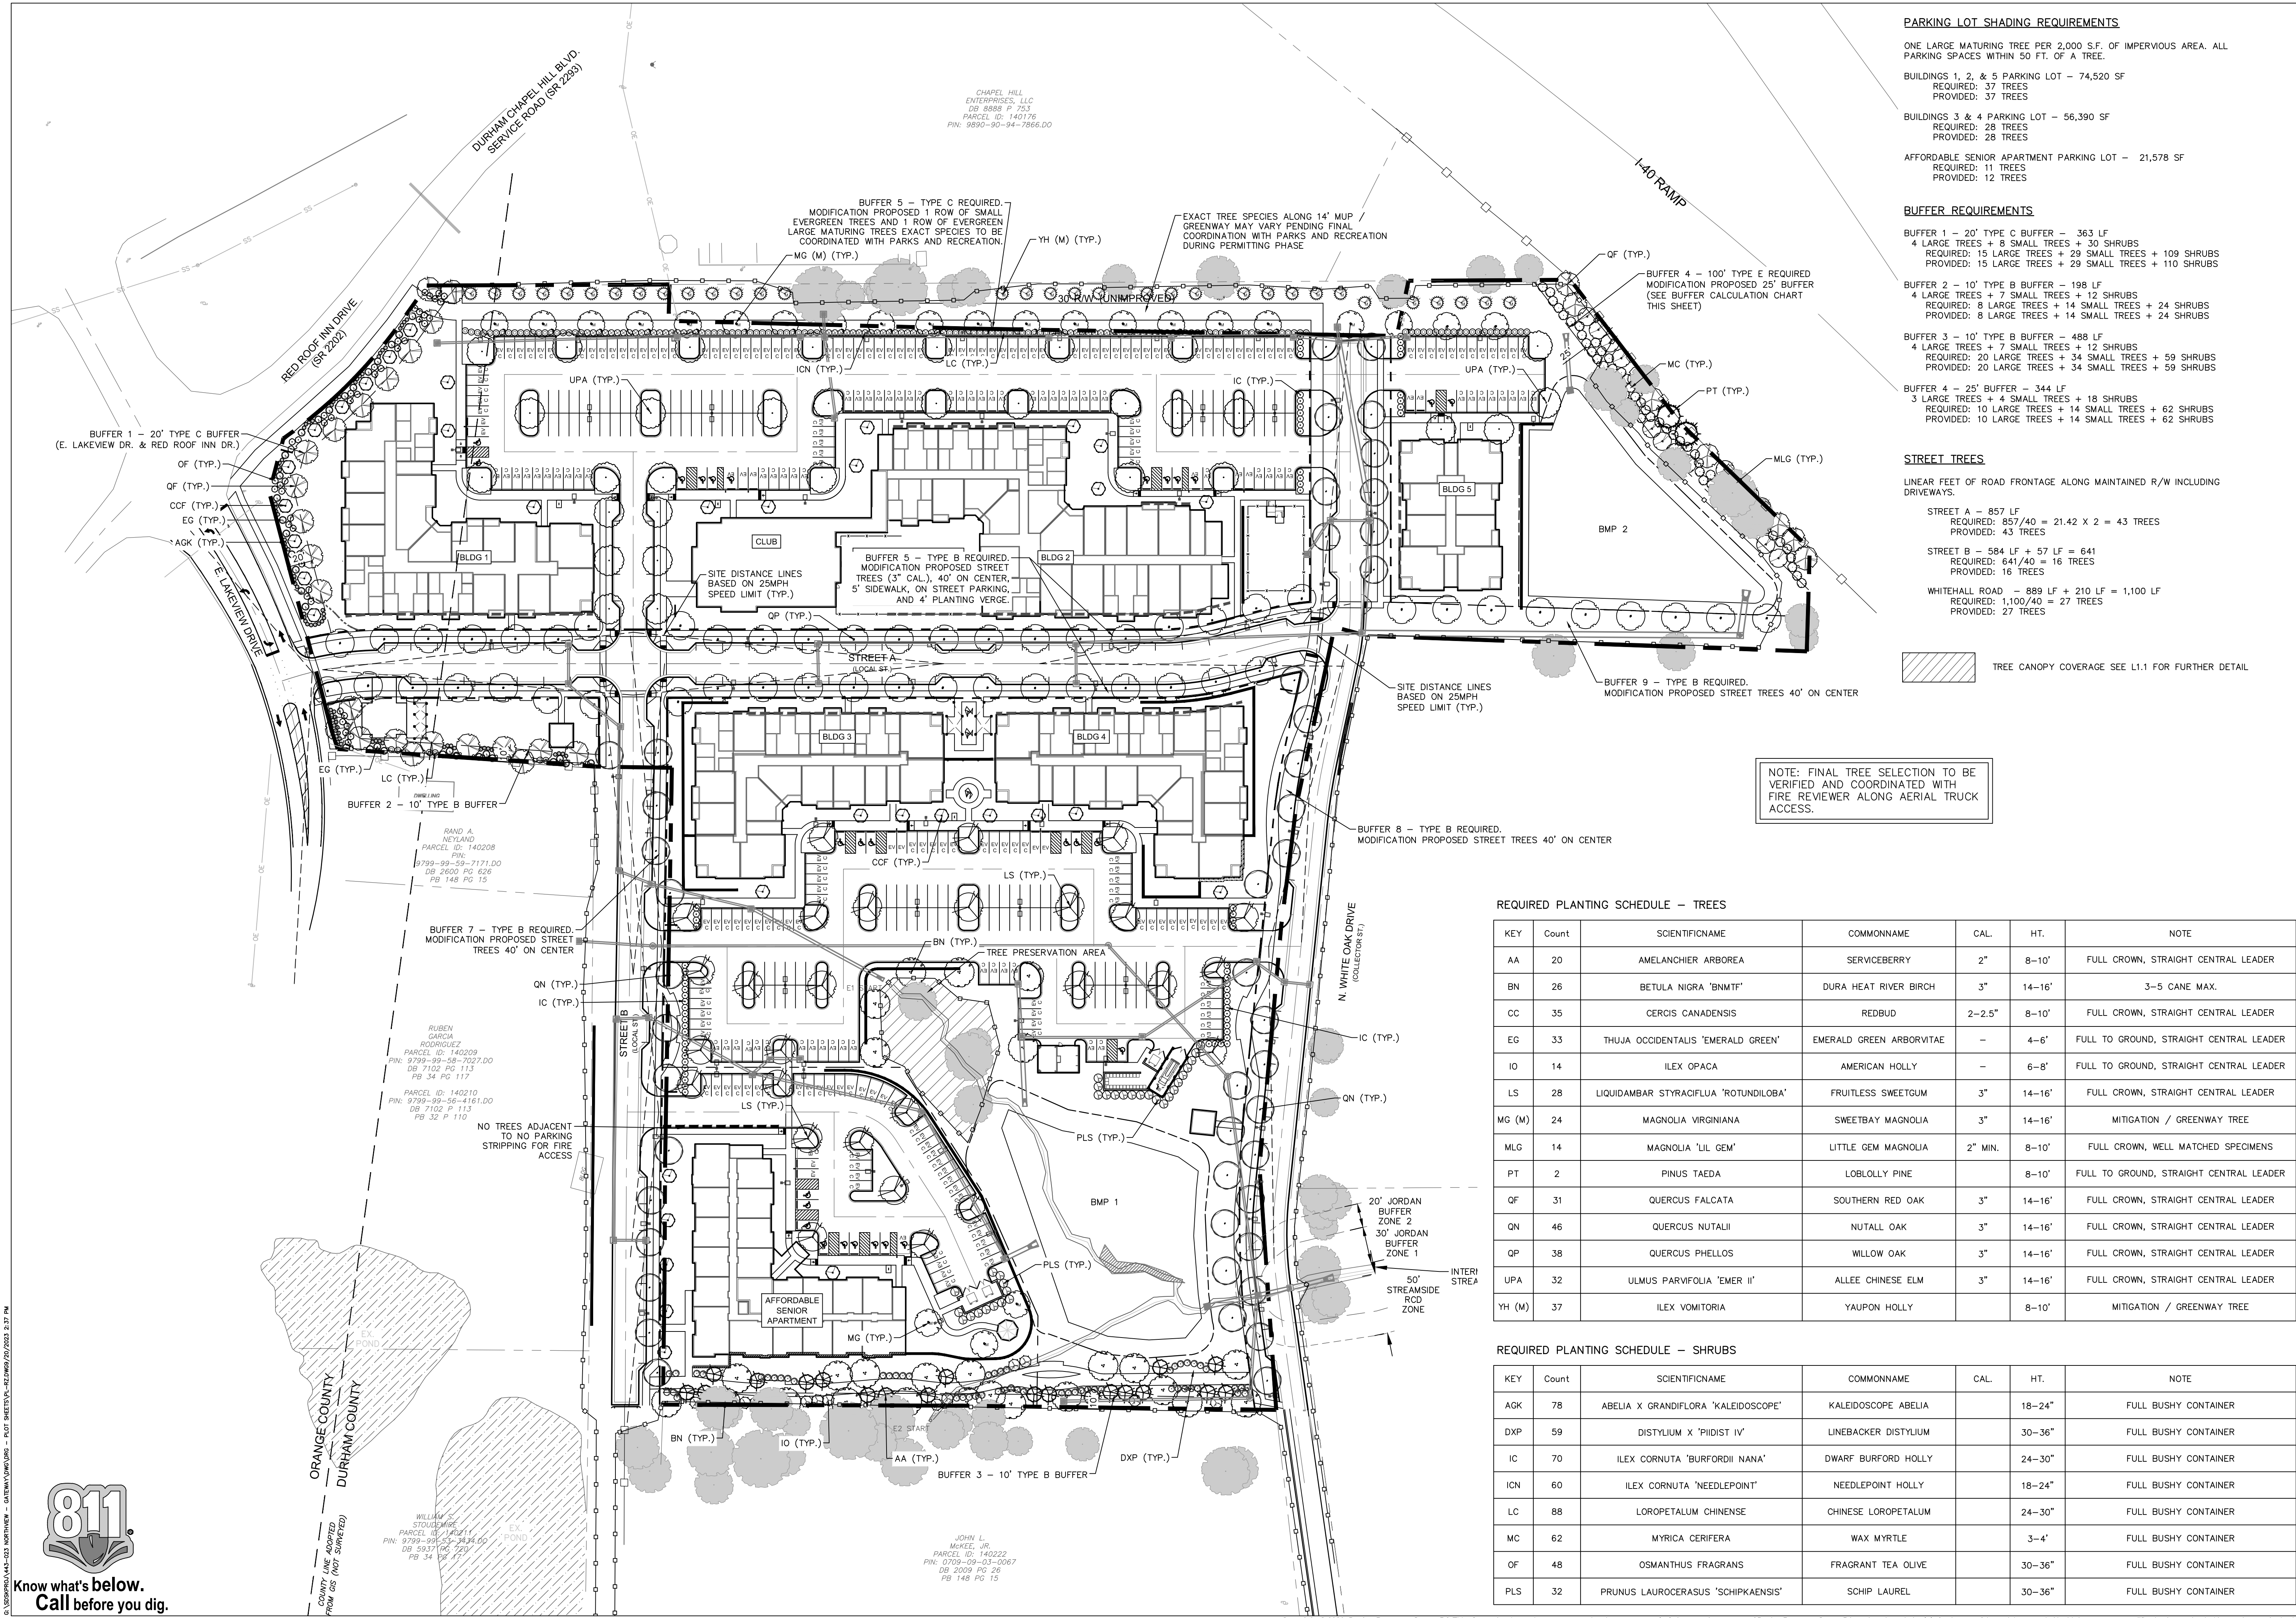

PARKING LOT SHADING REQUIREMENTS

ONE LARGE MATURING TREE PER 2,000 S.F. OF IMPERVIOUS AREA. ALL PARKING SPACES WITHIN 50 FT. OF A TREE.

BUILDINGS 1, 2, & 5 PARKING LOT - 74,520 SF
REQUIRED: 37 TREES
PROVIDED: 37 TREES

BUILDINGS 3 & 4 PARKING LOT - 56,390 SF
REQUIRED: 28 TREES
PROVIDED: 28 TREES

AFFORDABLE SENIOR APARTMENT PARKING LOT - 21,578 SF
REQUIRED: 11 TREES
PROVIDED: 12 TREES

BUFFER REQUIREMENTS

BUFFER 1 - 20' TYPE C BUFFER - 363 LF
4 LARGE TREES + 8 SMALL TREES + 30 SHRUBS
REQUIRED: 15 LARGE TREES + 29 SMALL TREES + 109 SHRUBS
PROVIDED: 15 LARGE TREES + 29 SMALL TREES + 110 SHRUBS

BUFFER 2 - 10' TYPE B BUFFER - 198 LF
4 LARGE TREES + 7 SMALL TREES + 28 SHRUBS
REQUIRED: 8 LARGE TREES + 14 SMALL TREES + 24 SHRUBS
PROVIDED: 8 LARGE TREES + 14 SMALL TREES + 24 SHRUBS

BUFFER 3 - 10' TYPE B BUFFER - 488 LF
4 LARGE TREES + 7 SMALL TREES + 12 SHRUBS
REQUIRED: 20 LARGE TREES + 34 SMALL TREES + 59 SHRUBS
PROVIDED: 20 LARGE TREES + 34 SMALL TREES + 59 SHRUBS

BUFFER 4 - 25' BUFFER - 344 LF
3 LARGE TREES + 4 SMALL TREES + 18 SHRUBS
REQUIRED: 10 LARGE TREES + 14 SMALL TREES + 62 SHRUBS
PROVIDED: 10 LARGE TREES + 14 SMALL TREES + 62 SHRUBS

STREET TREES

LINEAR FEET OF ROAD FRONTAGE ALONG MAINTAINED R/W INCLUDING DRIVEWAYS.

STREET A - 857 LF
REQUIRED: 857/40 = 21.42 X 2 = 43 TREES
PROVIDED: 43 TREES

STREET B - 584 LF + 57 LF = 641
REQUIRED: 641/40 = 16 TREES
PROVIDED: 16 TREES

WHITEHALL ROAD - 889 LF + 210 LF = 1,100 LF
REQUIRED: 1,100/40 = 27 TREES
PROVIDED: 27 TREES


NOTE: FINAL TREE SELECTION TO BE VERIFIED AND COORDINATED WITH FIRE REVIEWER ALONG AERIAL TRUCK ACCESS.

REQUIRED PLANTING SCHEDULE - TREES

KEY	Count	SCIENTIFICNAME	COMMONNAME	CAL.	HT.	NOTE
AA	20	AMELANCHIER ARBOREA	SERVICEBERRY	2"	8-10'	FULL CROWN, STRAIGHT CENTRAL LEADER
BN	26	BETULA NIGRA 'BNMT'	DURA HEAT RIVER BIRCH	3"	14-16'	3-5 CANE MAX.
CC	35	CERCIS CANADENSIS	REDBUD	2-2.5"	8-10'	FULL CROWN, STRAIGHT CENTRAL LEADER
EG	33	THUJA OCCIDENTALIS 'EMERALD GREEN'	EMERALD GREEN ARBORVITAE	-	4-6'	FULL TO GROUND, STRAIGHT CENTRAL LEADER
IO	14	ILEX OPACA	AMERICAN HOLLY	-	6-8'	FULL TO GROUND, STRAIGHT CENTRAL LEADER
LS	28	LIQUIDAMBAR STYRAOFLUA 'ROTUNDILOBA'	FRUITLESS SWEETGUM	3"	14-16'	FULL CROWN, STRAIGHT CENTRAL LEADER
MG (M)	24	MAGNOLIA VIRGINIANA	SWEETBAY MAGNOLIA	3"	14-16'	MITIGATION / GREENWAY TREE
MLG	14	MAGNOLIA 'LIL GEM'	LITTLE GEM MAGNOLIA	2" MIN.	8-10'	FULL CROWN, WELL MATCHED SPECIMENS
PT	2	PINUS TAEDA	LOBLOLLY PINE	-	8-10'	FULL TO GROUND, STRAIGHT CENTRAL LEADER
QF	31	QUERCUS FALCATA	SOUTHERN RED OAK	3"	14-16'	FULL CROWN, STRAIGHT CENTRAL LEADER
QN	46	QUERCUS NUTALLII	NUTALL OAK	3"	14-16'	FULL CROWN, STRAIGHT CENTRAL LEADER
QP	38	QUERCUS PHELLOS	WILLOW OAK	3"	14-16'	FULL CROWN, STRAIGHT CENTRAL LEADER
UPA	32	ULMUS PARVIFOLIA 'EMER II'	ALLEE CHINESE ELM	3"	14-16'	FULL CROWN, STRAIGHT CENTRAL LEADER
YH (M)	37	ILEX VOMITORIA	YAUPON HOLLY	-	8-10'	MITIGATION / GREENWAY TREE

REQUIRED PLANTING SCHEDULE - SHRUBS


KEY	Count	SCIENTIFICNAME	COMMONNAME	CAL.	HT.	NOTE
AGK	78	ABELIA X GRANDIFLORA 'KALEIDOSCOPE'	KALEIDOSCOPE ABELIA	-	18-24"	FULL BUSHY CONTAINER
DXP	59	DISTYLIUM X 'PIDIST IV'	LINEBACKER DISTYLIUM	-	30-36"	FULL BUSHY CONTAINER
IC	70	ILEX CORNUTA 'BURFORDII NANA'	DWARF BURFORDII HOLLY	-	24-30"	FULL BUSHY CONTAINER
ICN	60	ILEX CORNUTA 'NEEDLEPOINT'	NEEDLEPOINT HOLLY	-	18-24"	FULL BUSHY CONTAINER
LC	88	LOROPETALUM CHINENSE	CHINESE LOROPETALUM	-	24-30"	FULL BUSHY CONTAINER
MC	62	MYRICA CERIFERA	WAX MYRTLE	-	3-4'	FULL BUSHY CONTAINER
OF	48	OSMANTHUS FRAGRANS	FRAGRANT TEA OLIVE	-	30-36"	FULL BUSHY CONTAINER
PLS	32	PRUNUS LAUROCERASUS 'SCHIPKAENSIS'	SCHIP LAUREL	-	30-36"	FULL BUSHY CONTAINER

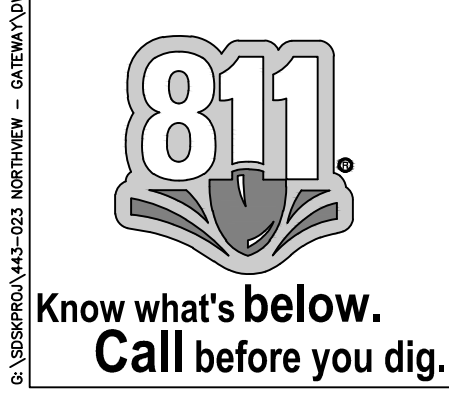

TREE COVERAGE SUMMARY
 EXISTING LAND AREA: 15.37 AC (669,759 SF)
 NET LAND AREA: 13.385 AC (583,048 SF)

TREE COVERAGE REQUIRED: 13.385 X 30% = 4.001 AC (179,916 SF)
 TREE COVERAGE RETAINED: 8,527 SF
 TREE COVERAGE ADDED WITH TREES: 360 NEW TREES X 500 SF = 180,000 SF
 TOTAL TREE COVERAGE PROVIDED: 4.32AC (188,527 SF)

 RETAINED TREE CANOPY COVERAGE

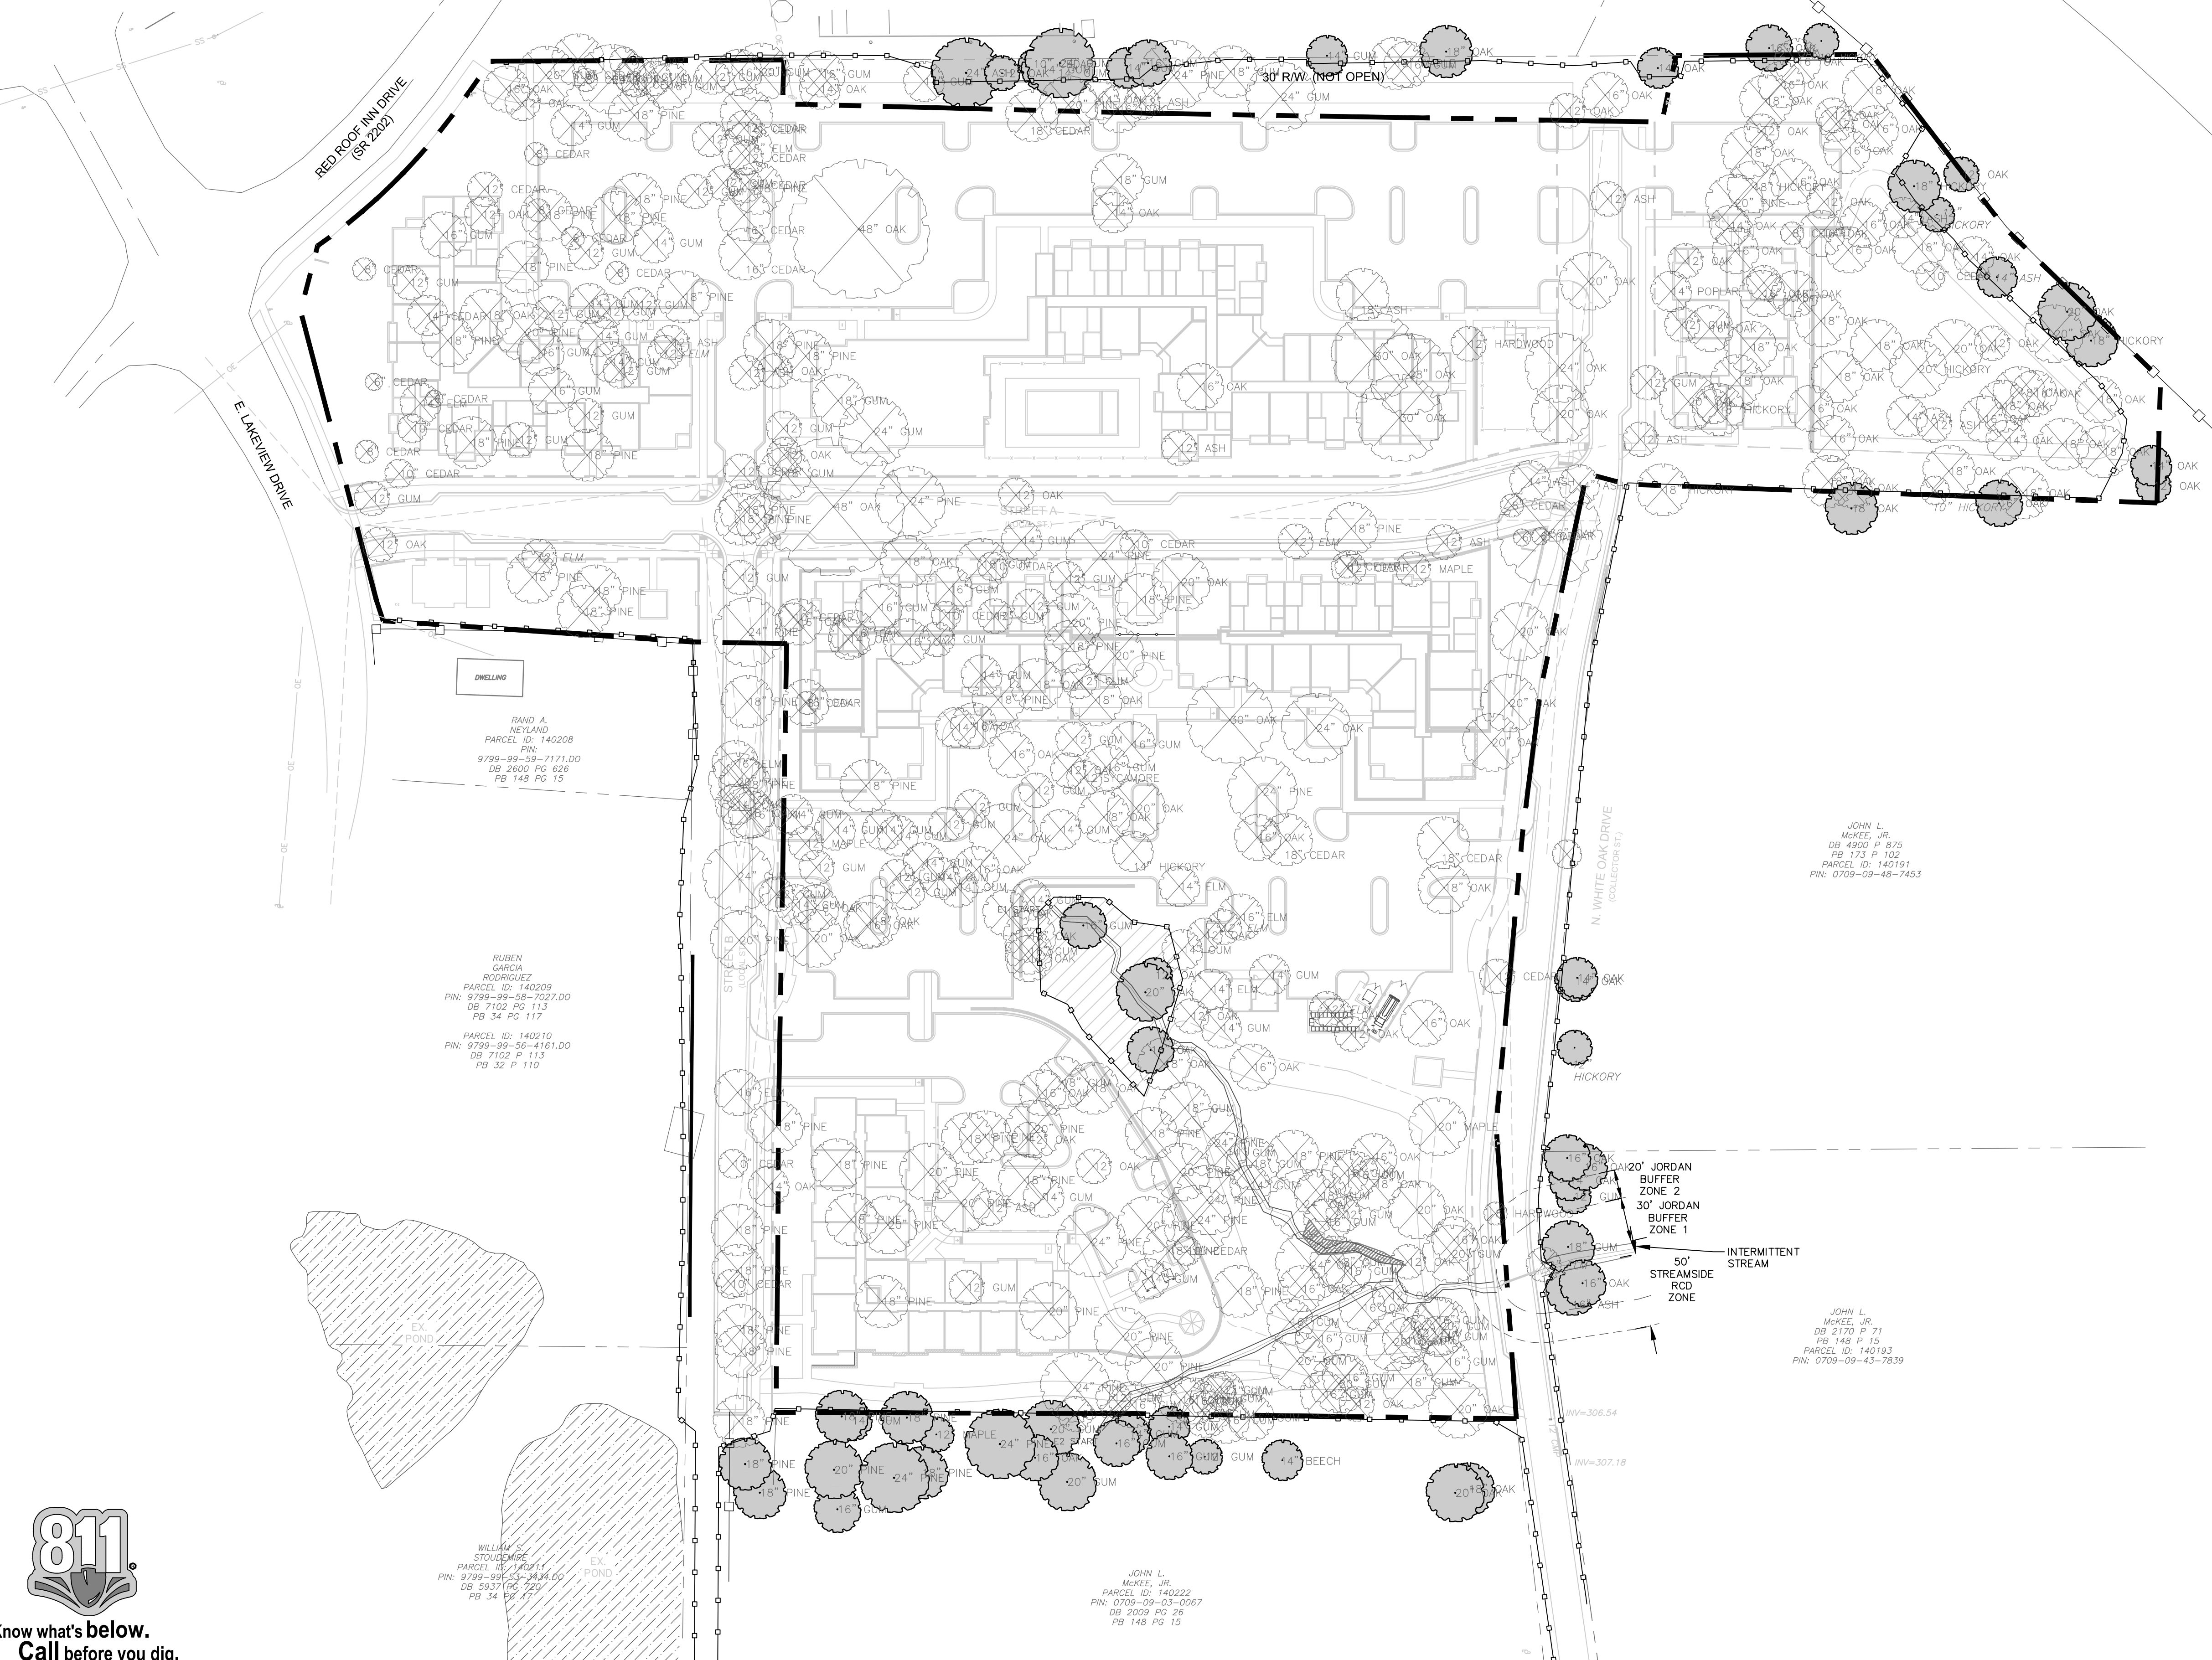

TREE PROTECTION NOTES:

1. PRIOR TO DEMOLITION, CLEARING, CONSTRUCTION, GRADING, AND INSTALLATION OF EROSION CONTROL MEASURES, TREE PROTECTIVE BARRIERS MUST BE INSTALLED AROUND ALL TREE SAVE AREAS BY THE DEVELOPER AND APPROVED BY THE CITY.
2. THE TREE PROTECTION FENCE SHALL BE LOCATED ALONG THE PERIMETER OF THE TREE SAVE AREA (DRIP LINE PLUS 5 FEET). TREE PROTECTION FENCING FOR A FOREST CANOPY STANDS AREA IS TO BE LOCATED ALONG THE PERIMETER OF THE TREE SAVE AREA AROUND THE FOREST EDGE. TREE PROTECTION FENCING SHALL CONSIST OF ORANGE SAFETY FENCING OR A COMBINATION OF ORANGE SAFETY FENCING WITH SILT FENCING AT A MINIMUM OF 4 FEET IN HEIGHT ON METAL OR WOOD POSTS.
3. ALL TREE PROTECTION AREAS MUST BE DESIGNATED AS SUCH WITH "TREE SAVE AREA SIGNS" POSTED IN ADDITION TO THE REQUIRED PROTECTIVE FENCING. SIGNS REQUESTING SUBCONTRACTOR COOPERATION AND COMPLIANCE WITH TREE PROTECTION STANDARDS ARE RECOMMENDED FOR SITE ENTRANCES.
4. NO SOIL DISTURBANCE OR COMPACTION, STOCK PILING OF SOIL OR OTHER CONSTRUCTION MATERIAL, VEHICULAR TRAFFIC, OR STORAGE OF EQUIPMENT AND MATERIALS ARE ALLOWED WITHIN TREE SAVE AREAS.
5. NO ROPES, SIGNS, WIRES, UNPROTECTED ELECTRICAL INSTALLATION OR OTHER DEVICE OR MATERIAL, SHALL BE SECURED OR FASTENED AROUND OR THROUGH A TREE OR SHRUB.
6. ALL PROTECTIVE MEASURES SHALL BE MAINTAINED THROUGHOUT THE LAND DISTURBING AND CONSTRUCTION PROCESS, AND SHALL NOT BE REMOVED UNTIL FINAL LANDSCAPING IS INSTALLED.
7. SEE DETAIL SHEETS FOR TREE PROTECTION, TREE AND SHRUB PLANTING

TREE PLANTING NOTES

- PLANTING MATERIAL**
1. MINIMUM SHADE TREE SIZE AT PLANTING IS 2"-2.5" CALIPER AND 10'-12" TALL AT TIME OF PLANTING. ORNAMENTAL TREES SHALL MEASURE 1.5-2" CALIPER FOR SINGLE-STEM AND 1-1.5" CALIPER FOR ALL MULTI-STEM TREES AND BE A MINIMUM 6'-8" IN HEIGHT AT TIME OF PLANTING.
 2. LARGE SHRUBS, PLANTED FOR SCREENING PURPOSES SHALL MEASURE A MINIMUM OF 3'-3.5' IN HEIGHT AT TIME OF PLANTING. SHRUBS PLANTED FOR SCREENING PURPOSES SHALL FORM A REQUIRED DENSITY TO BLOCK VISIBILITY WITHIN 3 YEARS FROM DATE OF INSTALLATION.
 3. SMALL SHRUBS SHALL MEASURE A MINIMUM OF 18"-24" IN SPREAD AND/OR HEIGHT AT TIME OF PLANTING.
 4. ALL NEW TREES MUST HAVE STRAIGHT TRUNKS WITH STRONG CENTRAL LEADERS INTACT TO THE TOP OF THE CROWN UNLESS MULTI-STEM TREES ARE SPECIFIED. ALL REQUIRED TREES SHALL BE TYPICAL OF THEIR SPECIES AND VARIETY, HAVE NORMAL GROWTH HABITS, HAVE WELL-DEVELOPED BRANCHES, BE VIGOROUS AND HAVE FIBROUS ROOT SYSTEMS. TREES WITH MAJOR GIRDLING ROOTS WILL NOT BE ACCEPTED. TREES WITH CO-DOMINANT BRANCHING WILL NOT BE ACCEPTED. TREES THAT HAVE BEEN SHEARED, TOPPED OR CUT BACK TO MULTIPLY THE BRANCHING STRUCTURE WILL NOT BE ACCEPTED. TREE SHALL BE FREE OF ABRASIONS, DAMAGE, DISEASE, PESTS AND CRACKS. ALL PRUNING CUTS GREATER THAN 1/2 INCH DIAMETER SHALL HAVE CALLUS TISSUE FORMED PRIOR TO PLANTING. NO PRUNING OUT ON THE TRUNK SHALL BE MORE THAN ONE-HALF THE DIAMETER OF THE CENTRAL LEADER AT THE HEIGHT WHERE THE CUT IS MADE. ROOT FLARES SHALL BE LOCATED AT GRADE. TREES WITH MORE THAN 2" OF SOIL COVERING ROOT BALL/FLARE WILL NOT BE ACCEPTED.
 5. SIZE OF REQUIRED PLANTS, SPREAD OF ROOTS AND SIZE OF BALLS SHALL BE IN ACCORDANCE WITH ANSI Z60.1 (LATEST EDITION) AS PUBLISHED BY THE AMERICAN NURSERY & LANDSCAPE ASSOCIATION EXCEPT WHERE SPECIFIED/AUTHORIZED BY THE ADMINISTRATOR.
 6. ALL REQUIRED TREES OF A PARTICULAR SPECIES AND VARIETY SHALL BE UNIFORM IN SIZE AND CONFIGURATION.
 7. THE PRESENCE OF OVERHEAD POWER LINES REQUIRES STREET YARD TREES TO BE ORNAMENTAL TREES. LARGER SHADE TREE VARIETIES ARE ENCOURAGED WHERE OVERHEAD POWER LINES ARE NOT PRESENT.

PLANTING REQUIREMENTS

8. SEE DETAIL SHEETS FOR TREE AND SHRUB PLANTING DETAILS.
9. DETAIL HOSE PARTS WILL NOT BE ACCEPTED FOR TREE STAKING.
10. ALL STRAPPING, AND TOP 1/3 OF WIRE BASKET AND BURLAP MUST BE CUT AWAY AND REMOVED FROM ROOT BALL WHEN PLANTING.
11. FOR NEW PLANTING AREAS, REMOVE ALL PAVEMENT, GRAVEL SUB-BASE AND CONSTRUCTION DEBRIS; REMOVE COMPACTED SOIL AND ADD 18" NEW TOPSOIL, OR TILL AND AMEND THE TOP 18" OF EXISTING SOIL TO MEET TOPSOIL/PLANTING MIX STANDARDS FOR TREES.
12. TREES PLANTED IN NCDOT RIGHT-OF-WAY WILL NEED APPROVAL FROM NCDOT.
13. IF ANY UTILITY IS BEING INSTALLED IN OR NEAR ANY REQUIRED TREE(S), CALL LANDSCAPE ARCHITECT TO RESOLVE PRIOR TO UTILITY INSTALLATION.
14. LARGE MATURING TREES MAY NOT BE PLANTED WITHIN 25' OF OVERHEAD POWER DISTRIBUTION OR TRANSMISSION LINES.
15. IF TREES CONFLICT WITH ANY UTILITIES OR SIGNS, CALL LANDSCAPE ARCHITECT TO RESOLVE BEFORE PLANTING.
16. ADJUST TREE PLANTING LOCATIONS TO AVOID EXISTING UNDERGROUND UTILITIES. PLANT 15' FROM ALL UNDERGROUND UTILITIES.

AMENDED SOIL (AS):

1. PREPARING THE EXISTING SOIL FOR PLANTING BY TILLING TO A DEPTH OF 18", AND ADDING SOME NEW PLANTING MIX AND/OR ORGANIC MATTER. THIS OPTION MAY ALSO REQUIRE THE REMOVAL OF SOME EXISTING SOIL ALONG WITH OTHER MITIGATION WORK AND SOIL AMENDMENTS TO IMPROVE SOIL STRUCTURE.
2. REMOVING ALL EXISTING SOIL FROM A TREE ORDINANCE PROTECTED/REQUIRED PLANTING AREA AND REPLACING IT WITH NEW PLANTING MIX AND OTHER SOIL AMENDMENTS.

PLANTING MIX USED FOR AMENDED SOIL SHALL HAVE UNIFORM COMPOSITION THROUGHOUT, WITH A MIXTURE OF SUBSOIL. IT SHALL BE FREE OF STONES, LUMPS, LIVE PLANTS AND THEIR ROOTS, STICKS, AND OTHER EXTRANEOUS MATTER. IT SHALL CONTAIN NO MAN-MADE MATERIALS UNLESS OTHERWISE SPECIFIED. PLANTING MIX SHALL NOT BE USED WHILE IN A FROZEN OR MUDDY CONDITION.

UNLESS OTHERWISE SPECIFIED IN THE CONTRACT DOCUMENTS, NEW/ADDED PLANTING MIX SHALL CONTAIN THE FOLLOWING SPECIFIED PERCENTAGES OF CONSTITUENTS:

CLAY	MIN. 10%/MAX. 40%
SAND	MIN. 20%/MAX. 50%
SILT	MIN. 20%/MAX. 50%
ORGANIC MATTER	MIN. 5%/MAX. 10%

ORGANIC MATTER IS DEFINED AS COMPOST/HUMUS SUCH AS SAWDUST OR LEAF MOLD THAT HAS COMPLETED THE DECOMPOSITION PROCESS. PERCENTAGE OF ORGANIC MATTER SHALL BE DETERMINED BY LOSS ON IGNITION OF MOISTURE FREE SAMPLES DRIED AT 65 DEGREES.

AMENDED SOIL SHALL HAVE AN ACIDITY RANGE OF PH 5.5 TO 7.0.


AMENDED SOIL SHALL HAVE A CATION EXCHANGE CAPACITY (CEC) FROM 5 TO 25 CMOL +/KG(MEQ/100G)

AMENDED SOIL SHALL HAVE NORMAL CONTENTS OF NITROGEN, PHOSPHORUS, POTASSIUM, CALCIUM, MAGNESIUM, SULFUR, AND PROPER MICRONUTRIENT LEVELS. NUTRIENT LEVELS MUST SATISFY GROWING NEEDS (AS RECOMMENDED BY LAB REPORT) OF THE EXISTING OR PLANNED PLANT MATERIAL.

LAB TESTING MAY BE REQUIRED TO VERIFY THE QUALITY OF EXISTING SOILS, AS AND OTHER SOIL AMENDMENTS.




LANDSCAPE ARCHITECTURE
 CIVIL ENGINEERING
 TRANSPORTATION PLANNING
 2459 Wilkinson Blvd, Ste 200 Charlotte, NC 28208
 704.343.0608
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REZONING

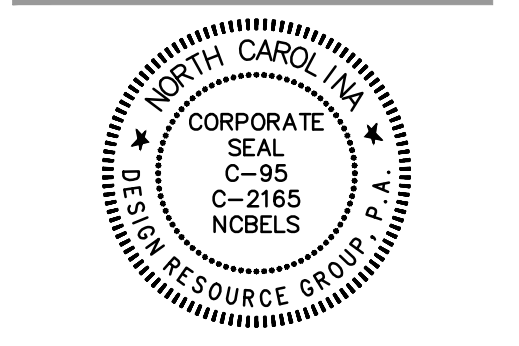GATEWAY APARTMENTS
 CHAPEL HILL, NORTH CAROLINA
NORTHVIEW PARTNERS
 6131 FALLS OF NEUSE ROAD, SUITE 202
 RALEIGH, NORTH CAROLINA 27609

LANDSCAPE PROTECTION PLAN & NOTES




PROJECT #: 443-023
 DRAWN BY: JO
 CHECKED BY: SK

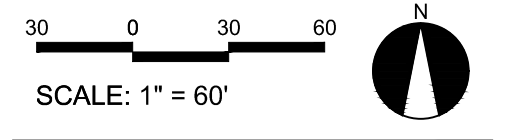JUNE 8, 2023

REVISIONS:



23/07/2023 10:57:53 AM USER: JAMES.LONG DRAWN: 2023/07/20 10:57:53 AM PROJECT: CONSTRUCTION MANAGEMENT PLAN - 140222 - 24/07/2023

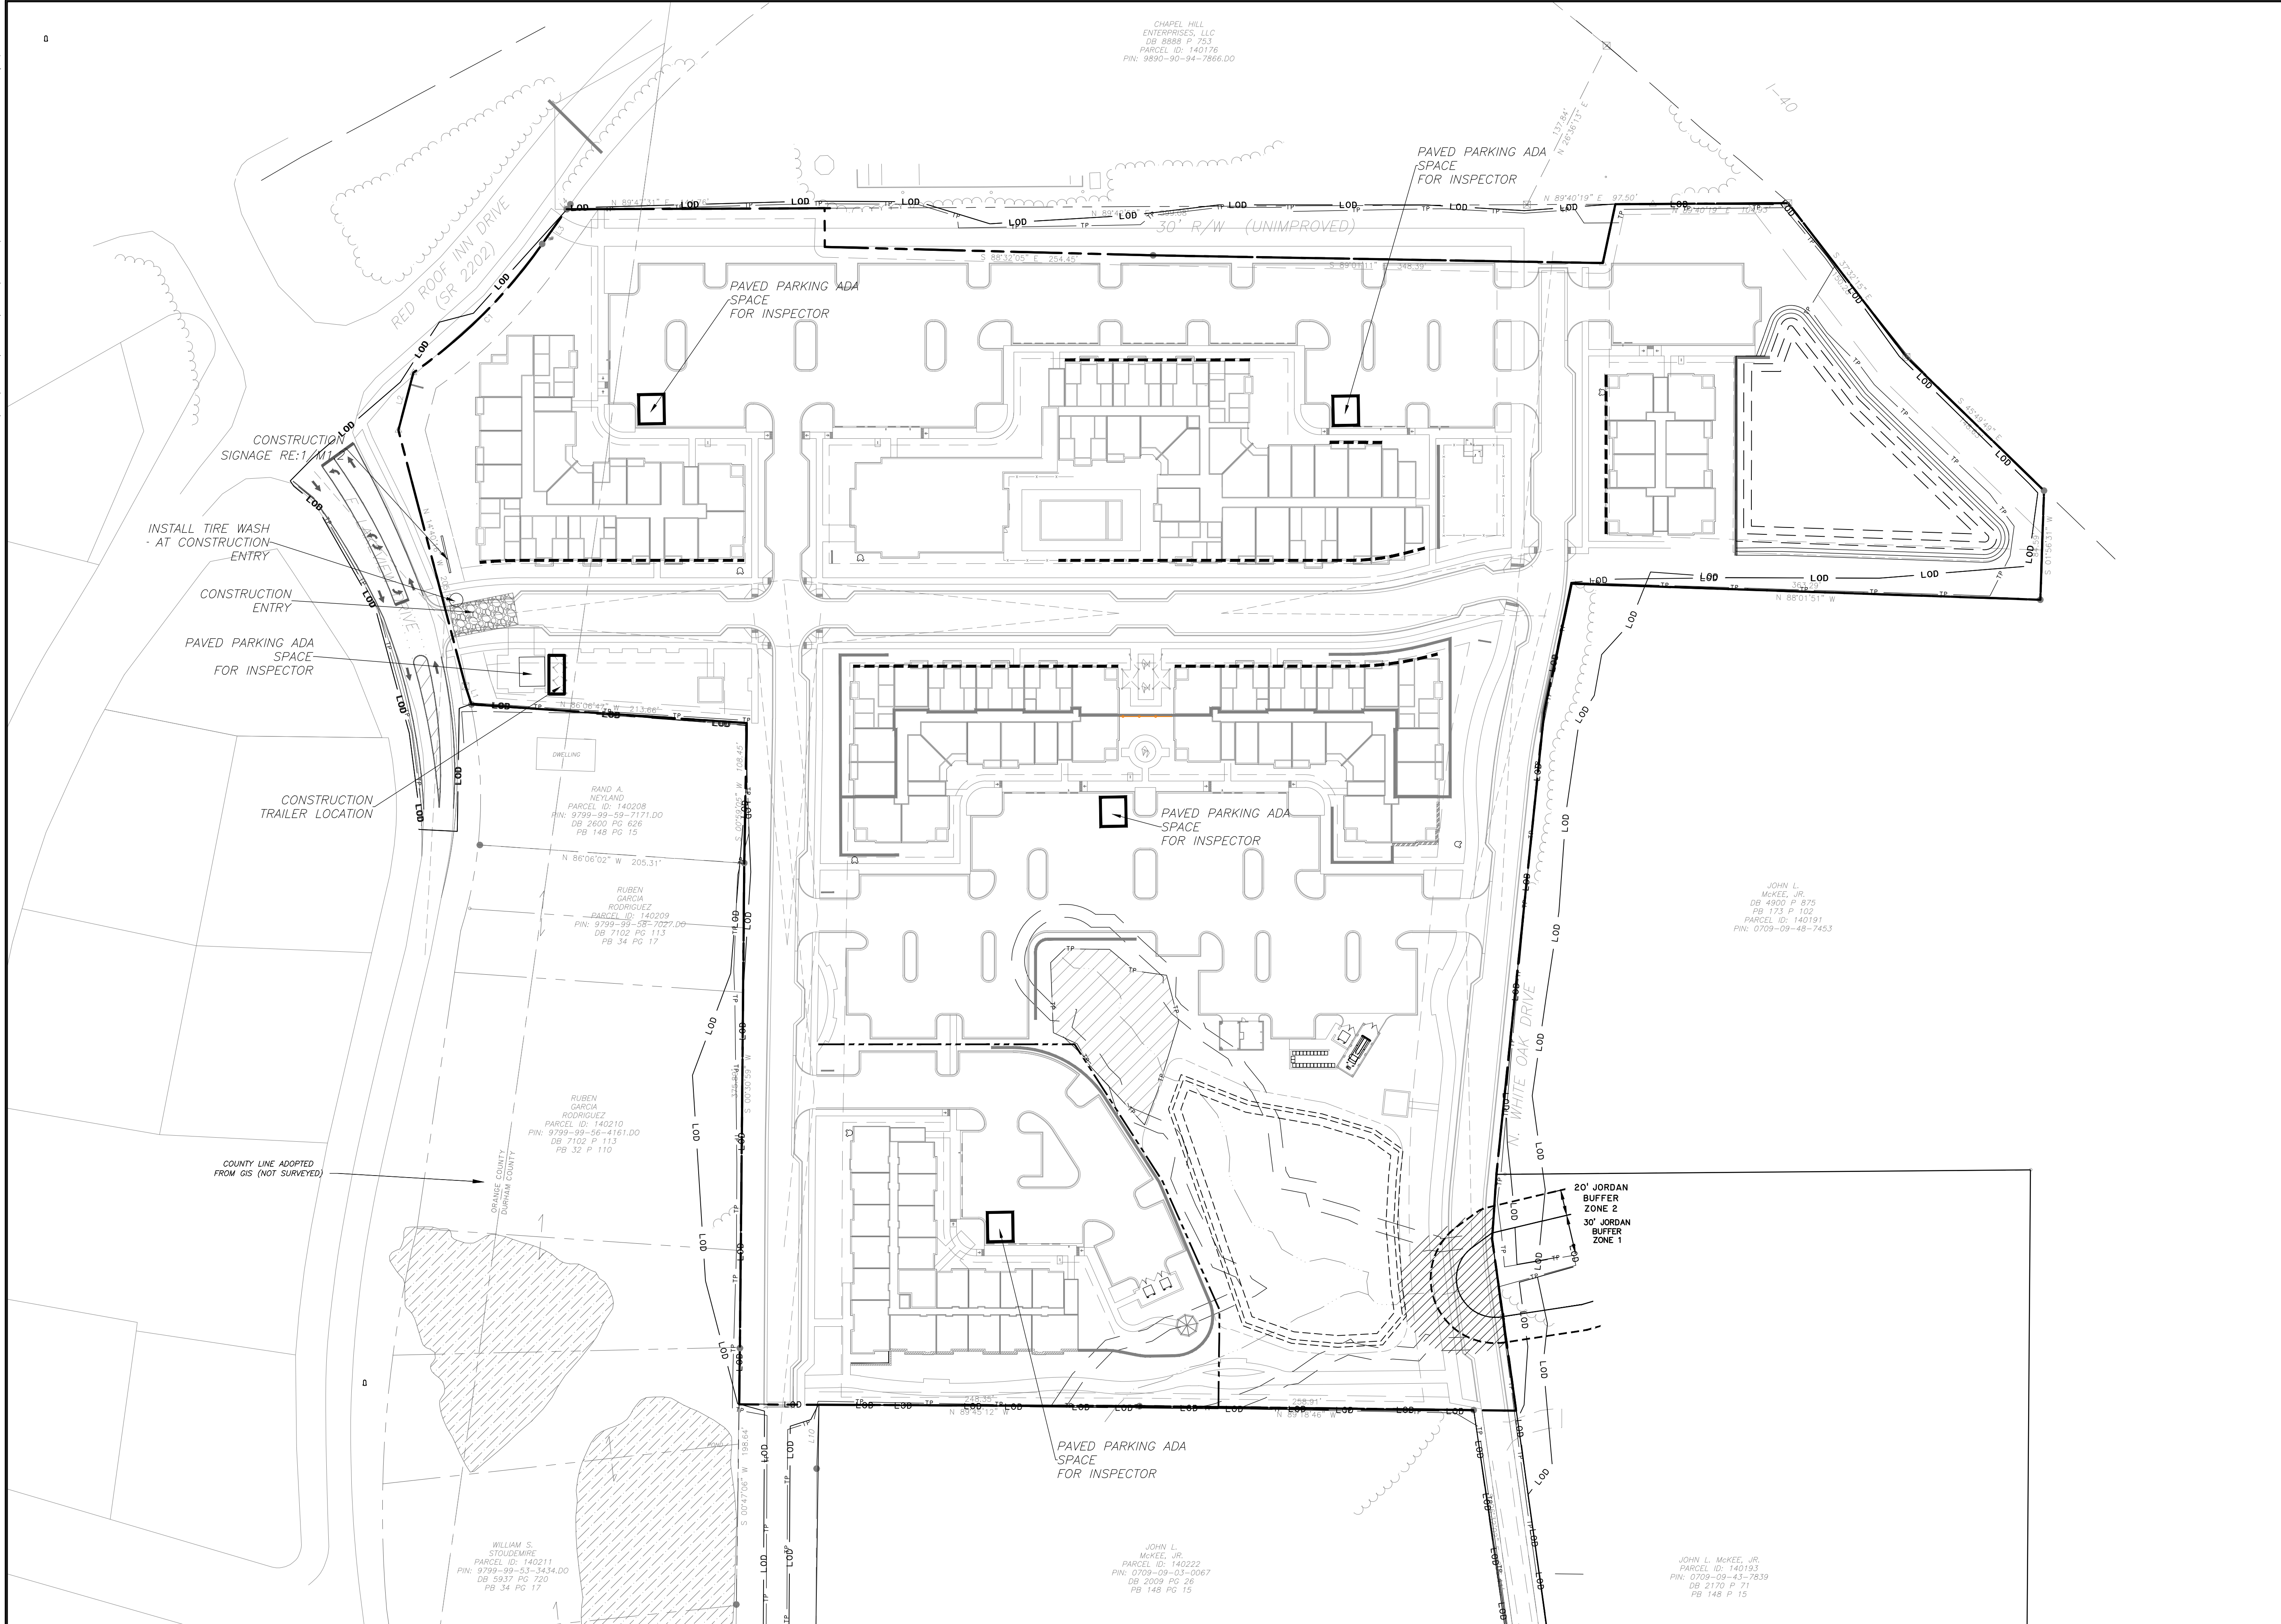

NO.	REVISIONS	BY	DATE
3	SUBMITAL #4	TBH	9/20/2023
2	SUBMITAL #3	TBH	9/1/2023
1	SUBMITAL #2	TBH	7/31/2023
	INITIALS/SUBMITAL	TBH	6/8/2023

NO.	REVISIONS	BY	DATE



THOMAS & HUTTON

111 W. MAIN STREET
DURHAM, NC 27701
919.682.0368
www.thomasandhutton.com

CONSTRUCTION MANAGEMENT

GATEWAY

PROJECT LOCATION:
East Lakeview Drive
Chapel Hill, NC

CLIENT/OWNER:
NorthView Partners



DATUM: HORIZ: VERT:

JOB NO:	30773.0001
DATE:	
DRAWN:	AMO
DESIGNED:	
REVIEWED:	
APPROVED:	
SCALE:	1" = 60'

M1.1

