## **COLUMBIA STREET ANNEX**

### 1150 SOUTH COLUMBIA STREET, CHAPEL HILL, NC 27514

**SPECIAL USE PERMIT APPLICATION - 2018/20** 

#### PROJECT DATA

FYISTING LISE

PROPOSED USE USE GROUP

EXISTING LAND AREA

131,340.04 SF — PARCEL 1 14,228.80 SF — PARCEL 2 8,453.88 SF — PARCEL 3 6.967.75 SF - MONROE ST R/W 160,990.47 SF TOTAL NET LAND ARE

MIXED USE - RESIDENTIAL, COMMERCIAL, RETAIL

VACANT RESIDENTIAL

POST RECOMBINATION AREAS: 3.69 ACRES. NET 35,935 SF net 38,618 SF net 34,668 SF net 51,769 SF net LAND AREA IN RCD streamside zone

GROSS LAND AREA 177,090 SF / 4.065 ACRES

1.64 ACRES NET / 1.804 AC GROSS

DISTURBED AREA 1.64 ACRES FXISTING ZONING R-2

K-2 MU-V  $1.2 \times 86,437 = 103,724 \text{ s}$   $0.01 \times 35,935 = 359 \text{ sf}$ 

104,817 SF

MAXIMUM BUILDING SIZE

BASED ON GROSS LAND AREA N/A 57,000 SF residential PROPOSED BUILDING SIZE

4,000 SF general business maximum 61,000 SF total (incl mechanical, excl underground parking

RESIDENTIAL: maximum 52 UNITS TOTAL (15% WILL BE DESIGNATED AFFORDABLE)

REQUIRED PARKING BASED ON MAXIMUM BLDG SIZE

MIN 65 SPACES, MAX 111 SPACES 69 SPACES INCLUDING: 3 VAN ACCESSIBLE ADA (all in underground parking)

21 STANDARD SURFACE SPACES
11 UNDERGROUND SPACES INCLUDING APPROX. 4 COMPACT
28 UNDERGROUND GARAGE (DOUBLE STACKED)

PROPOSED CAR CHARGING STATIONS 1 LOCATED IN UNDERGROUND GARAGE SERVING 2 SPACES (3% OF PARKING

GENERAL BUSINESS: 4 + 2 per 2500 sf = 6 SPACES REQUIRED BICYCLE PARKING

(20% CLASS | AND 80% CLASS || )
RESIDENTIAL: 1 per 4 units = 13 SPACES
(90% CLASS | AND 10% CLASS || )

minume

TOTAL BIKE PARKING REQUIRED WILL MEET LUMO REQUIREMENT LOCATIONS: UNDERGROUND PARKING, SURFACE PLAZA, IN RESIDENTIAL UNITS PROPOSED BICYCLE PARKING

134,000 SF = 80.8% OF SITE EXISTING TREE CANOPY 40% = 58,724 SF CALCULATION ON SHEET SUP-7.0 66,331 SF (EXISTING RETAINED COVERAGE) REQUIRED TREE CANOPY PROPOSED TREE CANOPY


0.046 RSR GROSS LOT AREA IS 177,090 SF PROJECT AREA IS 71,450 SF RESIDENTIAL PERCENTAGE OF PROJECT IS 93.4%


PROJECT AREA × RECREATION MULTIPLIER × PERCENTAGE RESIDENTIAL = 71,450 × .046 × .934 = 3,070 SF PAYMENT IN LIEU IS \$12/SF

3,070 SF ACTIVE RECREATION SPACE PROVIDED AS FITNESS CENTER IN THE BUILDING FOR TENANTS

SHORTFALL IN FINAL INTERIOR FITNESS SPACE SQUARE FOOTAGE WILL BE MADE UP AS

mmm 4,000 SF GENERAL BUSINESS 1 SPACE/300 SF TO 1 SPACE /200 SF = 13 MIN 20 MAX 52 RESIDENTIAL UNITS
MIX OF STUDIO / 1 BDRM /2 BDRM
1.0 TO 1.75 PER UNIT
= 52 MIN 91 MAX NON-RESIDENTIAL SPACE IS INTENDED FOR USE BY RESIDENTS FOR WORK/LIVE USE. THERE IS NO PARKING SPECIFICALLY RESERVED FOR THE NON-RESIDENTIAL SPACE. SPECIAL CONDITIONS OF APPROVAL

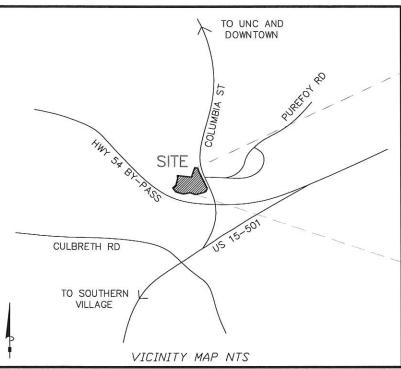

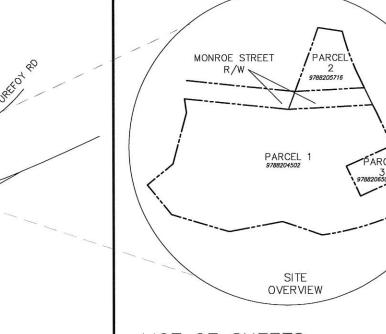

### LIST OF SHEETS

SUP-0.0 COVER SHEET

- PARCELS MUST BE RECOMBINED PRIOR TO ZCP APPROVAL.
- THE BUILDINGS ARE REQUIRED TO BE SPRINKLED.
- LAYOUT IS BASED ON A RIGHT-IN / RIGHT-OUT DRIVEWAY CONFIGURATION.
- THE APPLICANT MUST SUBMIT A CONSTRUCTION MANAGEMENT PLAN FOR APPROVAL BY THE TOWN PRIOR TO ISSUANCE OF A ZONING COMPLIANCE PERMIT.
- THE PROJECT WILL MEET THE TOWN'S 15% AFFORDABLE HOUSING REQUIREMENT. WITH THE PROVISION OF 7 AFFORDABLE UNITS PROVIDED IN THE BUILDING.
- CONTRACTORS MUST COMPLETE THE TOWN'S TREE PROTECTION SEMINAR PRIOR TO TREE PROTECTION FENCE INSTALLATION. CONTACT ADAM NICHOLSON, URBAN FORESTRY, 919-969-5006.
- DEVELOPER WILL BE REQUIRED TO INSTALL ADA RAMPS AND PEDESTRIAN ACTIVATED LED SIGNAL AT THE EVENTUAL SOUTH COLUMBIA STREET CROSSWALK LOCATION IN FRONT OF OR JUST NORTH OF THE PROJECT SITE.
- REVISED S COLUMBIA STREET TRAFFIC COUNTS WILL BE REQUIRED AT ZCP SUBMITTAL.

EXISTING CONDITIONS, TREE SURVEY, DEMOLITION, AND TREE PROTECTION P SITE ANALYSIS TREESAVE PLAN
SITE ANALYSIS
TREESAVE PLAN
SITE PLAN - OVERALL
SITE PLAN - UNDERGROUND PARKING
GRADING PLAN
SITE / RCD SECTIONS
DRIVEWAY/PARKING SECTIONS
STORMWATER MAINTENANCE PLAN
EROSION CONTROL PLAN
UTILITY PLAN
NOT USED
LANDSCAPE AND TREESAVE PLAN
SITE DETAILS
STORMWATER DETAILS
STREAM RESTORATION DETAILS
SITE DETAILS
ELEVATIONS - EAST, WEST
ELEVATIONS - NORTH, SOUTH
ZONING ENVELOPE DIAGRAM

### SZOSTAK

ARCHITECT SZOSTAK DESIGN, INC.



111 West Main Street Durham, N.C. 27701 p 919.682.0368 f 919.688.5646 www.citpa.com

#### COLUMBIA STREET ANNEX

1150 South Columbia Street Chapel Hill. North Carolina

CH HOTEL ASSOCIATES LLC. 3008 ANDERSON DRIVE, SUITE 120 RALEIGH NC 27609



If this drawing is not 24" x 36" it is a reduced print - refer to graphic sca


Date 24 May 18	For Addition of RCD data
20 May 19	Review Comment Revisions
24 Oct 19	Review Comment Revisions
14 Feb 20	Review Comment Revisions
11 May 20	Review Comment Revisions


Drawn By: WLR, MTC Date: 26 April 18


NOT FOR CONSTRUCTION DRAWINGS FOR SPECIAL USE PERMIT SUBMITTAL

COVER


**SUP-0.0** 

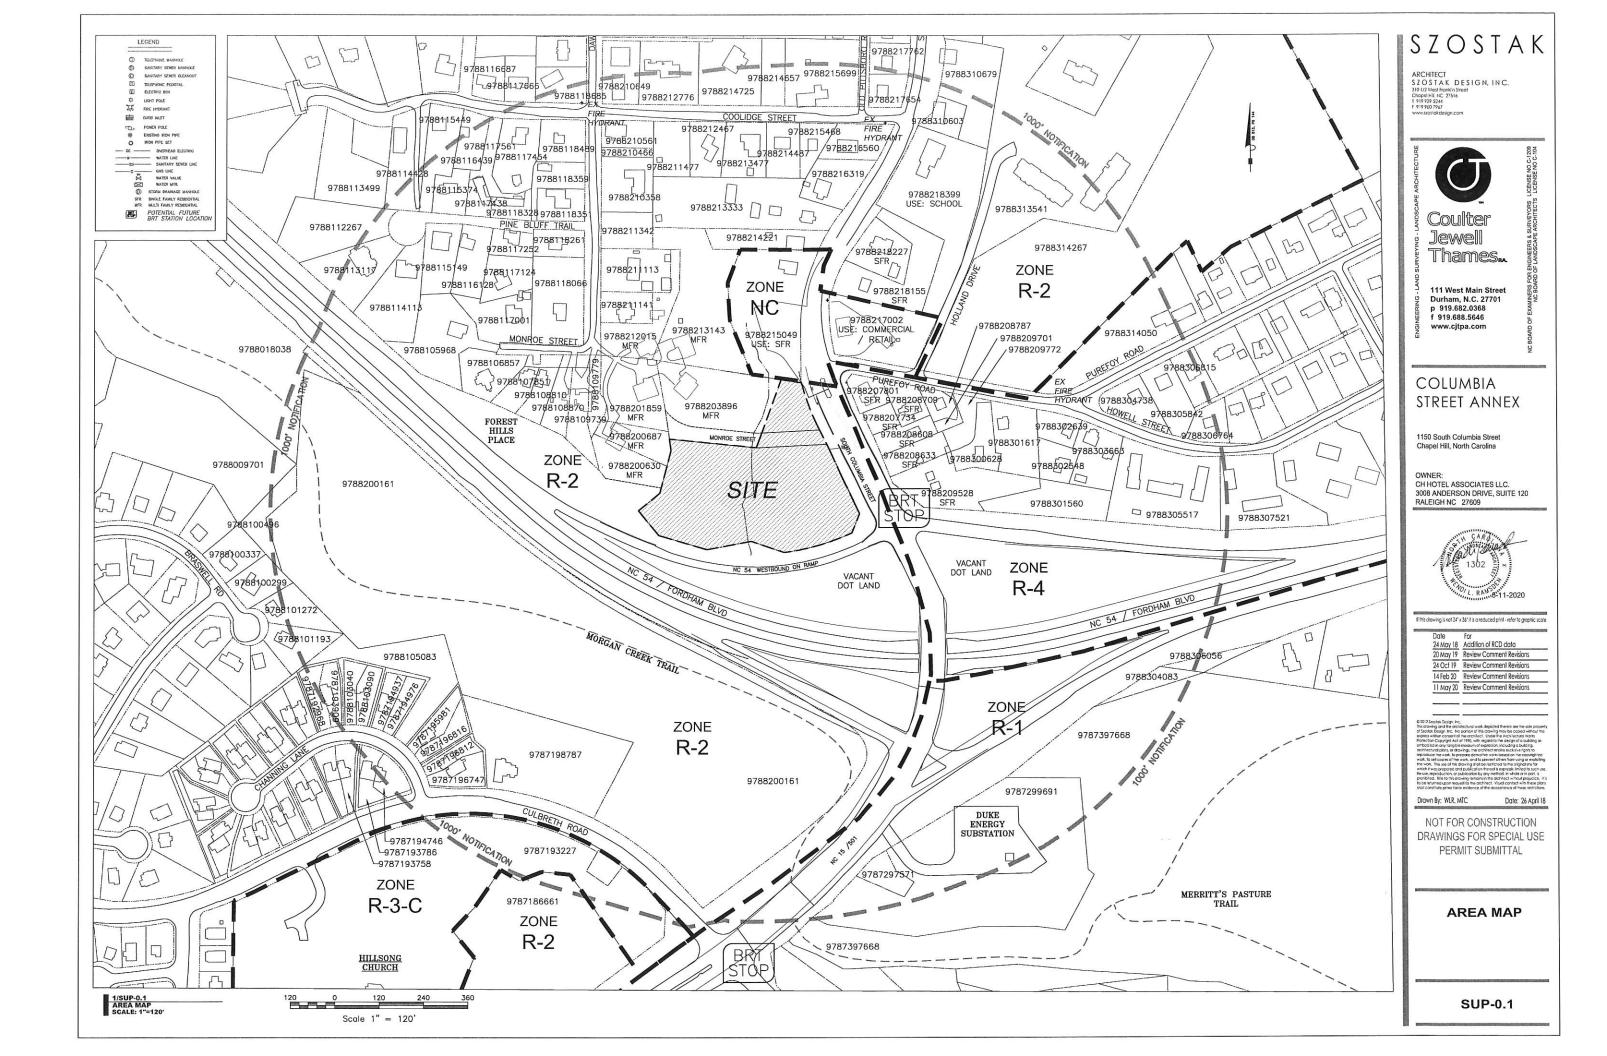

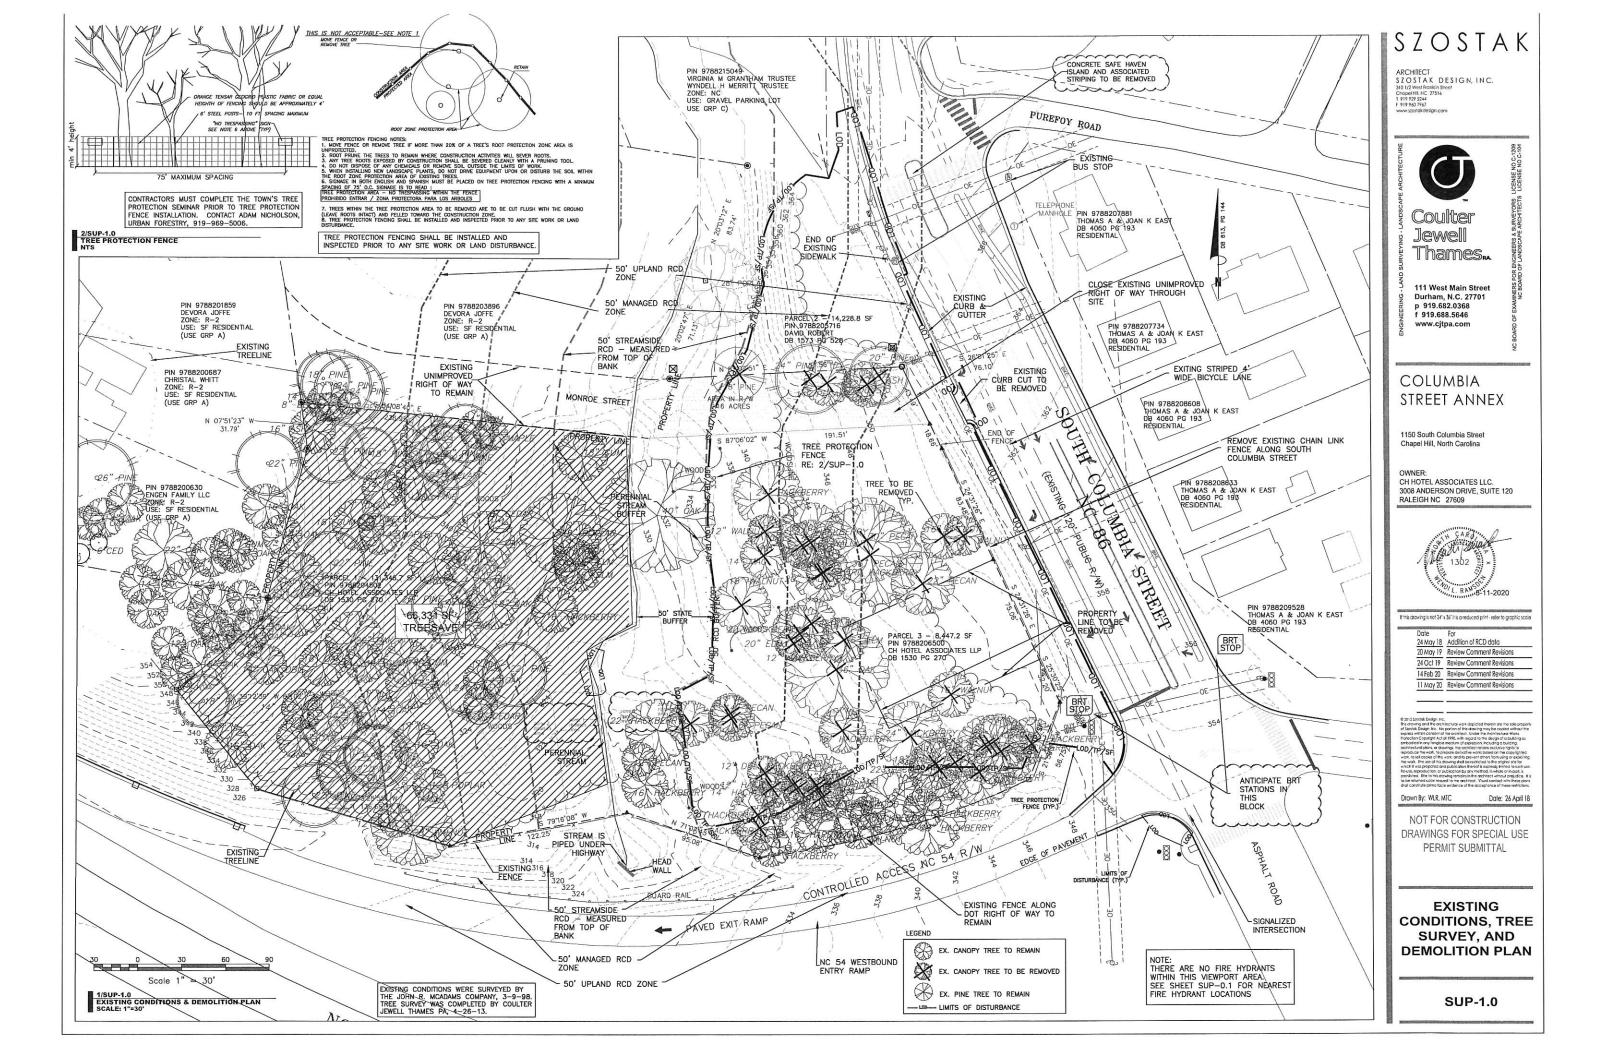

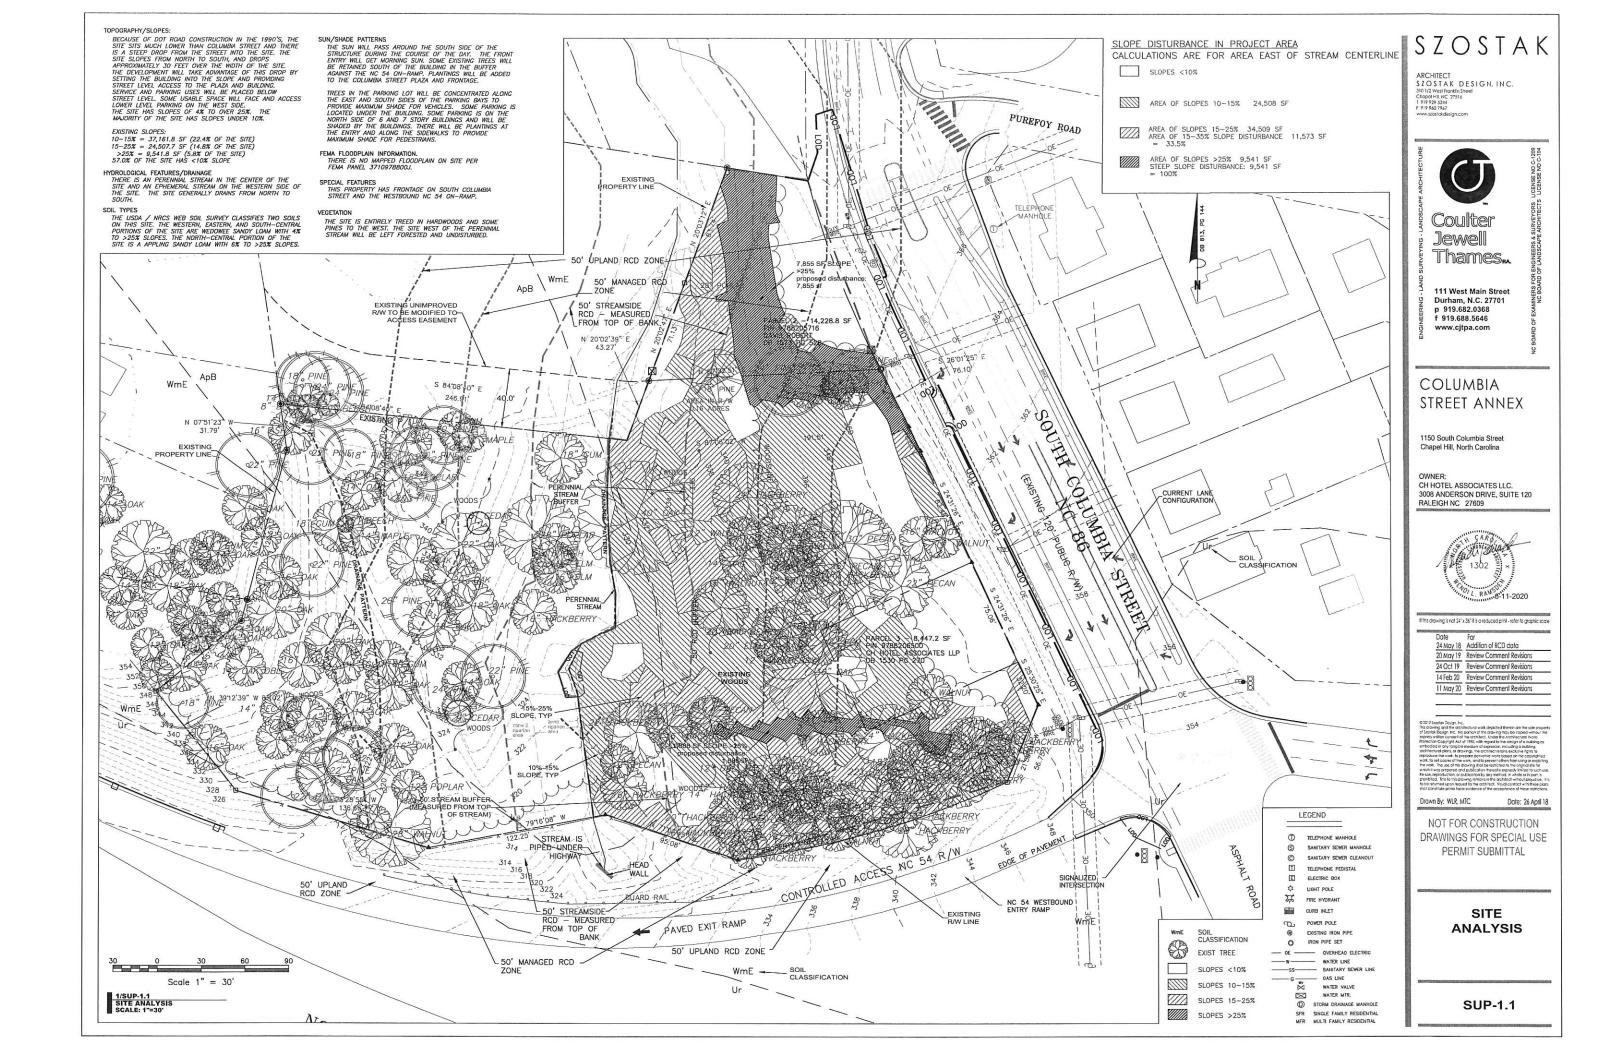



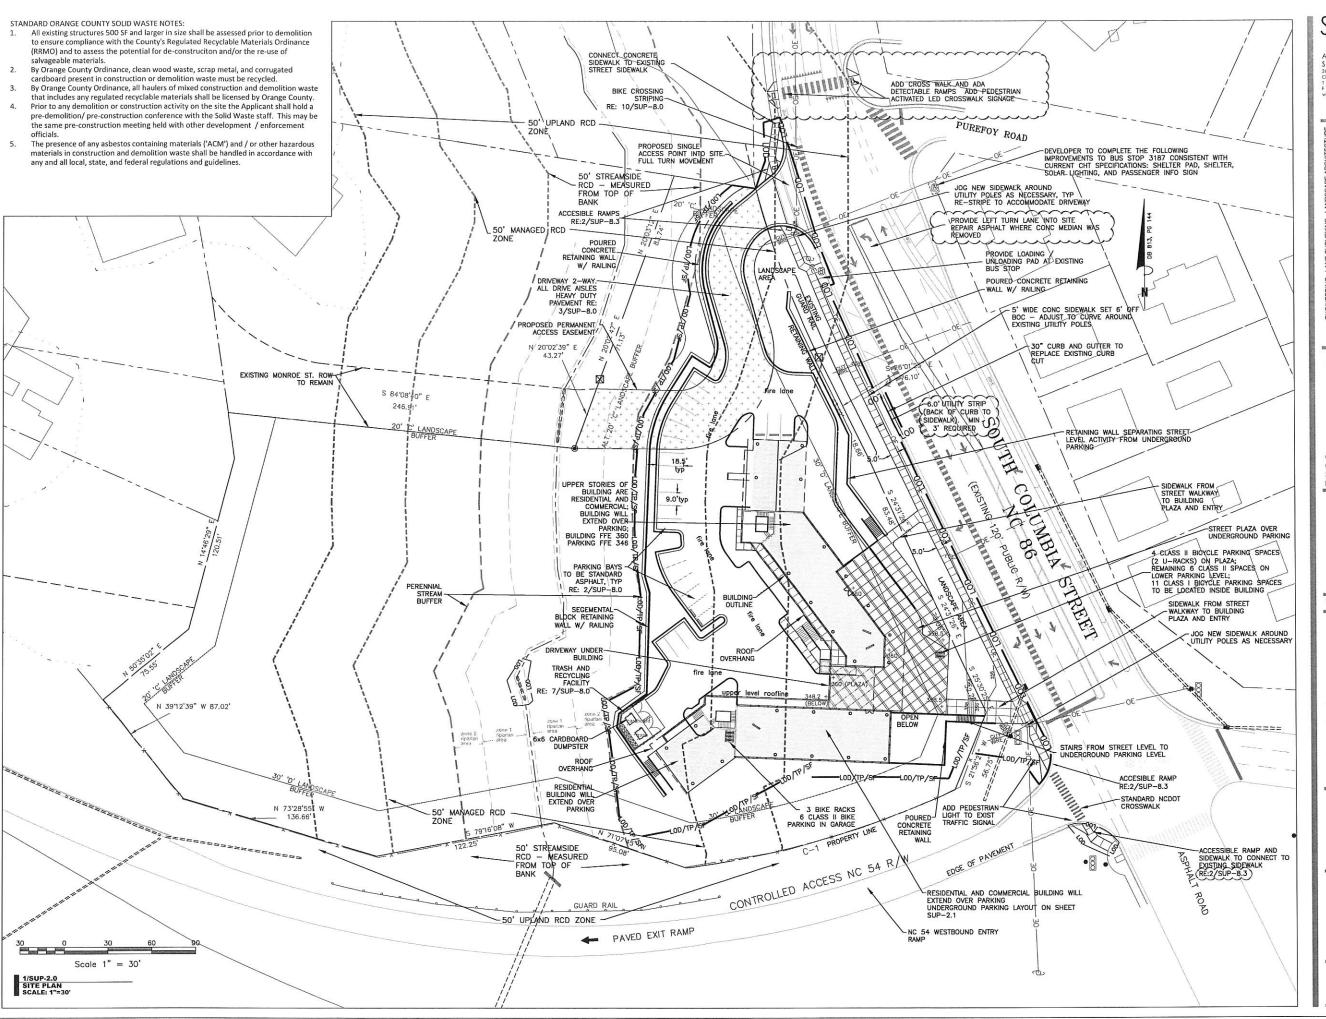

ARCHITECT SZOSTAK DESIGN, INC. 310 1/2 West frankin Street Chapel Hill, NC 27516 1 919 929 5244 F 919 940 7967



111 West Main Street Durham, N.C. 27701 p 919.682.0368 f 919.688.5646 www.cjtpa.com

#### COLUMBIA STREET ANNEX

1150 South Columbia Street Chapel Hill, North Carolina

OWNER: CH HOTEL ASSOCIATES LLC. 3008 ANDERSON DRIVE, SUITE 120 RALEIGH NC 27609



If this drawing is not 24" x 36" it is a reduced print - refer to graphic scale

For	
Addition of RCD data	
Review Comment Revisions	

2012 Szastak Désign, Inc.

anisto Deligi, n.C., No portion d'in disvergi mar les casad without l'exress withins comen of the actritect. Used me Architecture Was section. Designificat et al 1990, with regard to the design of actuding or section designificat et al 1990, with regard to the design of actuding or designification of the designification of the designification of the designification of the designification social to the work. To shape a designification who be add on the captigrighted was. The value of this converging to the established to the adoption also for was. The value of this converging to the established to the action of the was. The value of this converging to the established to the value of the was. The value of this converging to the established to the order of the was. The value of this converging to the established to the converging to the activity of the converging to the


Drawn By: WLR, MTC

NOT FOR CONSTRUCTION DRAWINGS FOR SPECIAL USE PERMIT SUBMITTAL

Date: 26 April 18

OVERALL SITE PLAN STREET LEVEL BUILDING PLAN

SUP-2.0

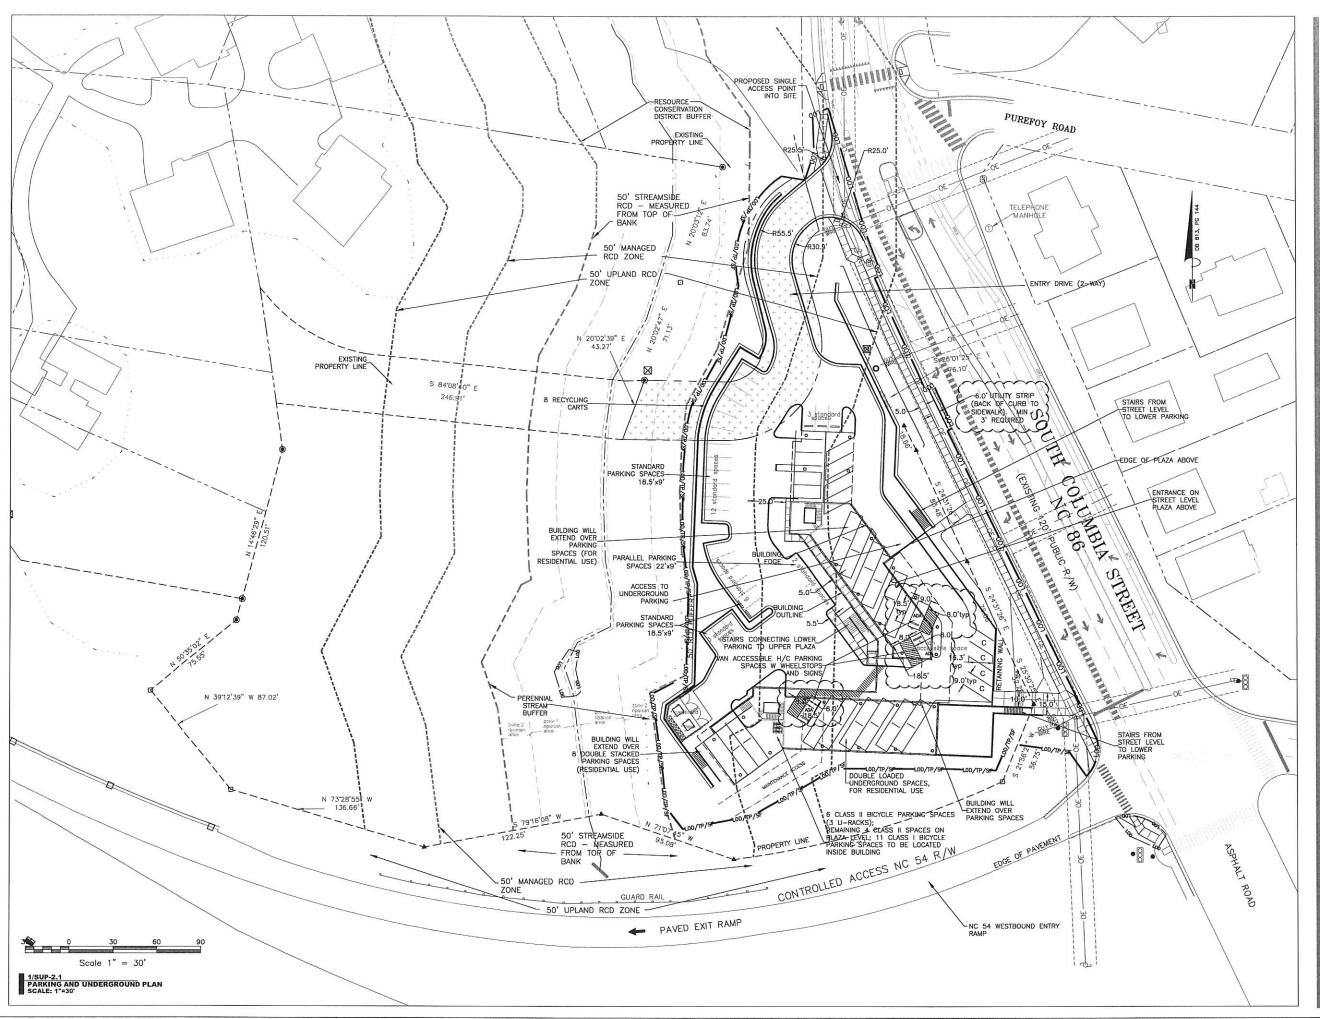

ARCHITECT SZOSTAK DESIGN, INC.



Jewell Thames...

111 West Main Street Durham, N.C. 27701 p 919.682.0368 f 919.688.5646 www.cjtpa.com

COLUMBIA STREET ANNEX

1150 South Columbia Street Chapel Hill, North Carolina

OWNER:

CH HOTEL ASSOCIATES LLC. 3008 ANDERSON DRIVE, SUITE 120 RALEIGH NC 27609



If this drawing is not 24" x 36" it is a reduced print - refer to graphic scale


Date	For	
24 May 18	Addition of RCD data	
20 May 19	Review Comment Revisions	
24 Oct 19	Review Comment Revisions	
14 Feb 20	Review Comment Revisions	
11 May 20	Review Comment Revisions	

Drawn By: WLR, MTC

NOT FOR CONSTRUCTION DRAWINGS FOR SPECIAL USE PERMIT SUBMITTAL

SITE PLAN **UNDERGROUND PARKING** LAYOUT

SUP-2.1

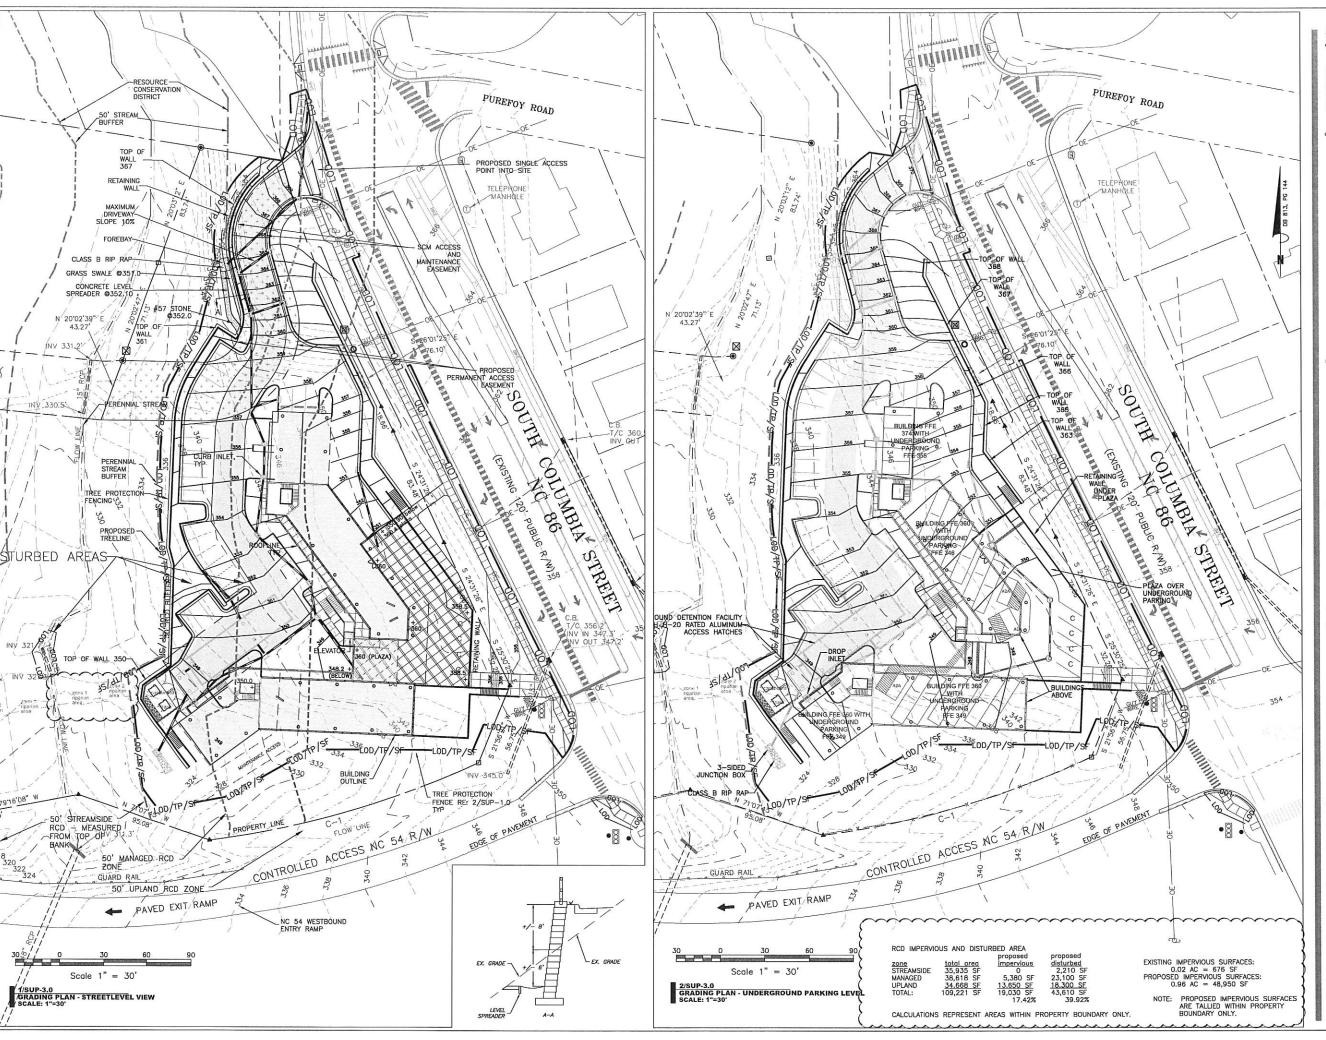

ARCHITECT SZOSTAK DESIGN, INC.



Jewell Thames...

111 West Main Street Durham, N.C. 27701 p 919.682.0368 f 919.688.5646 www.cjtpa.com

#### COLUMBIA STREET ANNEX

1150 South Columbia Street Chapel Hill, North Carolina

OWNER: CH HOTEL ASSOCIATES LLC. 3008 ANDERSON DRIVE, SUITE 120 RALEIGH NC 27609




If this drawing is not 24" x 36" it is a reduced print - refer to graphic scale


Date 24 May 18	For Addition of RCD data
20 May 19	Review Comment Revisions
24 Oct 19	Review Comment Revisions
14 Feb 20	Review Comment Revisions
11 May 20	Review Comment Revisions

Drawn By: WLR, MTC


NOT FOR CONSTRUCTION DRAWINGS FOR SPECIAL USE PERMIT SUBMITTAL

**GRADING, TREE** PROTECTION AND **STORMWATER** PLAN

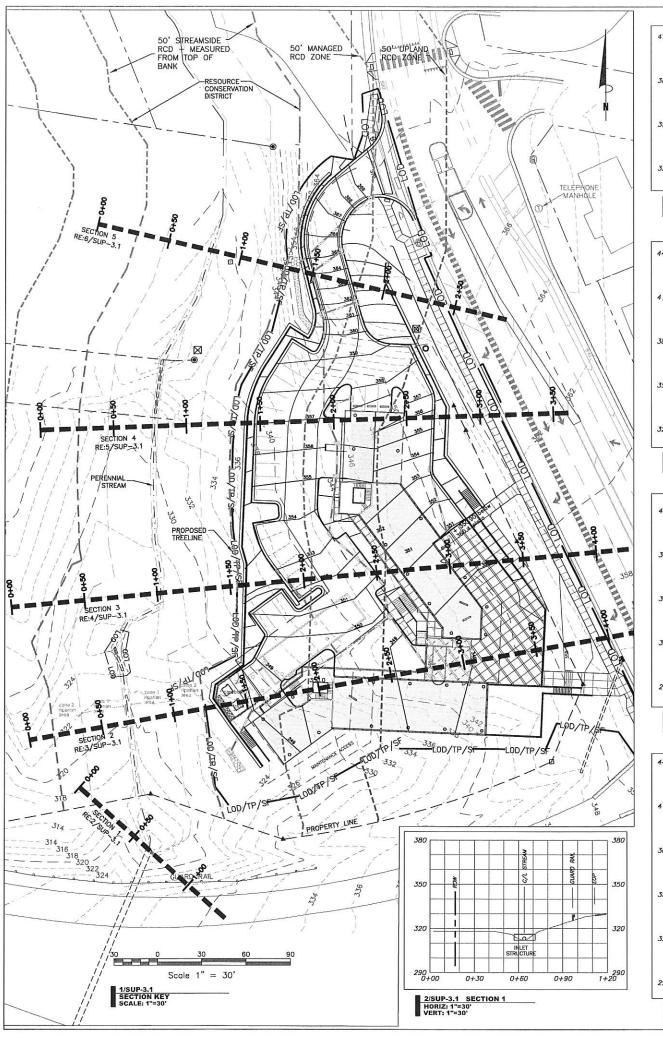


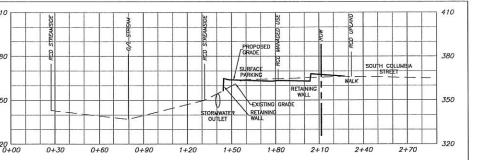


6/SUP-3.1 SECTION 5 HORIZ: 1"=30' VERT: 1"=30'

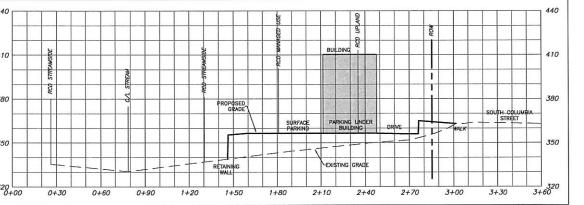

5/SUP-3.1 SECTION 4 HORIZ: 1"=30'

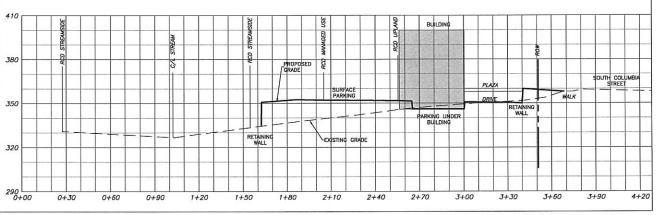

4/SUP-3.1 SECTION 3 HORIZ: 1"=30' VERT: 1"=30'

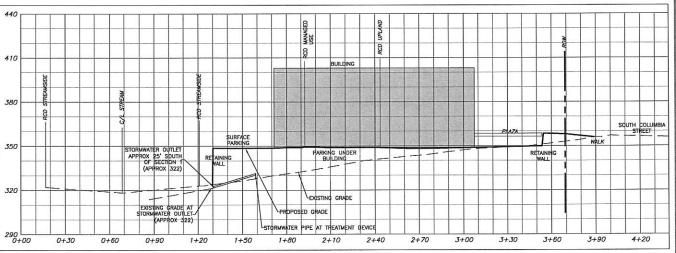

3/SUP-3.1 SECTION 2 HORIZ: 1"=30' VERT: 1"=30'

### SZOSTAK

ARCHITECT SZOSTAK DESIGN, INC. 310 1/2 West Franki'n Street Choppli-17, NC 27516 1 1919 292 542



Coulter Jewell Thames...

111 West Main Street Durham, N.C. 27701 p 919.682.0368 f 919.688.5646 www.cjtpa.com

In Street ... 27701 Sign on Gayon on Ga

#### COLUMBIA STREET ANNEX

1150 South Columbia Street Chapel Hill, North Carolina

OWNER:

CH HOTEL ASSOCIATES LLC. 3008 ANDERSON DRIVE, SUITE 120 RALEIGH NC 27609



If this drawing is not 24" x 36" it is a reduced print - refer to graphic scale

Date 24 May 18	For Addition of RCD data
20 May 19	Review Comment Revisions
24 Oct 19	Review Comment Revisions
14 Feb 20	Review Comment Revisions
11 May 20	Peview Comment Pevisions

6 2012 Southor Design, Inc.


This standing and the cut Medication was disposed therein as the cabe proper file standing and the cut Medication was disposed therein as the cabe proper file standing may be coded without the extreme within comment of the crushed within a measure within comment of the crushed within the Architecture of the Conference of th


Drawn By: WLR, MTC


NOT FOR CONSTRUCTION DRAWINGS FOR SPECIAL USE PERMIT SUBMITTAL

Date: 26 April 18

SITE / RCD SECTIONS

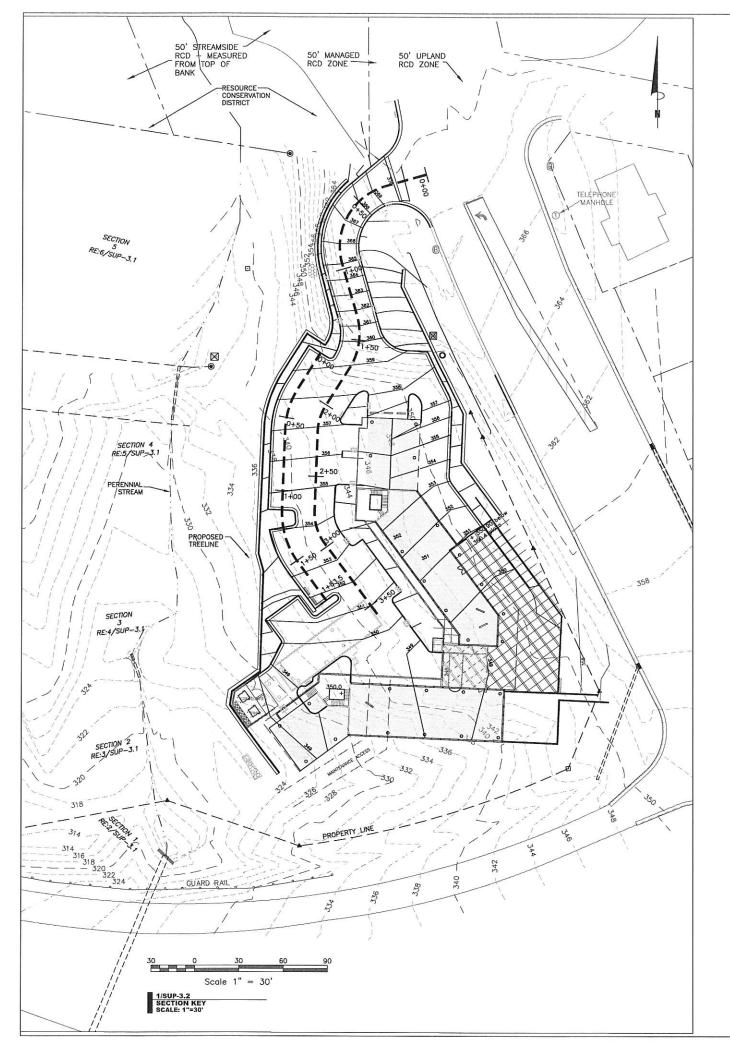

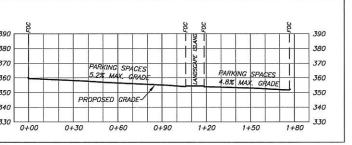

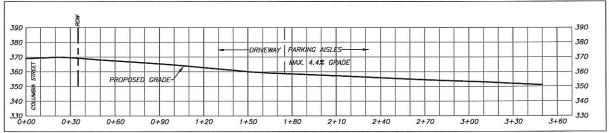

3/SUP-3.2 SECTION 2 HORIZ: 1"=30' VERT: 1"=30'

### SZOSTAK

ARCHITECT SZOSTAK DESIGN, INC.



Jewell Thames

111 West Main Street Durham, N.C. 27701 p 919.682.0368 f 919.688.5646

### COLUMBIA STREET ANNEX

1150 South Columbia Street Chapel Hill, North Carolina

CH HOTEL ASSOCIATES LLC. 3008 ANDERSON DRIVE, SUITE 120 RALEIGH NC 27609




If this drawing is not 24" x 36" it is a reduced print - refer to graphic scale

 Date 24 May 18	For Addition of RCD data
20 May 19	Review Comment Revisions
24 Oct 19	Review Comment Revisions
14 Feb 20	Review Comment Revisions
11 May 20	Review Comment Revisions

NOT FOR CONSTRUCTION DRAWINGS FOR SPECIAL USE PERMIT SUBMITTAL

**DRIVE / PARKING SECTIONS** 

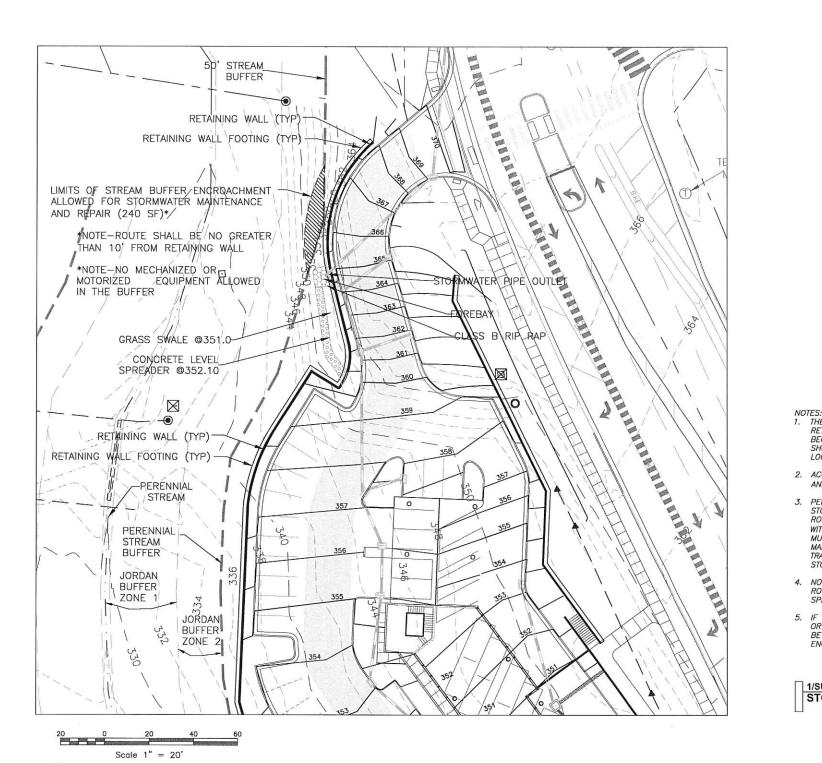

1/SUP-3.3 STORMWATER MAINTENANCE PLAN SCALE: 1"=20"

- NOTES:

  1. THE STORMWATER PIPING OUTLET AND LEVEL SPREADER BEHIND THE RETAINING WALL NEAR THE PROJECT ENTRANCE HAS LIMITED ACCESS BECAUSE OF THE PROTECTIVE STREAM BUFFER IN THIS LOCATION. AS SHOWN ON THE DRAWINGS, THE PIPING AND LEVEL SPREADER ARE NOT LOCATED WITHIN THIS BUFFER.
- 2. ACCESS TO THE PIPING OUTLET AND LEVEL SPREADER FOR MAINTENANCE AND/OR REPAIR IS ALLOWABLE, WITH STRICT LIMITATIONS AS FOLLOWS:
- 3. PERSONNEL WITH HAND OPERATED TOOLS OR EQUIPMENT MAY ACCESS THE STORMWATER PIPING OUTLET AND LEVEL SPREADER ON FOOT ALONG A ROUTE BEHIND THE RETAINING WALL. THE ROUTE SHALL BE LIMITED TO WITHIN 10' OF THE WALL TO AVOID DAMAGE TO THE BUFFER AREA AS MUCH AS POSSIBLE. NO TREES MAY BE REMOVED ALONG THIS ROUTE FOR MAINTENANCE PURPOSES. ANY DISTURBANCE OF THE GROUND BY THIS FOOT TRAFFIC SHALL BE REPAIRED IMMEDIATELY AFTER COMPLETION OF THE STORMWATER MAINTENANCE
- 4. NO MECHANICAL OR MOTORIZED EQUIPMENT IS ALLOWED TO TRAVERSE THIS ROUTE THROUGH THE BUFFER TO ACCESS THE PIPING OUTLET OR LEVEL
- 5. IF MECHANICAL OR MOTORIZED EQUIPMENT IS REQUIRED FOR MAINTENANCE OR REPAIR ACTIVITIES BEHIND THE RETAINING WALL, THE EQUIPMENT SHALL BE LOWERED OVER THE WALL SUCH THAT THE EQUIPMENT DOES NOT ENCROACH INTO THE STREAM BUFFER.

STORMWATER MAINTENANCE PLAN NOTES

### SZOSTAK

ARCHITECT SZOSTAK DESIGN, INC.



Jewell Thames.

111 West Main Street Durham, N.C. 27701 p 919.682.0368 f 919.688.5646

#### COLUMBIA STREET ANNEX

1150 South Columbia Street Chapel Hill, North Carolina

CH HOTEL ASSOCIATES LLC. 3008 ANDERSON DRIVE, SUITE 120 RALEIGH NC 27609




If this drawing is not 24" x 36" it is a reduced print -refer to graphic scale

-	Date	For
	24 May 18	Addition of RCD data
	20 May 19	Review Comment Revisions
	24 Oct 19	Review Comment Revisions
	14 Feb 20	Review Comment Revisions
	11 May 20	Review Comment Revisions

Drawn By: WLR, MTC

NOT FOR CONSTRUCTION DRAWINGS FOR SPECIAL USE PERMIT SUBMITTAL

**STORMWATER MAINTENANCE PLAN** 

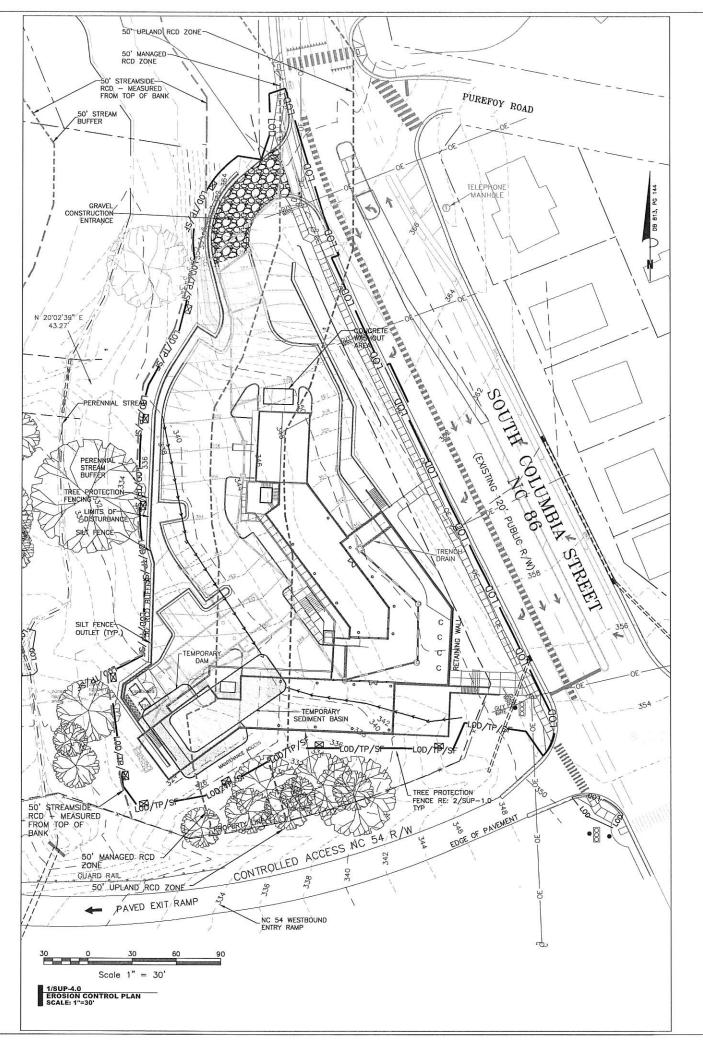

INSTALL SILT FENCE PRIOR TO WORK IN ANY AREA TO PREVENT SILT FROM LEAVING SITE.

ALL STORMWATER PIPING SHALL BE PROTECTED FROM FLOW UNTIL STABILIZATION IS ACHIEVED. PROTECTION SHALL BE INSTALLED AT THE END OF CONSTRUCTION EACH WORK DAY AND AT ANY TIME RAIN EVENTS CAUSE FLOW INTO OPEN TRENCH, PER DETAILS.

ALL STORMWATER STRUCTURES SHALL BE PROTECTED FROM INFLOW UNTIL STABILIZATION IS ACHIEVED USING EITHER STAKED HARDWARE CLOTH OR SILT SACKS, PER DETAILS.

4. CONSTRUCTION ENTRANCES SHOWN ARE IN SUGGESTED LOCATIONS.
CONSTRUCTION ENTRANCES SHALL BE INSTALLED AND MAINTAINED SUCH THAT NO CONSTRUCTION TRAFFIC MAY LEAVE THE SITE WITHOUT PASSING OVER THE ENTRANCE DEVICE.

#### 2/SUP-4.0 EROSION CONTROL NOTES

- 1. INSTALL ALL TREE PROTECTION FENCING REQUIRED.
- OBTAIN ALL APPROVALS AND PERMITS NECESSARY TO BEGIN AND COMPLETE.
  THE PROJECT. THE APPROVALS AND PERMITS MUST BE OBTAINED BEFORE
  THE DISTURBANCE BEGINS SO THAT WORK WILL NOT BE INTERRUPTED OR
  DELATED.
- SCHEDULE AND HOLD A PRE-CONSTRUCTION CONFERENCE TO DISCUSS EROSION CONTROL PLAN AND SCHEDULE WITH THE OWNER OR OWNER'S REPRESENTATIVE, GROUNG CONTROLOR, AND EROSION CONTROL PERSONN BEFORE STARTING ANY DEMOLITION, TIMBERING, GRUBBING, CLEARING, OR GRADING ACTIVITIES.
- 4. CLEAR ONLY THE AREA NECESSARY TO GAIN ACCESS TO AND INSTALL THE INITIAL ERGISION CONTROL DEVICES: THE CONSTRUCTION ENTRANCE, SILT FENCE AND OUTLETS, DIVERSION DIFORES, ARCH FILTERS, AND CHECK DAMS. ALL DITCHES ARE TO BE SEEDED AND MULCHED IMMEDIATELY AFTER THEY ARE INSTALLED.
- CLEAR AND GRADE THE REMAINDER OF THE SITE. INSTALL STORM DRAINS AND OTHER UTILITIES.
- 6. INSTALL TEMPORARY INLET PROTECTION AND RIP RAP APRONS AS SOON AS POSSIBLE AFTER PIPE HAS BEEN INSTALLED AND DRIVINGES STRUCTURES HAVE BEEN INSTALLED AND BACKFILED. ENSURE THAT UPSTREAM ERROSON CONTROL DEVICES ARE IN PROPER WORKING ORDER TO PREVENT RIP RAP APRONS FROM BECOMING CLOGGED WITH SILT.
- 7. INSTALL CURB AND GUTTER, PAVEMENT BASE, AND PAVEMENT. REMOVE TEMPORARY INLET PROTECTION AND INSTALL SILT SACKS IN INLETS.
- INSPECT AND MAINTAIN THE SEDIMENT CONTROL DEVICES SO THEY CONTINUE TO FUNCTION PROPERLY. THE PERSON RESPONSIBLE FOR EROSION CONTROL MILL OVERSEE THE INSPECTING AND MAINTENANCE OF FIRES DEVICES MEASURES SHOULD BE INSPECTED WEEKLY AND AFTER A RAINFALL OF MORE THAN 0.5 INCHES. SEDIMENT TO BE REMOVED FROM TRAPS WHEN EDIMENT DEPTH IS ONE HALF OF THE TOTAL DEPTH OF TRAP. EROSION CONTROL DEVICES SHALL BE REPLACED WHEN DAMAGED OR DO NOT APPEAR TO BE WORKING PROPERLY,
- IF IT IS DETERMINED DURING THE COURSE OF CONSTRUCTION THAT SIGNIFICANT SEDIMENT IS LEAVING THE PROJECT SITE DESPITE PROPER IMPLEMENTATION AND MAINTEANCE OF THE EXOSION CONTROL PLAN, THE PERSON RESPONSIBLE FOR THE LAND DISTURBING ACTIVITY IS OBLIGATED TO TAKE ADDITIONAL PROTECTIVE ACTION.
- 10. KEEP MUD, DUST, AND DEBRIS OFF THE PUBLIC STREET AT ALL TIMES. IF MUD OR DEBRIS IS TRACKED FROM THE STE, USE A SHOVEL AND BROOM TO REMOVE IT MIMEDIATELY. IF MUD, DUSTS, AND DEBRIS ARE NOT KEPT OFF THE STREET, ENFORCEMENT ACTION (REVOKING THE GRADING PERMIT AND/OR
- 11. SILT FENCE AND DIVERSION DITCHES ARE TO BE RELOCATED AS NECESSARY AS GRADING PROGRESSES TO ENSURE THAT NO SEDIMENT LEAVES THE SITE AND RUNOFF ENTERS THE SEDIMENT BASIN.
- 12. SEEDING AND RESTABILIZATION OF DISTURBED AREAS MUST BE ACCOMPUSHED FOR THE PLANS AND SPECIFICATIONS WITHIN THE TIMEFRAMES GIVEN IN THE STABILIZATION THE TABLE PROVIDED IN THE SEEDING SCHEDULE. CONTRACTOR IS RESPONSIBLE FOR TEMPORARY SEEDING THAT IS REQUIRED DURING THE PROJECT AT NO ADDITIONAL COST TO THE OWNER.
- 13. WHEN CONSTRUCTION IS COMPLETED, ALL TEMPORARY EROSION CONTROL DEVICES MUST BE REMOVED AFTER THE DRAINAGE AREA HAS BEEN SUFFICIENTLY STABILIZED TO RESTRAIN EROSION. REMOVE AND PROPERLY DISPOSE OF ACCUMULATED SEDIMENT AND DEBRIS FROM THE DEVICES AND STABILIZE THE LOCATIONS.
- 14. ARRANGE A FINAL INSPECTION WITH THE EROSION CONTROL INSPECTOR TO CONFIRM THAT ALL THE REQUIREMENTS OF THE APPROVED EROSION CONTROL PLAN HAVE BEEN COMPLETE
- 15. SANDFILTERS ARE NOT TO RECEIVE RUNOFF FROM THE SITE UNTIL ALL EROSION AND SEDIMENT PHASES ARE COMPLETED, ALL INLETS TO SANDFILTERS SHALL REMAIN SEALED UNTIL SITE IS COMPLETELY STABILIZED.

3/SUP-4.0 CONSTRUCTION SEQUENCE

Site Area Description	Stabilization Time Frame	Stabilization Time Frame Exceptions	
Perimeter dikes, swales, ditches, and slopes	7 days	None	
High Quality Water (HQW) Zones	7 days	None	7-DAY STABILIZATION AREAS INCLUDE:
Slopes steeper than 3:1	7 days	None	SWALES 1 - 6 ALL AREAS BETWEEN LIMITS OF
Slopes 3:1 or flatter	7 days	None	DISTURBANCE AND WALL 3  ALL AREAS BETWEEN LIMITS OF
All other areas with slopes flatter than 4:1	7 days	None	DISTURBANCE AND STORM LINE FROM MH1 TO MH3

### SZOSTAK

ARCHITECT SZOSTAK DESIGN, INC.



Jewell Thames...

111 West Main Street Durham, N.C. 27701 p 919.682.0368 f 919.688.5646 www.citpa.com

#### COLUMBIA STREET ANNEX

1150 South Columbia Street Chapel Hill, North Carolina

OWNER. CH HOTEL ASSOCIATES LLC. 3008 ANDERSON DRIVE, SUITE 120 RALEIGH NC 27609



If this drawing is not 24" x 36" it is a reduced print - refer to graphic scale

Date 24 May 18	For Addition of RCD data
20 May 19	Review Comment Revisions
24 Oct 19	Review Comment Revisions
14 Feb 20	Review Comment Revisions
11 May 20	Review Comment Revisions


Drawn By: WLR, MTC

NOT FOR CONSTRUCTION DRAWINGS FOR SPECIAL USE PERMIT SUBMITTAL

> **EROSION** CONTROL PLAN

> > SUP-4.0

NOTE: EROSION CONTROL MEASURES SHOWN ARE THE MINIMUM REQUIRED. CONTRACTOR SHALL INSTALL ADDITIONAL MEASURES AS MAY BE MEASURES AS MAY BE
NECESSARY TO PREVENT
SEDIMENT FROM LEAVING THE
SITE OR ENTERING THE
EXISTING AND PROPOSED STORMWATER BMP'S. ANY REQUIRED SEDIMENT REMOVAL SHALL BE THE RESPONSIBILITY OF THE

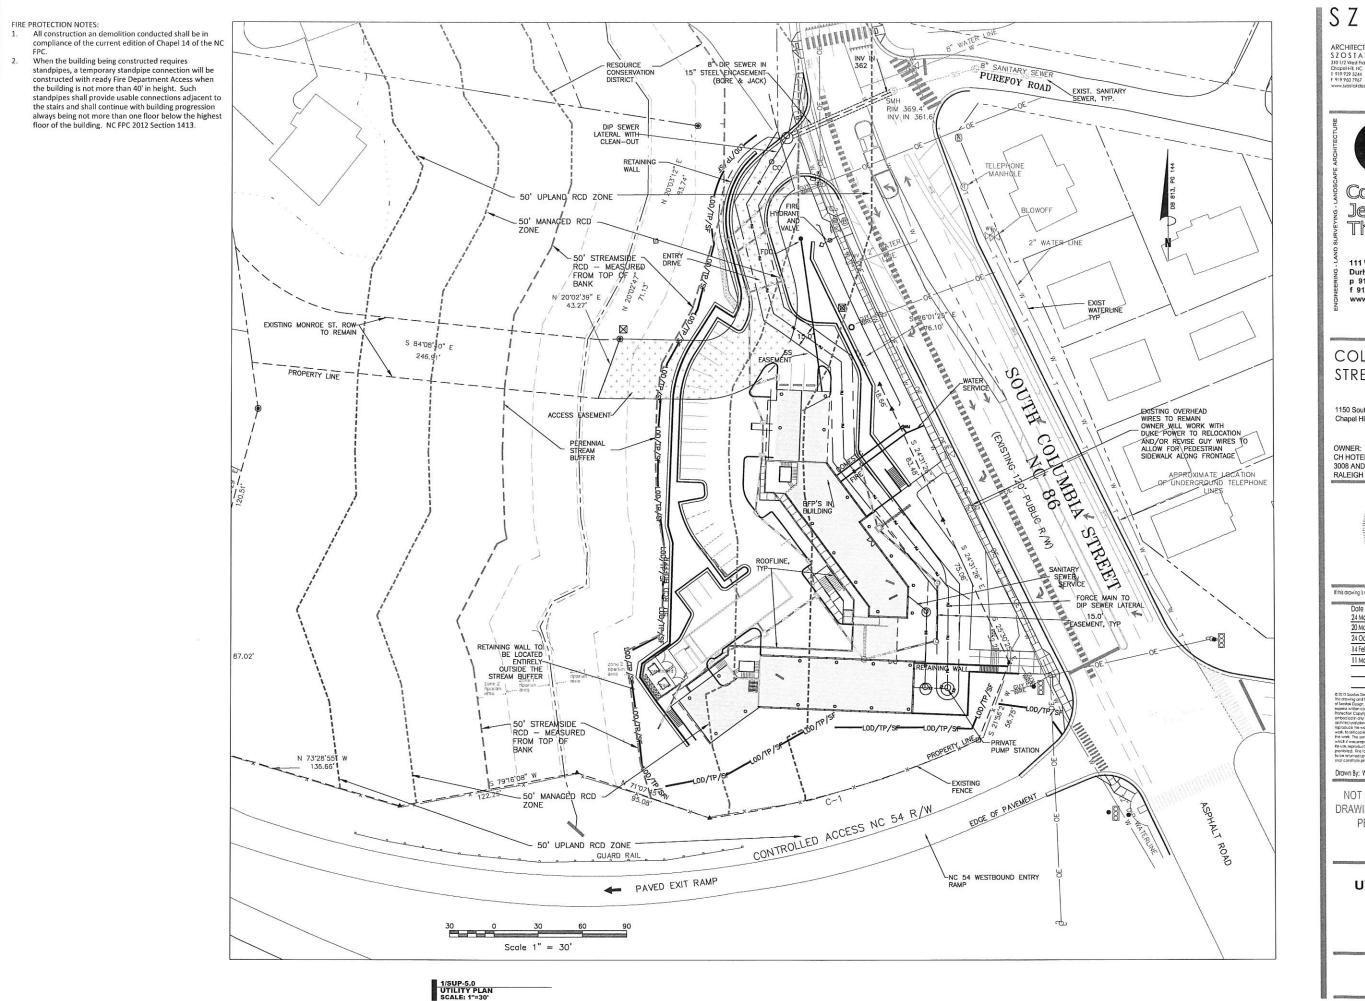

ARCHITECT \$ Z O \$ T A K D E \$ I G N, I N C. 310 1/2 West Frankin Street Chapal HB, NC 27516 1 919 929 5244



Coulter Jewell Thames...

111 West Main Street Durham, N.C. 27701 p 919.682.0368 f 919.688.5646 www.cjtpa.com

#### COLUMBIA STREET ANNEX

1150 South Columbia Street Chapel Hill, North Carolina

CH HOTEL ASSOCIATES LLC. 3008 ANDERSON DRIVE, SUITE 120 RALEIGH NC 27609



nis drawing is not 24" x 36" it is a reduced print-refer to graphic scale

Date	For
24 May 18	Addition of RCD data
20 May 19	Review Comment Revisions
24 Oct 19	Review Comment Revisions
14 Feb 20	Review Comment Revisions
11 May 20	Review Comment Revisions

2 Sastax Derign, Inc.

Tanking and the accidenction work depicted them has the sale proper

to be page, Inc. No promote the convengment becaused whose in

the Copyright Act of 1992, with agent to the seeing of a culturing a

tion Copyright Act of 1992, with agent to the seeing of a culturing a

tion of the copyright Act of 1992, with agent to the seeing of a culturing a

tion of any trappier action of experience that act of the copyright of

the copyright act of the copyright act of the copyright act of

to the copyright act of the copyright act of the copyright act of

the sale of the copyright act of the copyright act of

the copyright act of the copyright act of

the copyright act of the copyright act of

the copyright act of the copyright act of

the copyright act of the copyright act of

the copyright act of the copyright act of

the copyright act of the copyright act of

the copyright act of the copyright act of

the copyright act of

the copyright act of

the copyright


Drawn By: WLR, MTC

NOT FOR CONSTRUCTION DRAWINGS FOR SPECIAL USE PERMIT SUBMITTAL

Date: 26 April 18

**UTILITY PLAN** 

SUP-5.0

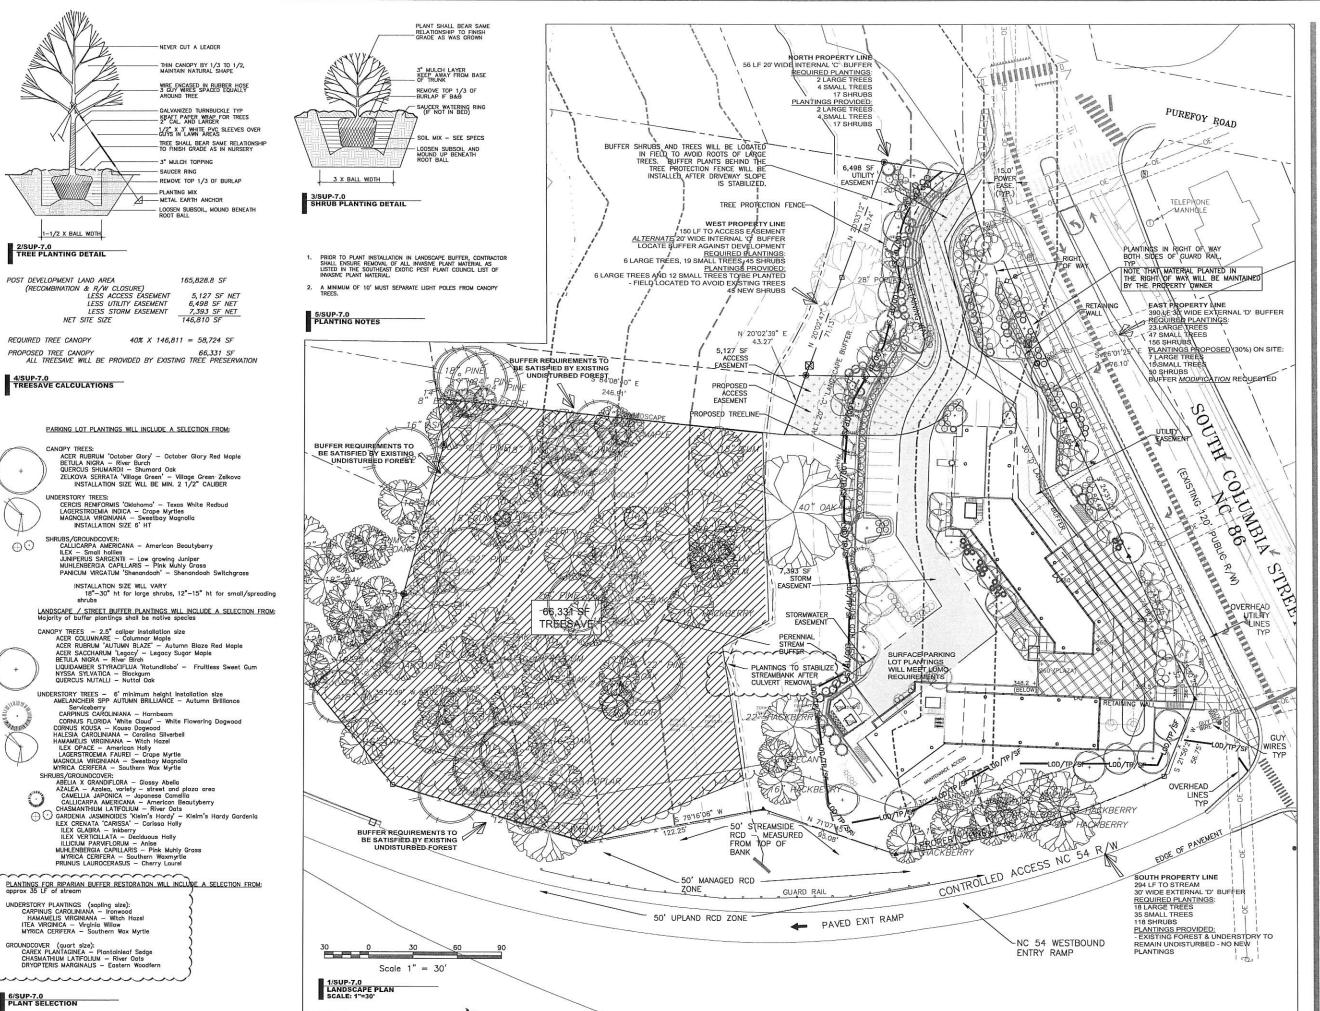

ARCHITECT SZOSTAK DESIGN, INC.



Jewell Thames...

111 West Main Street Durham, N.C. 27701 p 919.682.0368 f 919.688.5646 www.cjtpa.com

#### COLUMBIA STREET ANNEX

1150 South Columbia Street Chapel Hill, North Carolina

CH HOTEL ASSOCIATES LLC. 3008 ANDERSON DRIVE, SUITE 120 RALFIGH NC 27609



ris crawing is not 24" x 36" it is a reduced print - refer to graphic scale

24 May 18 Addition of RCD data 20 May 19 Review Comment Revisions 24 Oct 19 Review Comment Revisions 14 Feb 20 Review Comment Revisions 11 May 20 Review Comment Revisions

Drawn By: WLR, MTC Date: 26 April 18

NOT FOR CONSTRUCTION DRAWINGS FOR SPECIAL USE PERMIT SUBMITTAL

mmm

**LANDSCAPE** AND **TREESAVE PLAN** 

SUP-7.0

-CONTRACTION JOINTS SHALL BE SPACED AT 10 FOOT INTERVALS. EXCEPT THAT A 15 FOOT SPACING MAY BE USED WHEN A MACHINE IS USED OR WHEN SATISFACTORY SUPPORT FOR THE FACE FORM CAN BE OBTAINED WITHOUT THE USE OF TEMPLATES AT 10 FOOT INTERVALS. JOINT SPACING MAY BE ALTERED BY THE EVIDENCE TO PREVENT UNCONTROLLED CRACKING. -CONTRACTION JOINTS MAY BE INSTALLED BY THE USE OF TEMPLATES OR FORMED BY OTHER APPROVED METHODS. WHERE SUCH JOINTS ARE NOT FORMED BY TEMPLATES, A MINIMILM DEPTH OF 1 1/2" SHALL BE MAINTAINED. -ALL CONTRACTION JOINTS SHALL BE FILLED WITH JOINT FILLER. -JOINTS SHALL BE MAINTAINED. -LOWER SUPPLAY. -CYPANSION JOINTS SHALL BE SPACED AT 90 FOOT INTERVALS AND ADJACENT TO ALL RIGID OBJECTS.

FINISHED GRADE

BACKFILL

ADJACENT PAVEMENT

CAST-IN-PLACE CONCRETE
3000 PSI


STONE BASE MATERIAL

COMPACTED SUBGRADE

6- 6- 18- ON SITE
24- IN ROW

24- CURB AND GUTTER IN ROW
24- CURB AND GUTTER IN SIDE SITE

1/SUP-8.0
24" CONCRETE CURB & GUTTER
NTS

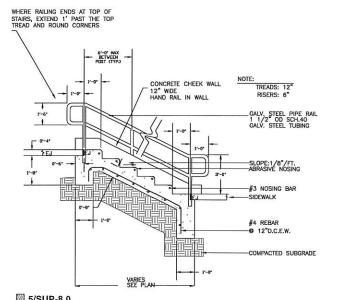

CARDBOARD DUMPSTER

MASONRY SCREEN

WALL

26'


CONCRETE PAVING

CANE BOLT LATCH HOLE, TYP

STEEL PIPE
BOLLARD


TYPICAL EXTERIOR STAIR AND RAILING

7/SUP-8.0 DUMPSTER ENCLOSURE

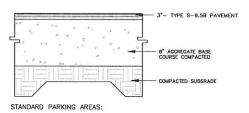


FINAL PAVEMENT SECTION WILL BE PROVIDED BY GEO-TECHNICAL ENGINEER BASED SITE SPECIFIC GEO-TECHNICAL REPORT

2/SUP-8.0 STANDARD ASPHALT PAVING - PARKING BAYS

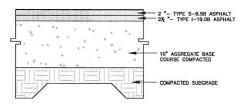

3/SUP-8.0
HEAVY DUTY ASPHALT PAVING - DRIVE AISLES

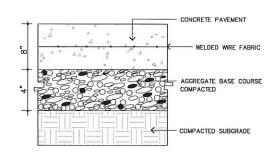


NOTES

1. ALL CONCRETE TO 4000 PSI, PROPERLY AIR ENTRAINED FOR EXTERIOR GRADE CONCRETE MIXES.


2. CABC BASE AND SOIL SUBGRADE TO BE COMPACTED TO 98% OF THE ASTM D-698 STD. PROCTOR MDD AND PROOFROLLED AND APPROVED BY GEOTECHNICAL PERSONNEL.

## DUMPSTER PAD CONCRETE PAVING NTS

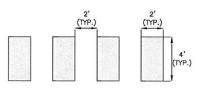


NOTES: MARKINGS TO BE MADE FROM THRMOPLASTIC AND HIGH VISIBILITY GREEN IN COLOR.

8/SUP-8.0
BIKE LANE STRIPING
NTS

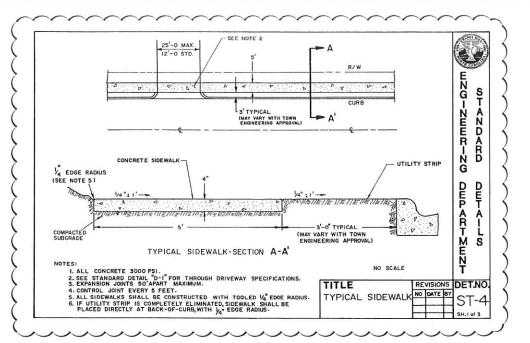

4/SUP-8.0
CONCRETE SIDEWALK

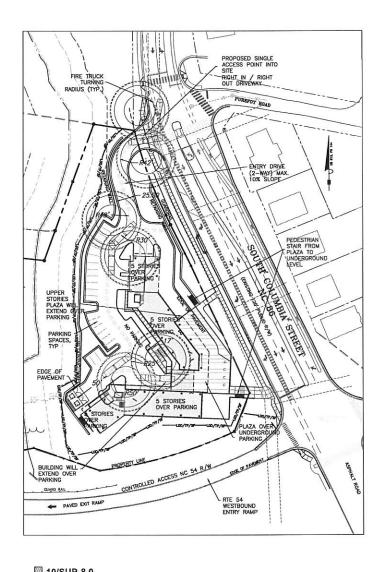

FIRE LANE ACCESS / SOLID WASTE PICKUP ACCESS
SCALE: 1"=60"

### SZOSTAK

ARCHITECT
SZOSTAK DESIGN, INC.
310 1/2 West Frankin Street
Chappel Hi, INC 27516
1 919 929 5244
5 919 947 7847



Coulter Jewell Thames...

111 West Main Street Durham, N.C. 27701 p 919.682.0368 f 919.688.5646 www.cjtpa.com

FOR BOARD OF EXAMINERS FOR ENGINEE NC BOARD OF EXAMINERS FOR ENGINEER PORTUGE FOR THE PARTIES OF LANDERS FOR ENGINEER PORTUGE FOR THE PARTIES FOR ENGINEER FOR ENGINEER PORTUGE FOR THE PARTIES FOR ENGINEER FOR ENGINEER FOR ENGINEER PORTUGE FOR THE PARTIES FOR ENGINEER FOR ENGI

#### COLUMBIA STREET ANNEX

1150 South Columbia Street Chapel Hill, North Carolina

OWNER:
CH HOTEL ASSOCIATES LLC.
3008 ANDERSON DRIVE, SUITE 120
RALEIGH NC 27609



If this drawing is not 24" x 36" it is greduced print-refer to graphic scale

Date 24 May 18	For Addition of RCD data
20 May 19	Review Comment Revisions
24 Oct 19	Review Comment Revisions
14 Feb 20	Review Comment Revisions
11 May 20	Review Comment Revisions


2 Stostak Design, Inc. rawing and the architectural

of Section Despite to the provision of the desired makes are under setting and the provision of the provisio


Drawn By: WLR, MTC

NOT FOR CONSTRUCTION DRAWINGS FOR SPECIAL USE PERMIT SUBMITTAL

> SITE DETAILS

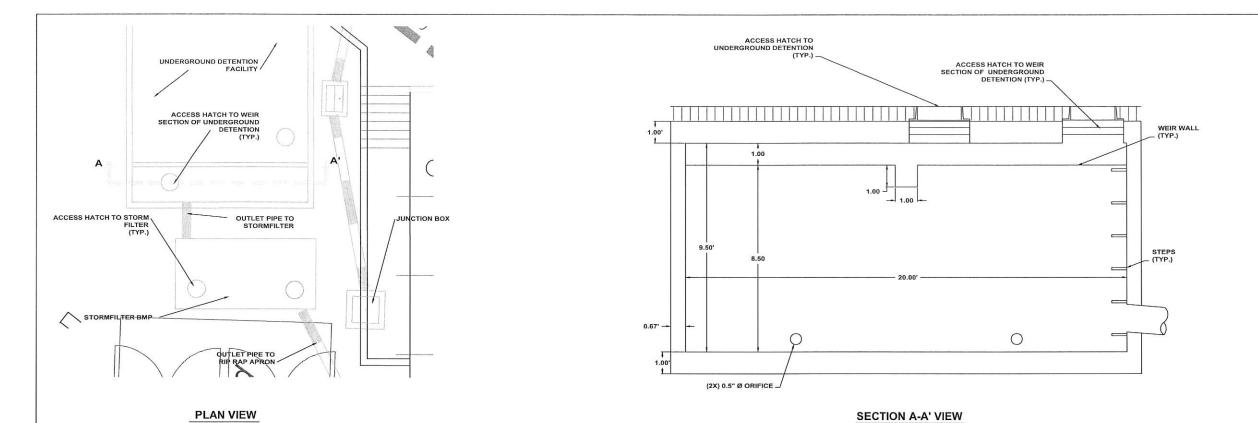

1/SUP-8.1
UNDERGROUND DETENTION FACILITY
SECTION

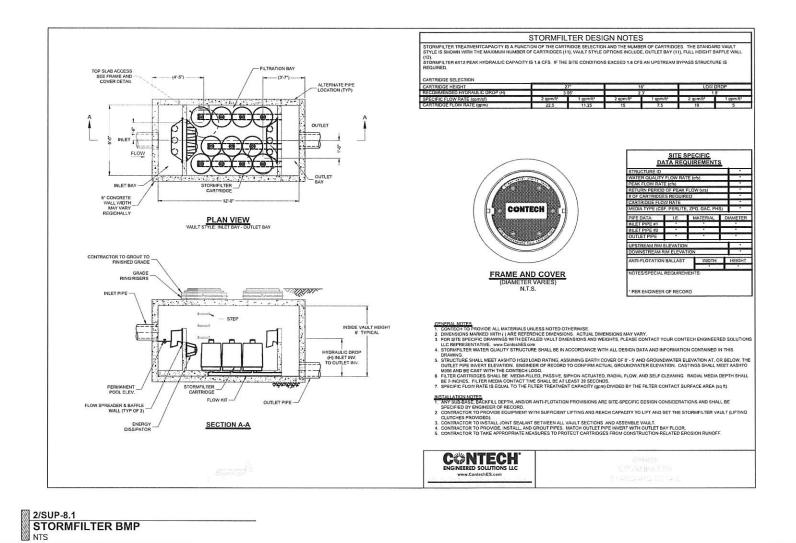

ARCHITECT SZOSTAK DESIGN, INC. 310 1/2 West Frankin Street Chapel Hi, NC 27516 1 919 929 5244 F 919 960 7967



Coulter Jewell Thames...

111 West Main Street Durham, N.C. 27701 p 919.682.0368 f 919.688.5646 www.cjtpa.com

#### COLUMBIA STREET ANNEX

1150 South Columbia Street Chapel Hill, North Carolina

OWNER: CH HOTEL ASSOCIATES LLC. 3008 ANDERSON DRIVE, SUITE 120 RALEIGH NC 27609



If this drawing is not 24" x 36" it is a reduced print - refer to graphic scale


. seeme	Date 24 May 18	For Addition of RCD data
	20 May 19	Review Comment Revisions
	24 Oct 19	Review Comment Revisions
	14 Feb 20	Review Comment Revisions
	11 May 20	Review Comment Revisions

6 707 Salasia Delign, Inc.
Not making a light and properties of the proper

Drawn By: WLR, MTC

NOT FOR CONSTRUCTION DRAWINGS FOR SPECIAL USE PERMIT SUBMITTAL

STORMWATER DETAILS

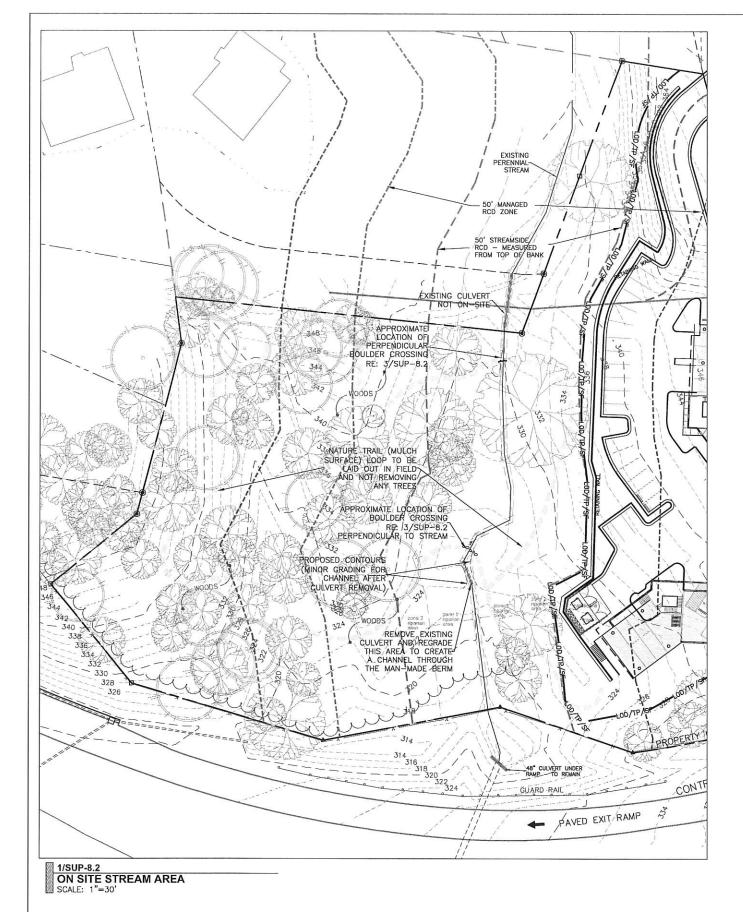

- STREAM AREA PROPOSED WORK:


  1. REMOVE TRASH FROM THE STREAM AND STREAMSIDE RCD AREA

  2. REMOVE INVASIVE PLANT MATERIAL FROM THE STREAMSIDE RCD AREA

  3. REMOVE CULVERT AND REGRADE TO ALLOW STREAM COUNTY TO BE THE STREAMS TO STREAM STREAMS TO STREAMS TO STREAM STREAMS TO STREAM STREAMS TO STREAMS TO STREAM STREAMS TO STREAMS T
- FLOW THROUGH EXISTING BERM

  4. PLANT SEDGE PLUGS INTO THE DISTURBED AREA
  NEAR THE CULVERT REMOVAL TO STABILIZE THE
  DISTURBED AREA.
- 5. CREATE A MULCH SURFACE NATURE TRAIL INCLUDING TWO STREAM CROSSINGS OF STRATEGICALLY PLACED BOULDERS

SUMMARY OF WORK TO BE DONE IN STREAM AREA

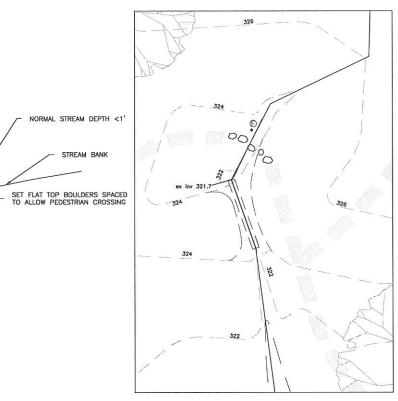

PLAN VIEW

ON SITE STREAM CROSSING
SCALE: 1"=10'

12"-24" SPACING-

CROSS SECTION AT STONE CROSSING

### SZOSTAK

ARCHITECT SZOSTAK DESIGN, INC.



Jewell Thames...

111 West Main Street Durham, N.C. 27701 p 919.682.0368 f 919.688.5646 www.cjtpa.com

#### COLUMBIA STREET ANNEX

1150 South Columbia Street Chapel Hill, North Carolina

OWNER: CH HOTEL ASSOCIATES LLC. 3008 ANDERSON DRIVE, SUITE 120




If this drawing is not 24" x 36" it is a reduced print - refer to graphic scale

 Date 24 May 18	For Addition of RCD data
20 May 19	Review Comment Revisions
24 Oct 19	Review Comment Revisions
14 Feb 20	Review Comment Revisions
11 May 20	Review Comment Revisions


Drawn By: WLR, MTC

NOT FOR CONSTRUCTION DRAWINGS FOR SPECIAL USE PERMIT SUBMITTAL


> STREAM RESTORATION **DETAILS**

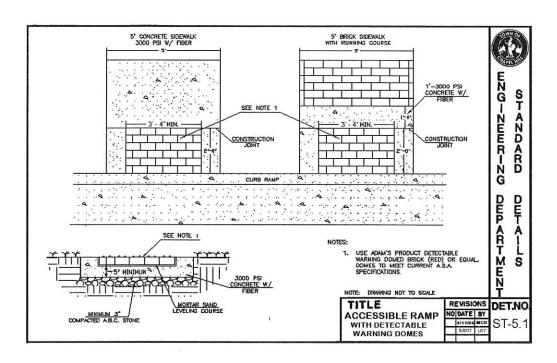

ACCESSIBLE RAMP

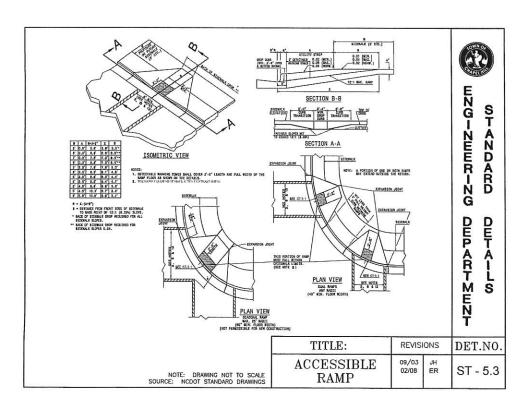

3/SUP-8.3 ACCESSIBLE RAMP

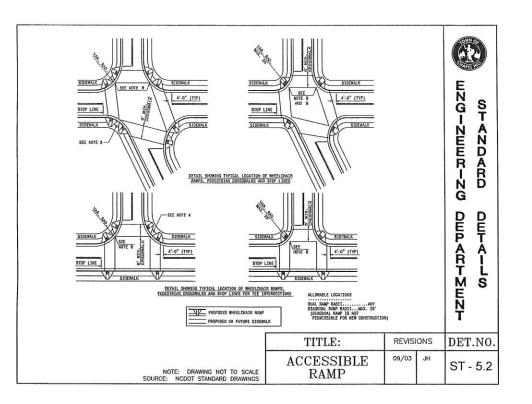

2/SUP-8.3 ACCESSIBLE RAMP

#### NOTES:

- 1. CONSTRUCT THE WALKING SURFACE WITH SLIP RESISTANCE AND A 70% CONTRASTING COLOR TO THE SIDEWALK.
- 2. CROSSWALK WIDTHS AND CONFIGURATION MAY VARY BUT MUST CONFORM TO TRAFFIC DESIGN STANDAR
- 3. PROVIDE WHEELCHAIR RAMPS AT LOCATIONS AS SHOWN ON THE PLANS OR AS DIRECTED BY THE ENGINEER. LOCATE WHEELCHAIR RAMPS AS DIRECTED BY THE ENGINEER WHERE EXISTING LIGHT POLES, RIPE HYDRAMIS, DROP INLETS, ETC. AFFECT PLACEMENT. WHERE TWO RAMPS ARE INSTALLED, PLACE NOT LESS THAN TWO FEET OF PULL HEIGHT CURB BETWEEN THE RAMPS. PLACE DUAL RAMPS AS PERPENDICULAR TO THE TRAVEL LANE BEING CROSSED AS POSSIBLE.
- 4. DO NOT EXCEED 0.08 (12:1) SLOPE ON THE WHEELCHAIR RAMP IN RELATIONSHIP TO THE GRADE OF THE STREET.
- 5. CONSTRUCT WHEELCHAIR RAMPS 40" (3'-4") OR GREATER FOR DUAL RAMPS AND 60" (5'-0") OR GREATER FOR DIAGONAL RAMPS.
- 6. USE CONCRETE WITH A SIDEWALK FINISH IN ORDER TO OBTAIN A ROUGH NON-SKID TYPE SURFACE.
- 7. PLACE A 1/2" EXPANSION JOINT WHERE THE CONCRETE WHEELCHAIR RAMP JOINS THE CURB AS SHOWN ON DETAIL ST-5A.

  B. PLACE THE INSIDE REDISTRIAN CROSSINAL LINES NO CLOSED IN THE INTERESCENCY BY DISCOUNT THE INTERESCENCY BANK
- WITH ALLOWANCE OF A 4' CLEAR ZONE IN THE VEHICULAR TRAVELWAY WHEN ONE RAMP IS INSTALLED. (SEE NOTE 13)
- COORDINATE THE CURB CUT AND THE PEDESTRIAN CROSSWALK LINES SO THE FLOOR OF THE WHEELCHAIR RAMP WILL FALL WITHIN THE PEDESTRIAN CROSSWALK LINES. PLACE DIAGONAL RAMPS WITH FLARED SIDES SO 24° OF FULL HEIGHT CURB FALLS WITHIN THE CROSSWALK MARKINGS ON EACH SIDE OF THE FLARES.
- 10. CONSTRUCT THE PEDESTRIAN CROSSWALK A MINIMUM OF 6 FEET. A CROSSWALK WIDTH OF 8 FEET OR GREATER IS DESIRABLE
- 11. USE STOP LINES, NORMALLY PERPENDICULAR TO THE LANE LINES, WHERE IT IS IMPORTANT TO INDICATE THE POINT BEHIND WHICH VEHICLES ARE REQUIRED TO STOP IN COMPLIANCE WITH A TRAFFIC SIGNAL, STOP SIGN OR OTHER LEGAL REQUIREMENT. AN UNUSUAL APPROACH SKEW MAY REQUIRE THE PLACEMENT OF THE STOP LINE TO BE PARALE TO THE INTERSECTION ROADWAY.
- 12. TERMINATE PARKING A MINIMUM OF 20 FEET BACK OF PEDESTRIAN CROSSWALK.
- 13. PLACE ALL PAYEMENT MARKINGS IN ACCORDANCE WITH THE LATEST EDITION OF THE MANUAL OF UNIFORM TRAFFIC CONTROL DEVICES (MUTCD) PUBLISHED BY THE FEDERAL HIGHWAY ADMINISTRATION AND THE NORTH CAROLINA SUPPLEMENT TO THE MUTCD.

SOURCE: NCDOT STANDARD DRAWINGS

TITLE:	REVISIONS		DET.NO.
ACCESSIBLE RAMP	09/03	JH	ST - 5.4

G-ZWWK-ZG

D D E

-ZEZT

S

S

A

D

4/SUP-8.3
ACCESSIBLE RAMP NOTES

### ISZOSTAK

ARCHITECT SZOSTAK DESIGN, INC. 310 1/2 West Fronkin Street Chappel HJL NC 27516 1919 993 244 F 919 960 7967



Coulter Jewell Thames...

111 West Main Street Durham, N.C. 27701 p 919.682.0368 f 919.688.5646 www.citpa.com

# COLUMBIA

STREET ANNEX

1150 South Columbia Street Chapel Hill, North Carolina

CH HOTEL ASSOCIATES LLC. 3008 ANDERSON DRIVE, SUITE 120 RALEIGH NC 27609



If this drawing is not 24" x 36" it is a reduced print - refer to graphic so

Signature (C	Date	For
	24 May 18	Addition of RCD data
	20 May 19	Review Comment Revisions
	24 Oct 19	Review Comment Revisions
	14 Feb 20	Review Comment Revisions
	11 May 20	Review Comment Revisions

DOUS Load beging to.

But storage and the special count of against filter in an the last round put the throat put of the storage and the special count of storage to, the spoon of the storage round to against self-count of the special count of the special count

Drawn By: WLR, MTC

NOT FOR CONSTRUCTION DRAWINGS FOR SPECIAL USE PERMIT SUBMITTAL

Date: 26 April 18

SITE DETAILS

